

UNITED STATES AGENCY FOR INTERNATIONAL DEVELOPMENT



THE HASHEMITE KINGDOM OF JORDAN THE H MINISTRY OF PUPLIC WORKS & HOUSING

SCHOOLS FOR A KNOWLEDGE ECONOMY PROJECT (USAID SKEP)

Tender Documents Vol. IV / Drawings - Rev. 0 Phase III - Package 1 (1/2020/USAID/SKEP/3/1)

BOOK OF DETAILS

Date: JUNE 2020





THE HASHEMITE KINGDOM OF JORDAN MINISTRY OF EDUCATION

ABBREVIATIONS

* BUILDING DETAILS							
VERTICAL WALL SECTIONS							
HORIZONTAL WALL SECTIONS							
INTERNAL STAIRS DETAILS	ST						
EXPANSION JOINT DETAILS	EXP						
MISCELLANEOUS DETAILS	MCD						
* SITE WORKS DETAILS							
LANDSCAPING DETAILS	LSD						
* DOORS AND WINDOWS	DETAILS						
DOORS DETAILS	DRD						
WINDOWS DETAILS	WD						
WINDOWS DETAILS	WD						
* SCHOOL COMPONENTS							



REV. DATE





BOOK OF DETAILS

DRAWING NAME:	Design:	Drawn:	REVISION No. :
	H.B.	Engicon	0
	Checked:	Approved:	SHEET NUMBER:
ABBREVIATIONS	M.Sh.	S.B.	
	Date:	SCALE :	G-000
	June 2020	-	

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	GENERAL			BUILDING DETAILS		MCD-19	ACOUSTIC SYSTEMS IN DEAF CLASSROOMS / WALL INSTALLATION	AS SHOWN 0		DOORS AND WIND	ows		SCHOOL COMPONE	ENTS
	COVER	- 0	VWS.	VERTICAL WALL SECTIONS		MCD-20	ACOUSTIC SYSTEMS IN MULTI-PURPOSE HALL / WALL INSTALLATION	AS SHOWN 0		RD. DOORS DETAILS		FFD.	FIXED FURNITURE DETAILS	
G-000	ABBREVIATIONS	- 0	VWS-01	EXTERNAL WALLS AT GROUND FLOOR LEVEL WITHOUT OPENING	iS 1:10 0	MCD-21	FLAG POLE AT ROOF	1:10 0	DRI	D-01 DOORS DETAILS NOTES	AS SHOWN	FFD-01	TYPICAL CLASSROOM (GRADES 1-3)- ENLARGED PLAN	AS SHOWN
G-001	LIST OF DRAWINGS	- 0	VWS-02	EXTERNAL WALLS AT GROUND FLOOR LEVEL WITH OPENINGS	1:10 0	MCD-22	RUBBER MAT- RECESSED TYPE UNDER INDOOR DRINKING FOUNTAIN / COOLER	AS SHOWN 0	DRI	D-02 SLIDING STEEL DOOR DETAILS	1:25	FFD-02	TYPICAL CLASSROOM (GRADES 1-3)- INTERNAL ELEVATION	NS 1:50
G-002	COLOR SCHEME- EXTERNAL FINISHES	- 0	VWS-03	EXTERNAL WALLS BETWEEN FLOORS	1:10 0	MCD-23	RAIL PROTECTION MAIN STUDENTS SCHOOL GATE	AS SHOWN 0	DRI	D-03 SLIDING STEEL DOOR DETAILS	AS SHOWN	FFD-03	TYPICAL CLASSROOM (GRADES 4-12)- ENLARGED PLAN	AS SHOWN
G-003	COLOR SCHEME- INTERNAL FINISHES	- 0	VWS-04	TYPICAL PARAPET DETAILS	AS SHOWN 0				DRI	D-04 STEEL DOORS DETAILS	AS SHOWN	FFD-04	TYPICAL CLASSROOM (GRADES 4-12)- INTERNAL ELEVATIO	DNS 1:50
G-004	COLOR SCHEME- INTERNAL FINISHES		VWS-05	INTERNAL WALLS	1:10 0		SITE WORKS DETA	ILS	DRI	D-05 STEEL DOORS DETAILS	1:2	FFD-05	TYPICAL COMPUTER LAB- PLAN	1:50
			VWS-06	INTERNAL TOILETS WALLS	1:10 0	LSD.	LANDSCAPE DETAILS		DRI	D-05A STEEL DOORS DETAILS	1:2	FFD-06	TYPICAL COMPUTER LAB- INTERNAL ELEVATIONS	1:50
			VWS-07	TILING/SKIRTING AT LIBRARY & DOOR OPENING AT ROOF LEVEL	AS SHOWN 0	LSD-01	TYPICAL SITE DETAILS	1:10 0	DRI	D-06 STEEL DOORS DETAILS	AS SHOWN	FFD-07	TYPICAL COMPUTER LAB- TEACHER DESK	1:25
			VWS-08	PLATFORM DETAILS AT MULTI-PURPOSE HALL	AS SHOWN 0	LSD-02	TYPICAL SITE DETAILS	1:10 0	DRI	D-07 STEEL DOORS DETAILS	1:20	FFD-08	TYPICAL COMPUTER LAB- STUDENT COMPUTER STATION	1:25
			VWS-09	INTERNAL WALLS CLADDING	AS SHOWN 0	LSD-03	TYPICAL SITE DETAILS	1:10 0	DRI	D-08 STEEL DOORS DETAILS	1:2	FFD-09	TYPICAL COMPUTER LAB- PRINTER COUNTER	1:25
						LSD-04	TYPICAL SITE DETAILS	1:10 0	DRI	D-09 STEEL DOORS DETAILS	AS SHOWN	FFD-10	TYPICAL TEACHERS' CENTER- ENLARGED PLAN	1:50
			HWS.	HORIZONTAL WALL SECTIONS		LSD-05	TYPICAL SITE DETAILS	1:10 0	DRI	D-10 ALUMINUM DOORS DETAILS	AS SHOWN	FFD-11	TYPICAL TEACHERS' CENTER- TEACHER WORKSTATION	1:25
			HWS-01	EXTERNAL WALLS WITHOUT OPENINGS	1:10 0				DRI		1:25	FFD-12	TYPICAL KITCHENETTE CABINETS DETAILS	1:10
			HWS-02	INTERNAL WALLS	1:10 0	LSD-06	TYPICAL SITE DETAILS	1:10 0		D-12 STEEL DOOR AT WATER TANK	AS SHOWN	FFD-13	TYPICAL KITCHENETTE CABINETS DETAILS	1:10
			HWS-02 HWS-03	REINFORCED CONCRETE WALLS	1:10 0	LSD-07	EXTERNAL STAIR DETAILS	1:10 0		D-12 STEEL DOOR AT WATER TANK D-13 WOODEN DOOR DETAIL		FFD-13	TYPICAL SCIENCE LAB- TEACHER DEMO, TABLE	
			HWS-03 HWS-04	EXTERNAL WALLS WITH OPENINGS	1:10 0	LSD-08	TYPICAL SITE DETAILS	1:10 0		D-13 WOODEN DOOR DETAIL D-14 WOODEN DOOR DETAIL	1:25	FFD-14 FFD-15	TYPICAL SCIENCE LAB- TEACHER DEMO. TABLE	1:25
			HWS-04		1:10 0	LSD-09	TYPICAL SITE DETAILS	1:10 0			1:2			
						LSD-10	DISABLED RAMP DETAILS	AS SHOWN 0		D-15 WOODEN DOOR DETAIL	1:2	FFD-15A	TYPICAL SCIENCE LAB- HC STUDENTS' TABLE	1:25
			STR.	INTERNAL STAIRS DETAILS		LSD-11	DISABLED RAMP DETAILS	AS SHOWN 0		D-16 WOODEN DOOR DETAIL	1:2	FFD-16	TYPICAL SCIENCE LAB- EMERGENCY SHOWER	1:25
			STR-01	HIGH STEEL BALUSTRADES BETWEEN STAIR FLIGHTS	AS SHOWN 0	LSD-12	TYPICAL SITE DETAILS	1:10 0	DRI	D-17 WOODEN DOOR DETAIL	AS SHOWN	FFD-17	TYPICAL SCIENCE LAB- FUME HOOD	1:25
			STR-02	STAIRS WITH WALL MOUNTED STEEL BALUSTRADES	AS SHOWN 0	LSD-13	TYPICAL SITE DETAILS	1:10 0		D-18 WOODEN DOOR DETAIL	AS SHOWN	FFD-18	TYPICAL SCIENCE LAB- PREP. AREA	1:25
			STR-03	HIGH STEEL BALUSTRADES WITHIN STAIR FLIGHT	AS SHOWN 0	LSD-14	TYPICAL SITE DETAILS	1:10 0	DRI	D-19 WOODEN SWING DOOR JAMB DETAILS	AS SHOWN	FFD-19	TYPICAL VOCATIONAL WORKSHOP- STUDENT WORK TABLE	E 1:25
						LSD-15	TYPICAL SITE DETAILS	1:10 0				FFD-19A	TYPICAL VOCATIONAL WORKSHOP-HC STUDENT WORK TAR	BLE 1:25
			EXP.	EXPANSION JOINT DETAILS		LSD-16	TYPICAL SITE DETAILS	1:10 0	W	D. WINDOWS DETAILS		FFD-20	TYPICAL VOCATIONAL WORKSHOP- COUNTER/ CABINETS	1:25
			EXP-01	ROOF EXPANSION JOINT	1:10 0	LSD-17	RAIN WATER TRENCH	1:10 0	WD	-01 GENERAL NOTES ALUMINUM DOORS & WINDOWS	AS SHOWN	FFD-21	TYPICAL ART ROOM- STUDENT WORK TABLE	1:25
			EXP-02	INTERNAL EXPANSION JOINT	1:2 0	LSD-18	WEEP HOLES DETAILS	AS SHOWN 0	WD	-02 ALUMINUM WINDOWS DETAIL	AS SHOWN	FFD-21A	TYPICAL ART ROOM- HC STUDENT WORK TABLE	1:25
			EXP-03	ROOF EXPANSION JOINT - 7.5cm THICKNESS	1:10 0	LSD-19	BOUNDARY WALL DETAILS	1:25 0	WD	-03 ALUMINUM WINDOWS DETAIL	AS SHOWN	FFD-22	TYPICAL ART ROOM- COUNTER/ CABINETS	1:25
			EXP-04	INTERNAL EXPANSION JOINT - 7.5CM THICKNESS	1:2 0	LSD-20	FLAG POLE DETAILS	AS SHOWN 0	WD	-04 ALUMINUM WINDOWS DETAIL	AS SHOWN			
				·		LSD-21	STONE BENCH DETAILS	1:10 0	WD	-05 ALUMINUM WINDOWS DETAIL	AS SHOWN	WAD.	WET AREAS DETAILS	
			MCD.	MISCELLANEOUS DETAILS		LSD-22	WOODEN BENCH TYPE (1) DETAIL	1:10 0	WD	-06 ALUMINUM WINDOWS DETAIL	AS SHOWN	WAD-01	TYPICAL STAFF/PUBLIC TOILET- WASH BASIN DETAILS	1:25
			MCD-01	TYPICAL ROOF SHAFT DETAIL	1:10 0	LSD-23	WOODEN BENCH TYPE (2) DETAIL	1:10 0	WD	-07 STEEL LOUVER WINDOWS DETAIL	AS SHOWN	WAD-02	TYPICAL STAFF/PUBLIC TOILET- WESTERN WC DETAILS	1:25
			MCD-02	PLASTER ACCESSORIES DETAILS	1:2 0	LSD-24	WOODEN BENCH TYPE (3) DETAIL	1:10 0	WD	-08 ALUMINUM WINDOWS DETAIL	1:4	WAD-03	TYPICAL HC TOILET- WASH BASIN DETAILS	1:25
			MCD-03	INTERNAL DISABLED RAMP DETAILS (1 OF 2)	AS SHOWN 0	LSD-24	BASKETBALL FIELD PLAN	1:100 0	WD	-09 ALUMINUM WINDOWS DETAIL	1:4	WAD-04	TYPICAL HC TOILET- WC DETAILS	1:25
			MCD-04	INTERNAL DISABLED RAMP DETAILS (2 OF 2)	AS SHOWN 0			AS SHOWN 0	_			WAD-05	TYPICAL KG TOILET- WASH BASIN DETAILS	1:25
			MCD-05	WINDOWS GUARD RAIL DETAILS	AS SHOWN 0	LSD-26	BASKETBALL FIELD DETAILS					WAD-06	TYPICAL KG TOILET- WESTERN WC DETAILS	1:25
			MCD-06	CANTEEN WINDOW GUARD RAIL DETAILS		LSD-27	VOLLEY BALL FIELD DETAILS	AS SHOWN 0				WAD-07		-
				ACCESS LADDER DETAIL	1:25 0	LSD-28	FOOTBALL FIELD DETAILS	AS SHOWN 0	_				TYPICAL STUDENTS' TOILET- WASH BASIN DETAILS	1:25
			MCD-07		1:20 0	LSD-29	EXTERNAL STEPS(AMPHITHEATER)	1:25 0				WAD-08	TYPICAL STUDENTS' TOILET- EASTERN WC DETAILS	1:25
			MCD-08	FIRE HOSE REEL CABINET DETAIL	1:25 0	LSD-30	TYPICAL STEEL PERGOLA DETAILS (1 of 2)	1:25 0	_			WAD-09	TYPICAL STUDENTS' TOILET- WESTERN WC DETAILS	1:25
			MCD-09	GAS CLOSET DETAIL	AS SHOWN 0	LSD-31	TYPICAL STEEL PERGOLA DETAILS (2 of 2)	1:25 0	_			WAD-10	TYPICAL STUDENTS' TOILETS	1:25
			MCD-10	BUILT-IN MECHANICAL AND ELECTRICAL CABINETS	1:20 0	LSD-32	STEEL MESH FENCE DETAILS	1:20 0	_			WAD-11	TYPICAL OUTDOOR DRINKING FOUNTAIN DETAILS	AS SHOV
			MCD-11	FALSE CEILING TYPICAL DETAILS (1 OF 3)	AS SHOWN 0	LSD-33	STEEL MESH FENCE DETAILS	AS SHOWN 0	_					_
			MCD-12	FALSE CEILING TYPICAL DETAILS (2 OF 3)	AS SHOWN 0	LSD-34	STEEL MESH DOOR DETAIL	1:20 0						
			MCD-13	FALSE CEILING TYPICAL DETAILS (3 OF 3)	AS SHOWN 0	LSD-35	STEEL MESH FENCE DETAILS	1:20 0						
			MCD-14	RAIN WATER DRAIN FOR ROOF	1:10 0	LSD-36	STEEL MESH FENCE DETAILS	AS SHOWN 0						
			MCD-15A	TYPICAL ELEVATOR DETAIL	1:50 0	LSD-37	STEEL MESH FENCE DETAILS	1:20 0						
			MCD-15	TYPICAL ELEVATOR DETAIL WITH 1 ENTRANCE	AS SHOWN 0	LSD-38	STEEL FENCE DETAILS	1:25 0						
			MCD-16	TYPICAL ELEVATOR DETAIL WITH 2 ENTRANCES	1:50 0	LSD-39	PLANTER AT MAIN GATE DETAIL	AS SHOWN 0						
			MCD-17	ROOF HANDRAIL AT PARAPET DETAIL	AS SHOWN 0									
			MCD-18	STAINLESS STEEL LADDER AT WATER TANK	1:20 0									
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			EXTERNAL F	INISHES
	BUILDING/ EXTERNAL WALLS		LANDSC	CAPE
	COLOR SCHEME	FLOOR	INTERLOCKING TILE PEACH COLOR SIZE: 65x100x200mm	
EMENT BA	SED PREMIXED DECORATIVE COATS (TEXTURE: GROOVED GRAFFIO FINISH) LOWING COLOR SHADES:			
EXTERNAL WALLS WEATHER PAINT	COLOR SHADE 1 (RAL 1013)		INTERLOCKING TILE GREY COLOR SIZE: 65x100x200mm	
	COLOR SHADE 2 (RAL 1015)		INTERLOCKING TILE PEACH COLOR SIZE: 65x150x150mm	
	COLOR SHADE 3 (RAL 1014)		INTERLOCKING TILE GREY COLOR SIZE: 65x150x150mm	
	COLOR SCHEME		CURB STONE GREY COLOR SIZE: 500x300x150mm	
STONE CLADDING	LOCAL STONE MUSAMSAM STONE (مورينه) MUFAJAR STONE (مورينه)		ANTI-SLIP GRANITE	
	LOCAL STONE MUSAMSAM STONE (టిఎమారా) MUFAJAR STONE (టిఎమారా)	k -		
			LOCAL STONE (MATTABEH)	
TEEL VORKS	POWDER COATED GREY (RAL 7037)			
	SEMI GLOSS OIL PAINT GREY (RAL 7037)			

REV.	DATE	REMARKS







BOOK OF DETAILS

DRAWING NAME:	Design:	Drawn:	REVISION No. :	I
	H.B.	Engicon	0	
COLOR SCHEME	Checked:	Approved:	SHEET NUMBER:	I
EXTERNAL FINISHES	M.Sh.	S.B.		I
EXTERINAL FINISHES	Date:	SCALE :	G-002	I
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			I					I	
			INTERNAL	FINIS	SHES				
	FLOOR TILES		WALL	FINISHE	S			CEILING	
FLOOR	FULLY VITRIFIED PORCELAIN TILES- SEALER GLAZE- SALT AND PEPPER COLOR: LIGHT BEIGE SIZE: 400x400mm	WALL CLADDING/ COPING/ SKIRTING	FULL BODY, FULLY VITRIFIED PORCELAIN COLOR: LIGHT BEIGE TILE SIZE: 400x400mm SKIRTING SIZE: 400x80mm FOR PORCELAIN TILES FINISH :IT SHOULD BE SEALER GLAZED IN WET AREAS AND POLISHED ELSEWHERE.				SUSPENDED CEILING	15mm THK. ACOUSTICAL MINERAL FIBER SUSPENDED CEILING 600X600mm TILES	
	FULLY VITRIFIED PORCELAIN TILES- SEALER GLAZE- SALT AND PEPPER COLOR: GRAY SIZE: 400x400mm		FULL BODY, FULLY VITRIFIED PORCELAIN COLOR: BROWN TILE SIZE: 400x400mm SKIRTING SIZE: 400x80mm FOR PORCELAIN TILES FINISH :IT SHOULD BE SEALER GLAZED IN WET AREAS AND POLISHED ELSEWHERE.					12.5mm THK. SUSPENDED CEILING GYPSUM BOARD PAINTED WHITE	
	FULLY VITRIFIED PORCELAIN TILES- SEALER GLAZE- SALT AND PEPPER COLOR: MAROON SIZE: 400x400mm		FULL BODY, FULLY VITRIFIED PORCELAIN COLOR: MAROON TILE SIZE: 400x400mm SKIRTING SIZE: 400x80mm FOR PORCELAIN TILES FINISH :IT SHOULD BE SEALER GLAZED IN WET AREAS AND POLISHED ELSEWHERE.					12.5mm THK. MOISTURE RESISTANT SUSPENDED CEILING GYPSUM BOARD PAINTED WHITE	
	GRANITE COLOR: RED		GRANITE COLOR: RED					19mm THK. MOISTURE RESISTANT SUSPENDED CEILING 600X600mm TILES	
	LOW COST TERRAZZO TILES CRUSHED MARBLE SIZE: 330x330mm		CERAMIC TILES- GLOSSY SIZE: 200x200mm (USED IN KITCHENETTES AND TOILETS)	BASE COLORS	WHITE	GREY	PLASTER AND PAINT	15mm ACOUSTICAL PLASTER COLOR: WHITE	
	NON-TOXIC EPOXY PAINT			PEACH	LIGHT BLUE	MINT GREEN		PLASTER AND EMULSION PAINT COLOR: WHITE	
	RUBBER MAT			PISTACHIO	YELLOW	DARK BLUE		PLASTER AND NON-TOXIC EPOXY PAINT COLOR: WHITE (USED FOR INTERNAL WALLS AND CEILING OF THE WATER TANK)	
	CARPET TILES USED ON THE PLATFORM OF OF THE MULTI-PURPOSE HALL AND IN THE LIBRARY)	PLASTER AND PAINT	PLASTER AND EMULSION PAINT COLOR AS PER ENGINEER APPROVAL FOR EA	CH SPACE					
		ACOUSTICA PANELS	L						

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	REV.	DATE	REMARKS







BOOK OF DETAILS

	DRAWING NAME:	Design:	Drawn:	REVISION No. :
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	COLOR SCHEME	Checked:	Approved:	SHEET NUMBER:
	INTERNAL FINISHES	M.Sh.	S.B.	
		Date:	SCALE :	G-003
		June 2020	-	

	DOORS							
DOOR RAME	PAINT COLOR: GREY (RAL 7037)							
DOOR EAF	LAMINATE COLOR: GREY FOR SERVICES & TOILETS							
	LAMINATE COLOR: DARK BLUE FOR CLUSTERS, OFFICES, LIBRARY, MULTI-PURPOSE							
	LAMINATE COLOR: LIME GREEN FOR CLASSROOMS							
	LAMINATE COLOR: YELLOW FOR KINDERGARTEN & CHILDCARE							
	LAMINATE COLOR: DARK PINK FOR KINDERGARTEN & CHILDCARE							

INTERNAL FINISHES











BOOK OF DETAILS


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INTERNAL FINISHES	M.Sh.	S.B.		
INTERNAL FINISHES	Date:	SCALE :	G-004	
	June 2020	-		

BUILDING DETAILS VERTICAL WALL SECTIONS

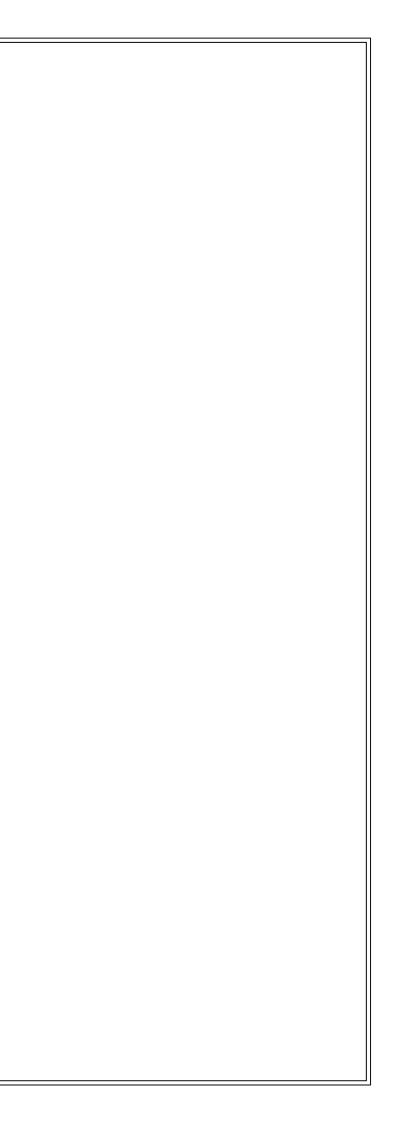


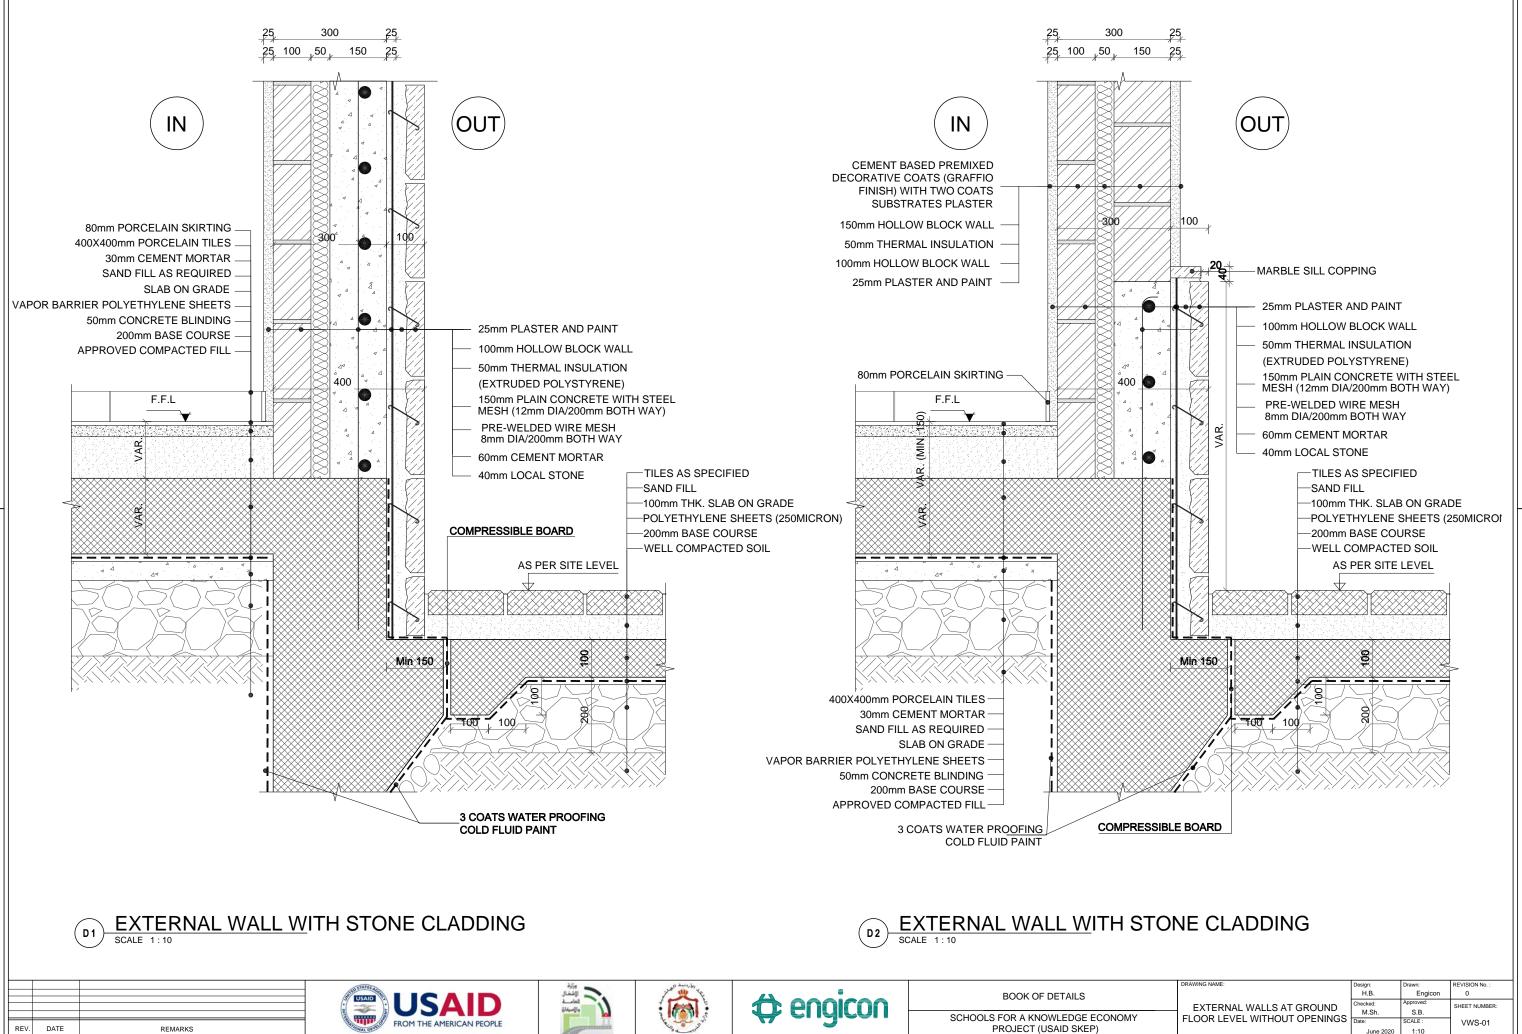



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	H.B.	Engicon	0
EXTERNAL WALLS AT GROUND	Checked:	Approved:	SHEET NUMBER:
	M.Sh.	S.B.	
FLOOR LEVEL WITHOUT OPENINGS	Date:	SCALE :	VWS-01
	June 2020	1:10	

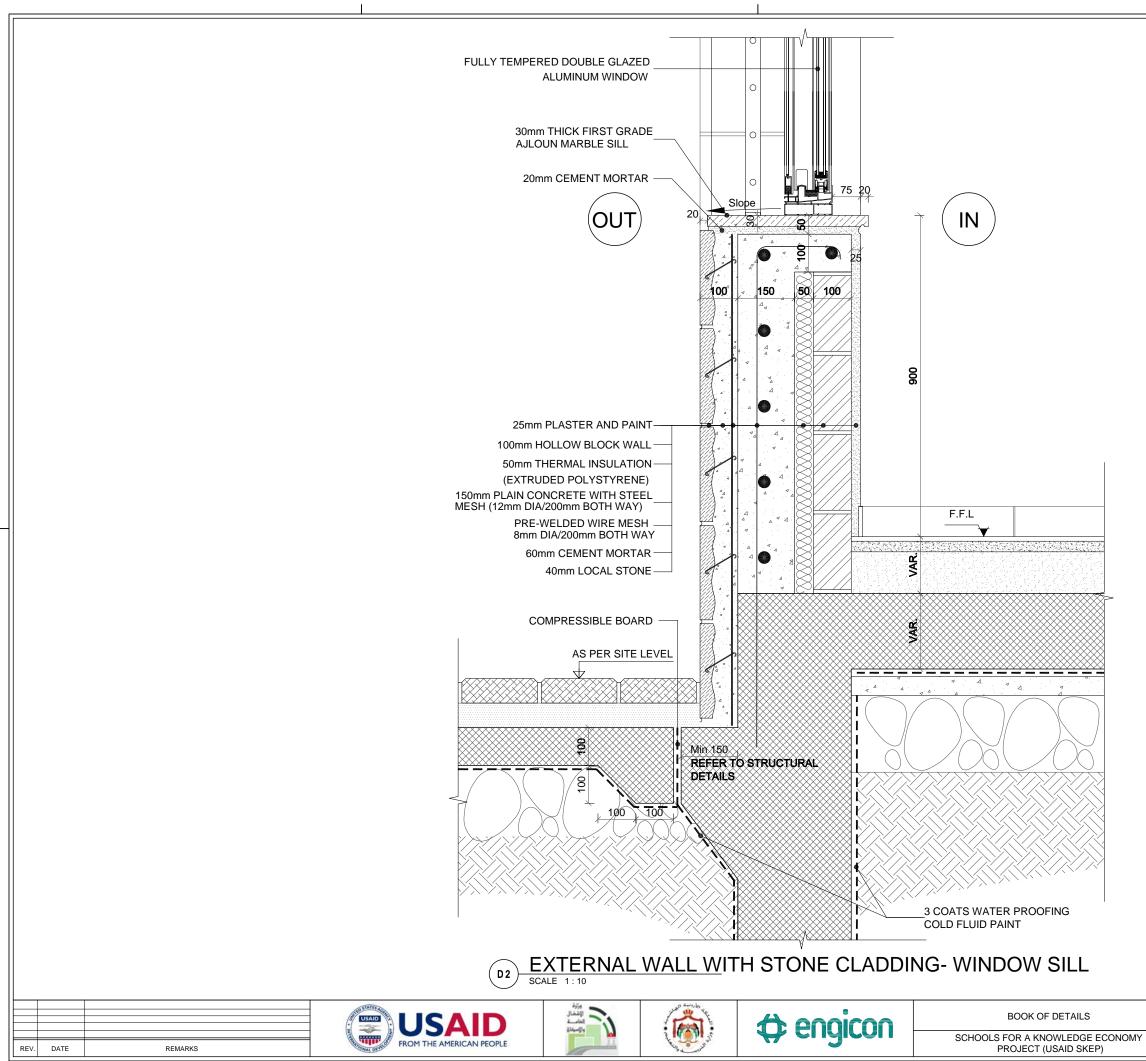


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	H.B.	Engicon	0	
EXTERNAL WALLS AT GROUND	Checked:	Approved:	SHEET NUMBER	
 	M.Sh.	S.B.		
FLOOR LEVEL WITH OPENINGS	Date:	SCALE :	VWS-02	
	June 2020	1:10		

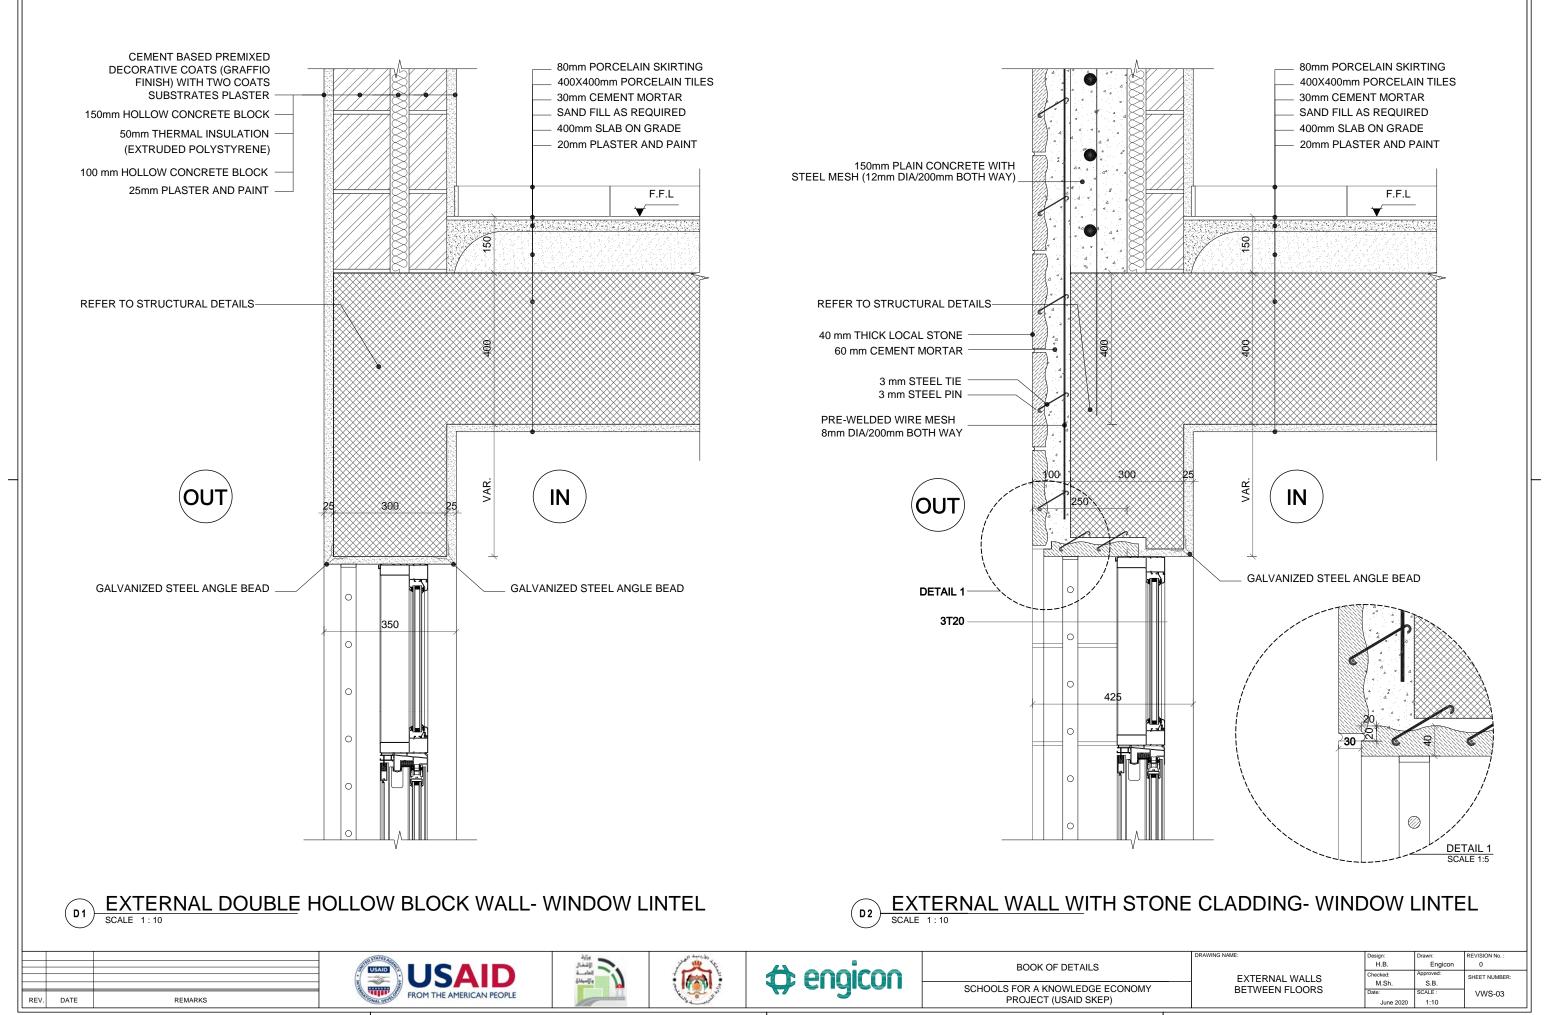


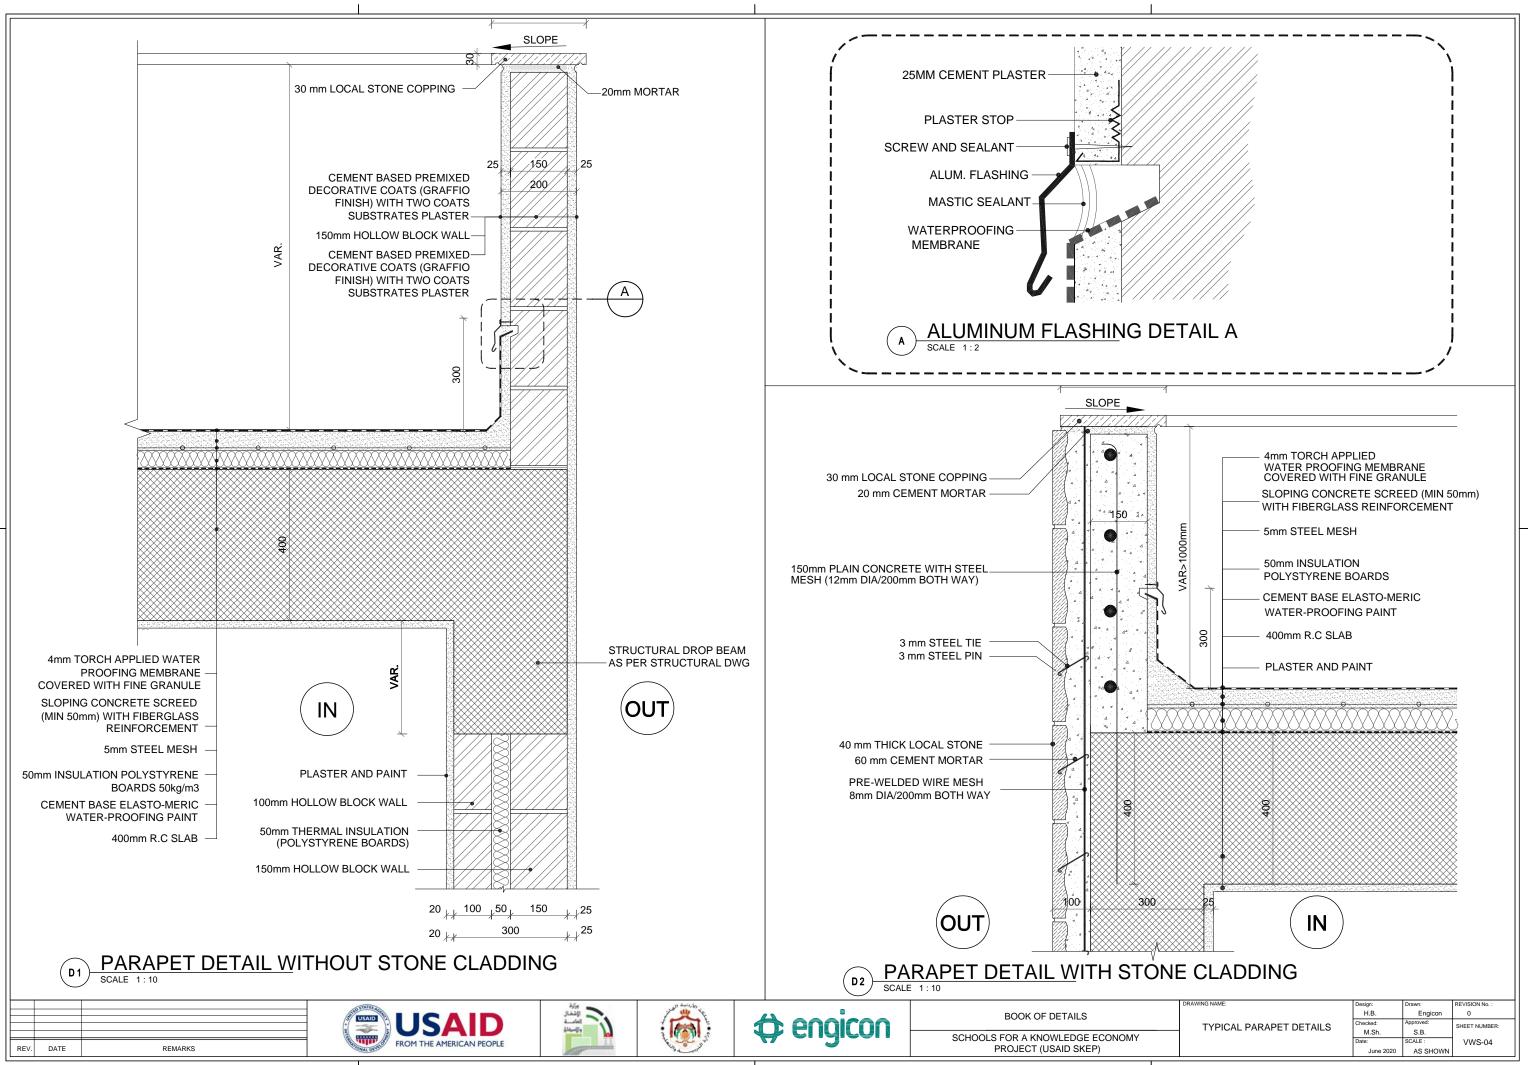

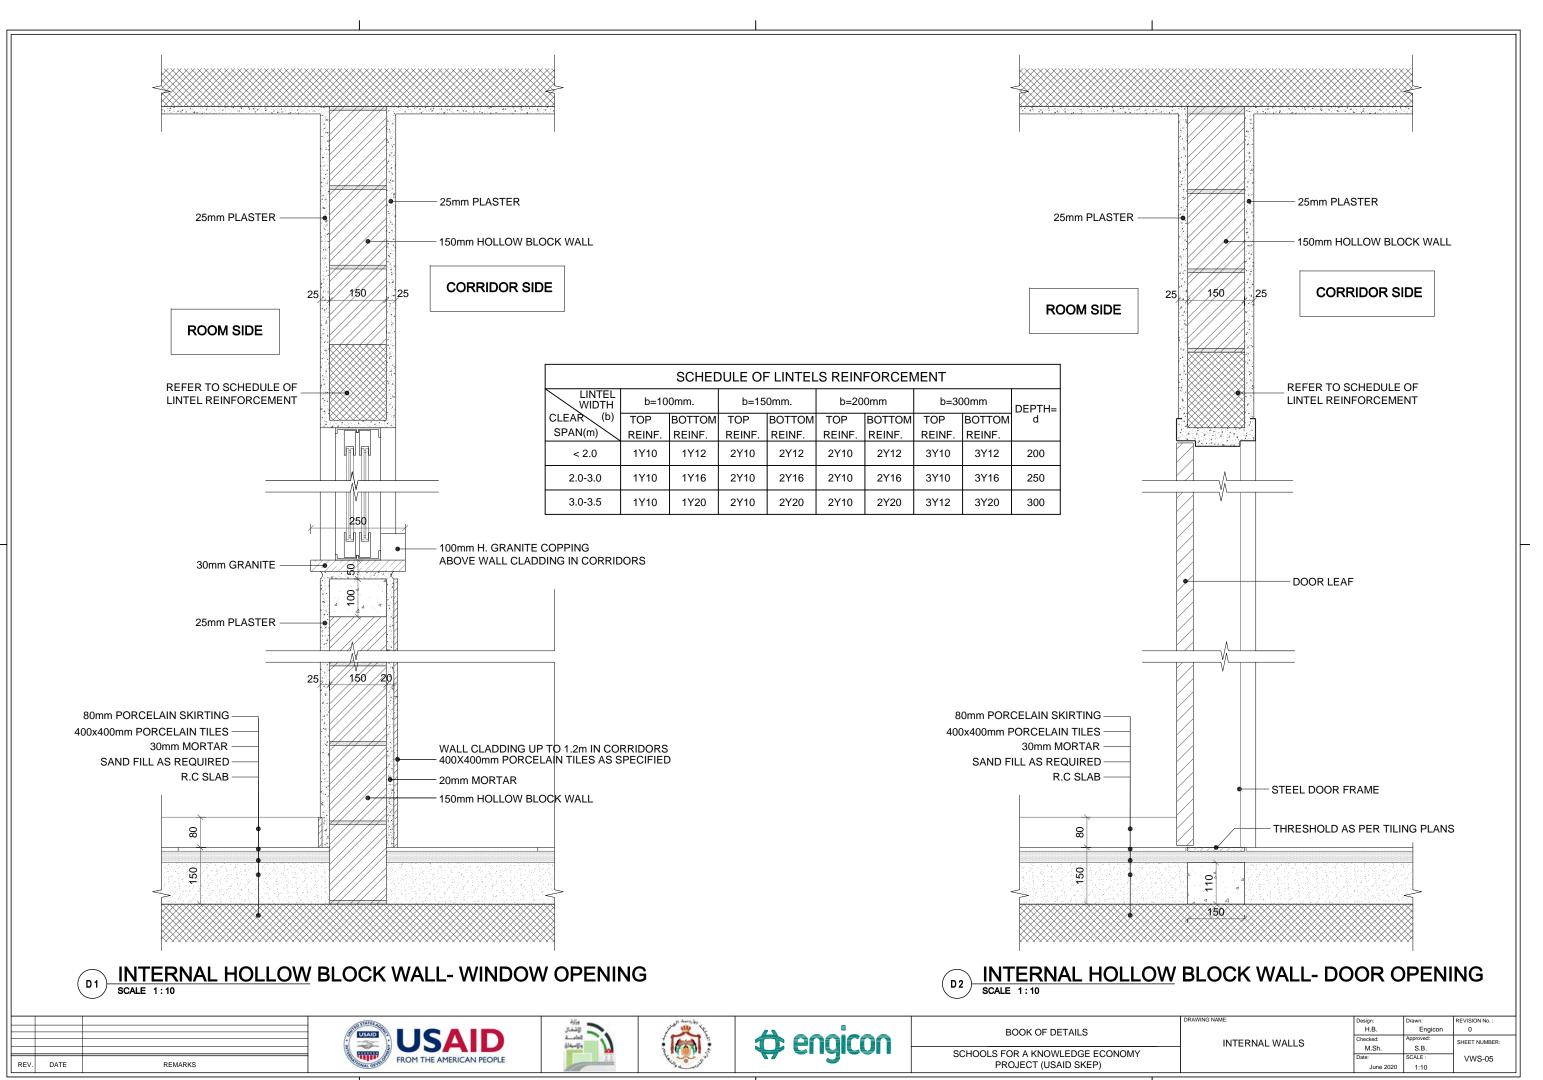

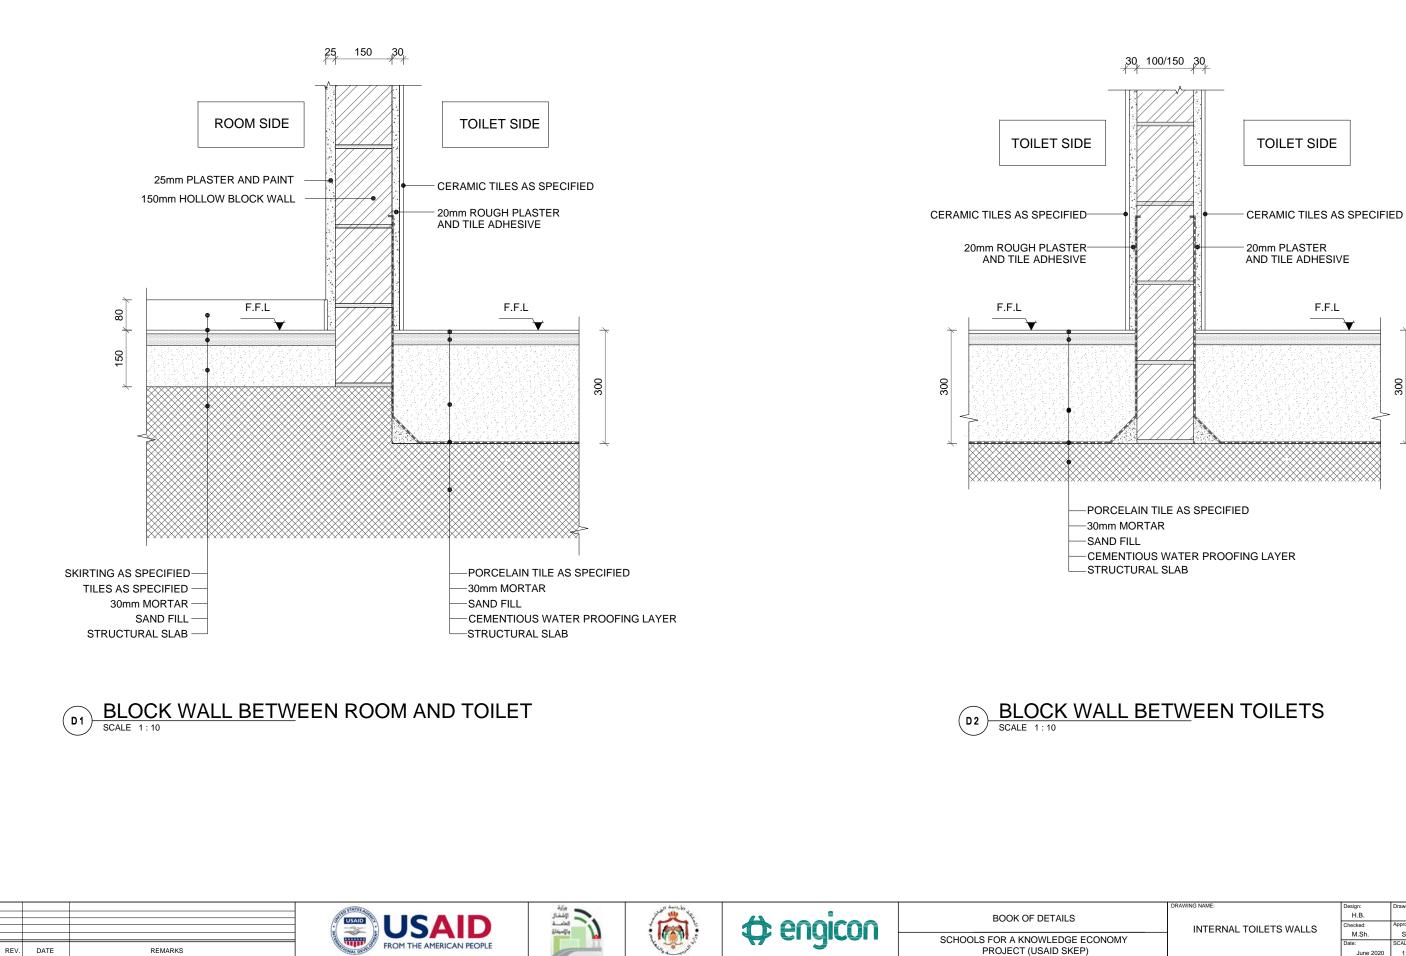

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INTERNAL TOILETS WALLS	Checked:	Approved:	SHEET NUMBER:
INTERNAL TOILETS WALLS	M.Sh.	S.B.	ONEET NOMBER
	Date:	SCALE :	VWS-06
	June 2020	1:10	

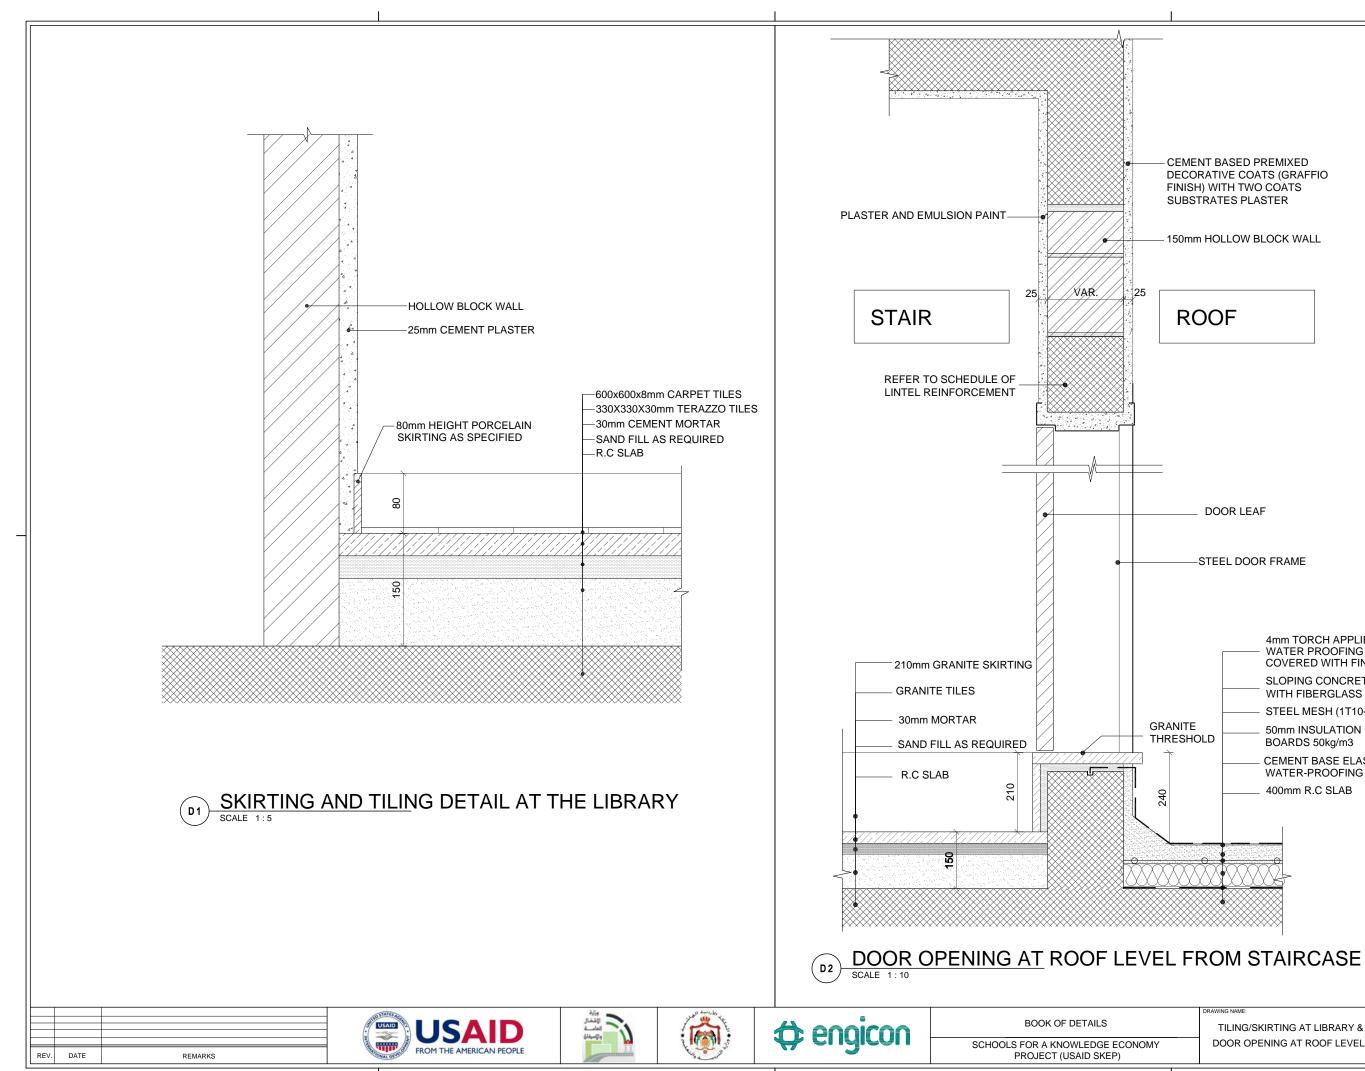

CEMENT BASED PREMIXED DECORATIVE COATS (GRAFFIO FINISH) WITH TWO COATS SUBSTRATES PLASTER

150mm HOLLOW BLOCK WALL


ROOF


DOOR LEAF

-STEEL DOOR FRAME


NITE ESHOLD	4mm TORCH APPLIED WATER PROOFING MEMBRANE COVERED WITH FINE GRANULE SLOPING CONCRETE SCREED (MIN 50mm) WITH FIBERGLASS REINFORCEMENT STEEL MESH (1T10-200) 50mm INSULATION POLYSTYRENE BOARDS 50kg/m3 CEMENT BASE ELASTO-MERIC WATER-PROOFING PAINT 400mm R.C SLAB


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TILING/SKIRTING AT LIBRARY &	Checked:	Approved:	SHEET NUMBER:	
DOOR OPENING AT ROOF LEVEL	M.Sh.	S.B.		
DOOR OF ENING AT ROOF EEVEE	Date:	SCALE :	VWS-07	
	June 2020	AS SHOWN		

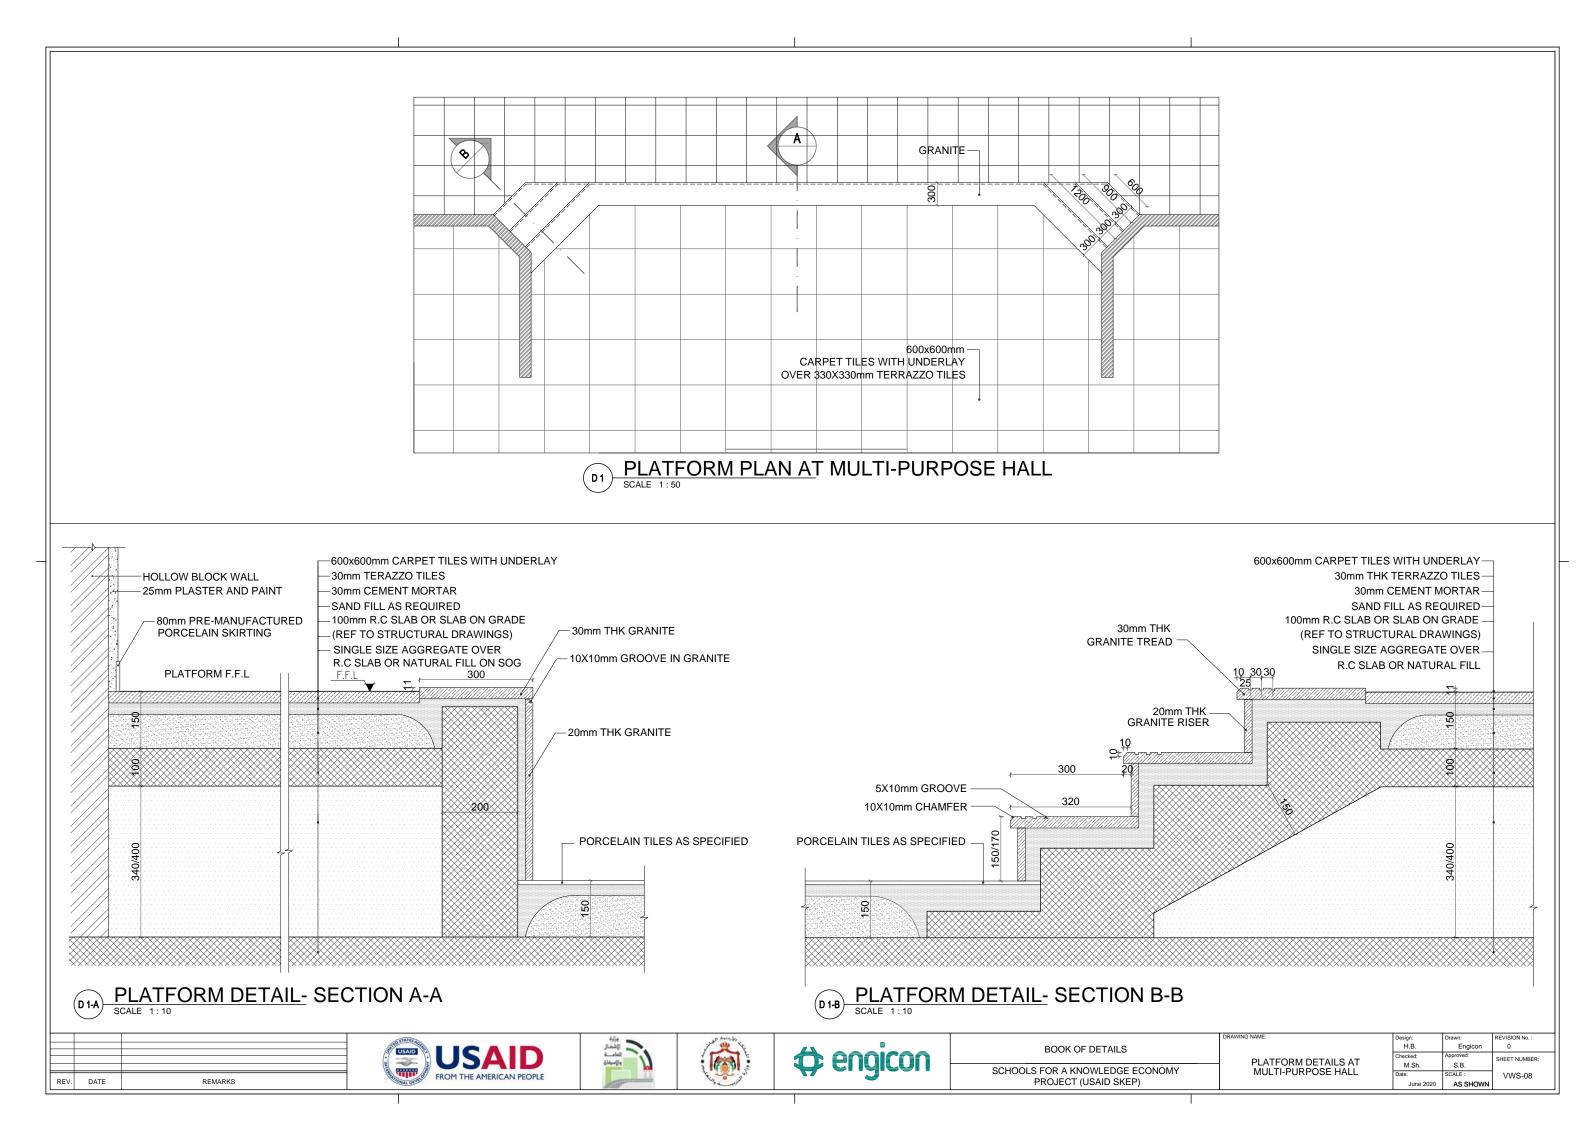

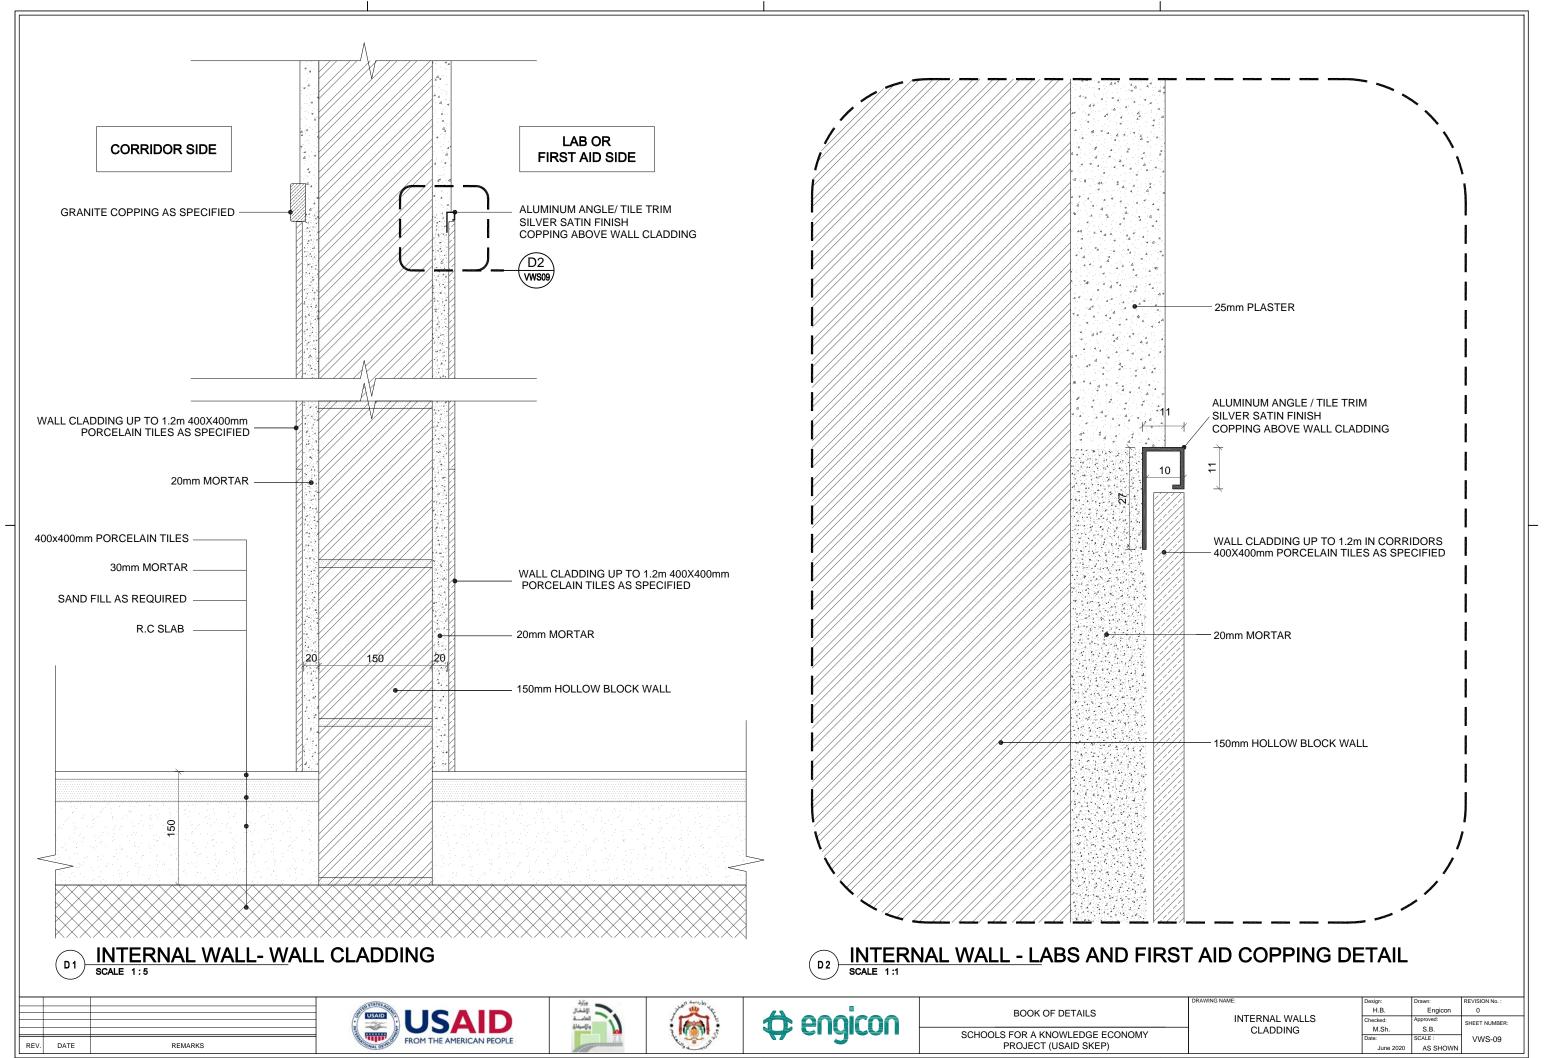


BUILDING DETAILS HORIZONTAL WALL SECTIONS

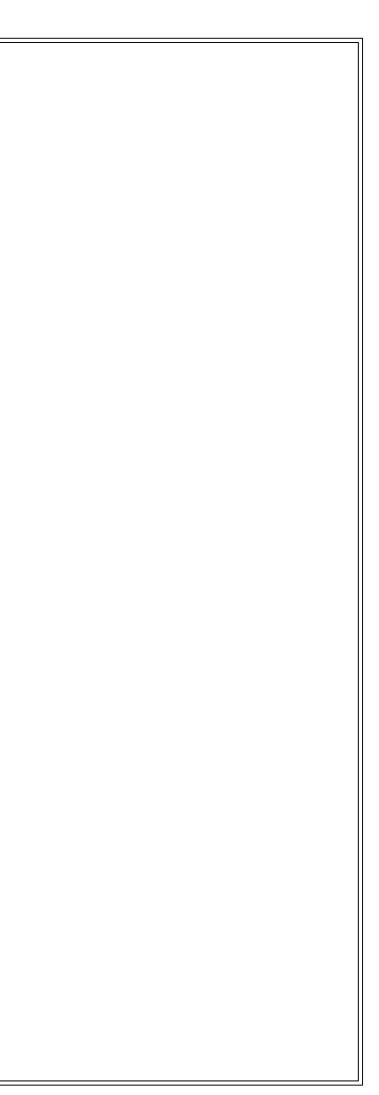


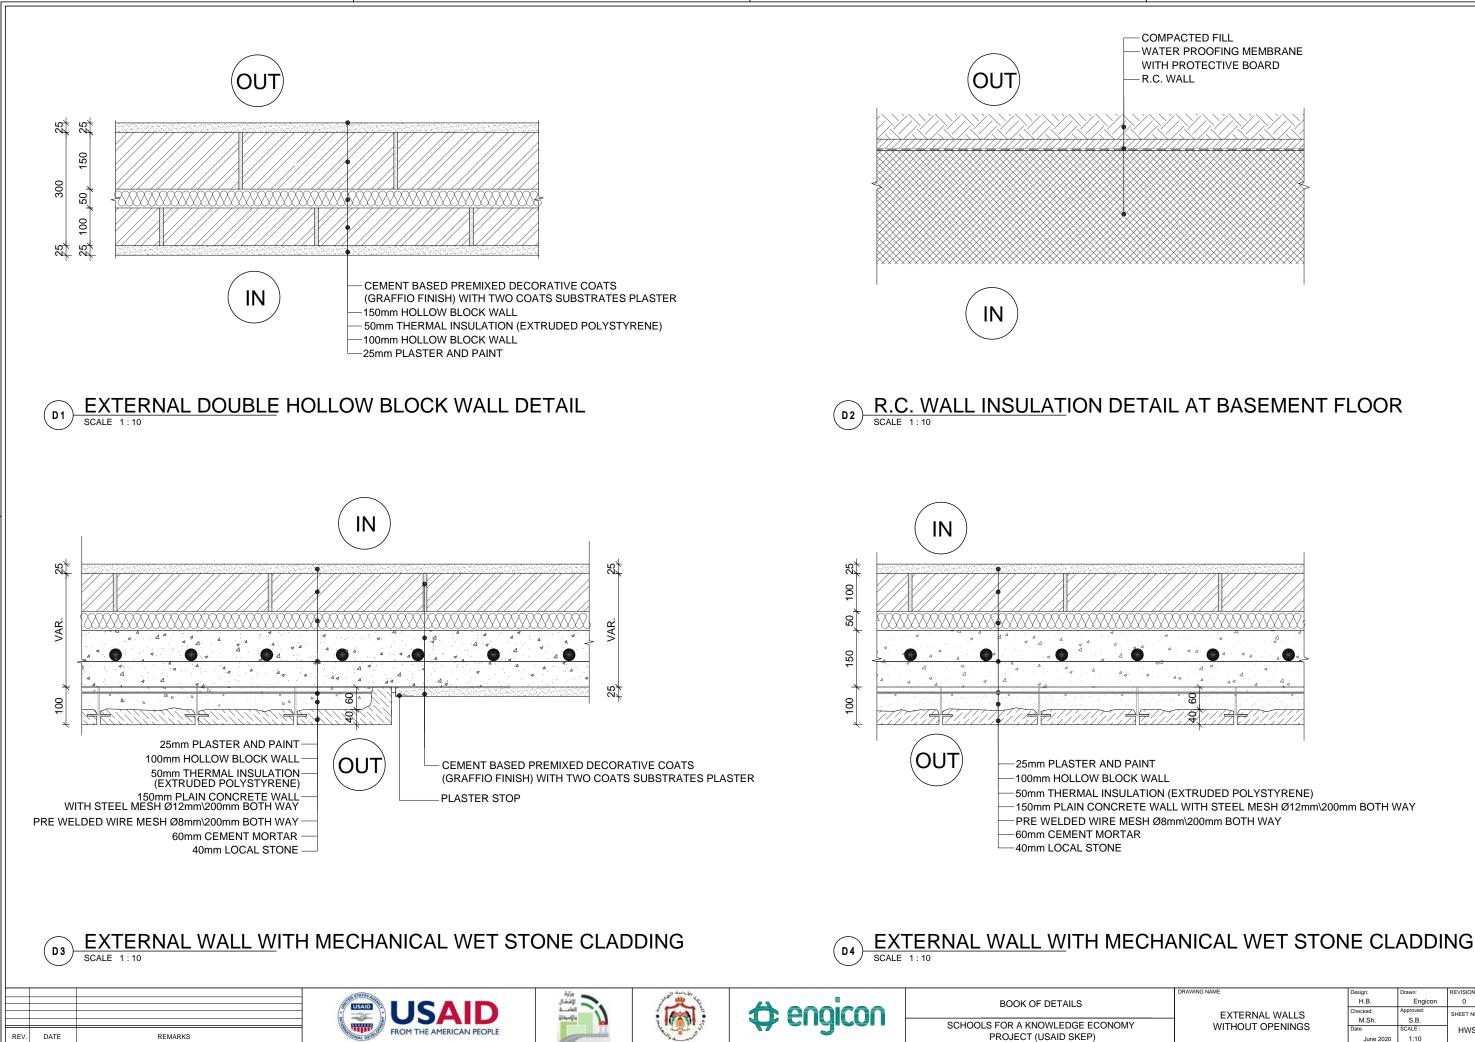


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EXTERNAL WALLS	Checked:	Approved:	SHEET NUMBER:
 	M.Sh.	S.B.	
WITHOUT OPENINGS	Date:	SCALE :	HWS-01
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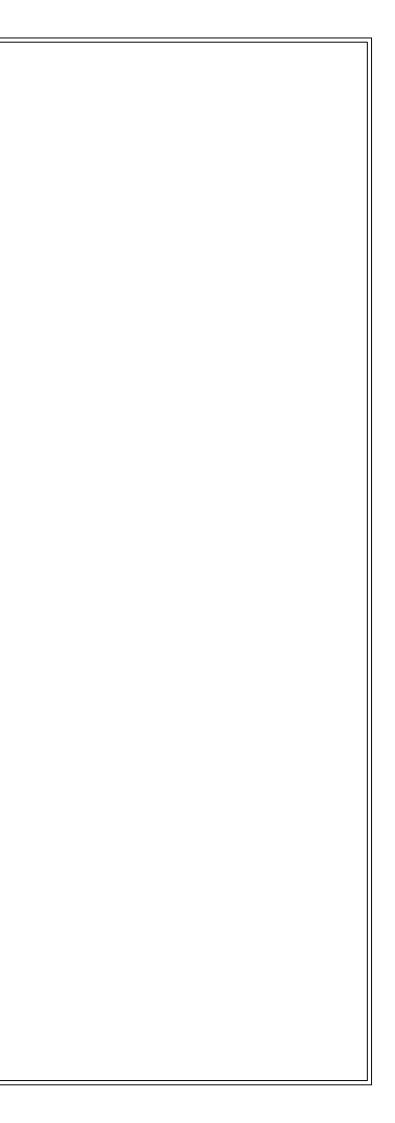
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INTERNAL WALLS	Checked:	Approved:	SHEET NUMBER:
	M.Sh.	S.B.	
	Date:	SCALE :	HWS-02
	June 2020	1:10	

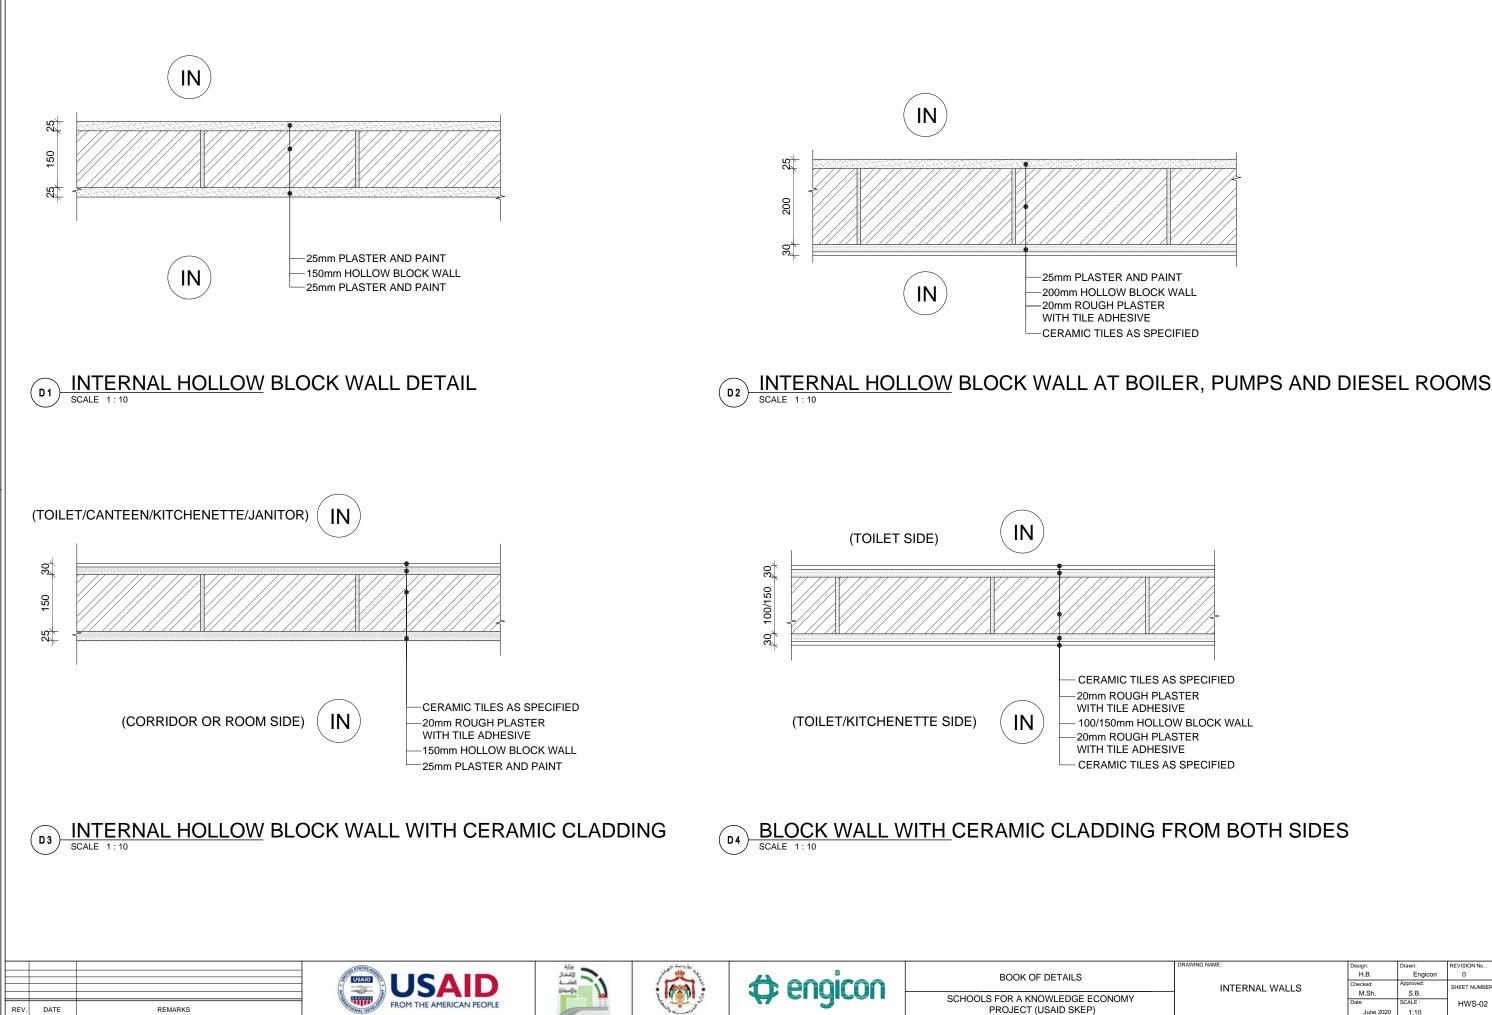



DRAWING NAME:	Design:	Drawn:	REVISION No. :
	H.B.	Engicon	0
DENIEODOED CONODETE MALLO	Checked:	Approved:	SHEET NUMBER:
REINFORCED CONCRETE WALLS	M.Sh.	S.B.	UNEET NOMBER
	Date:	SCALE :	HWS-03
	June 2020	1:10	

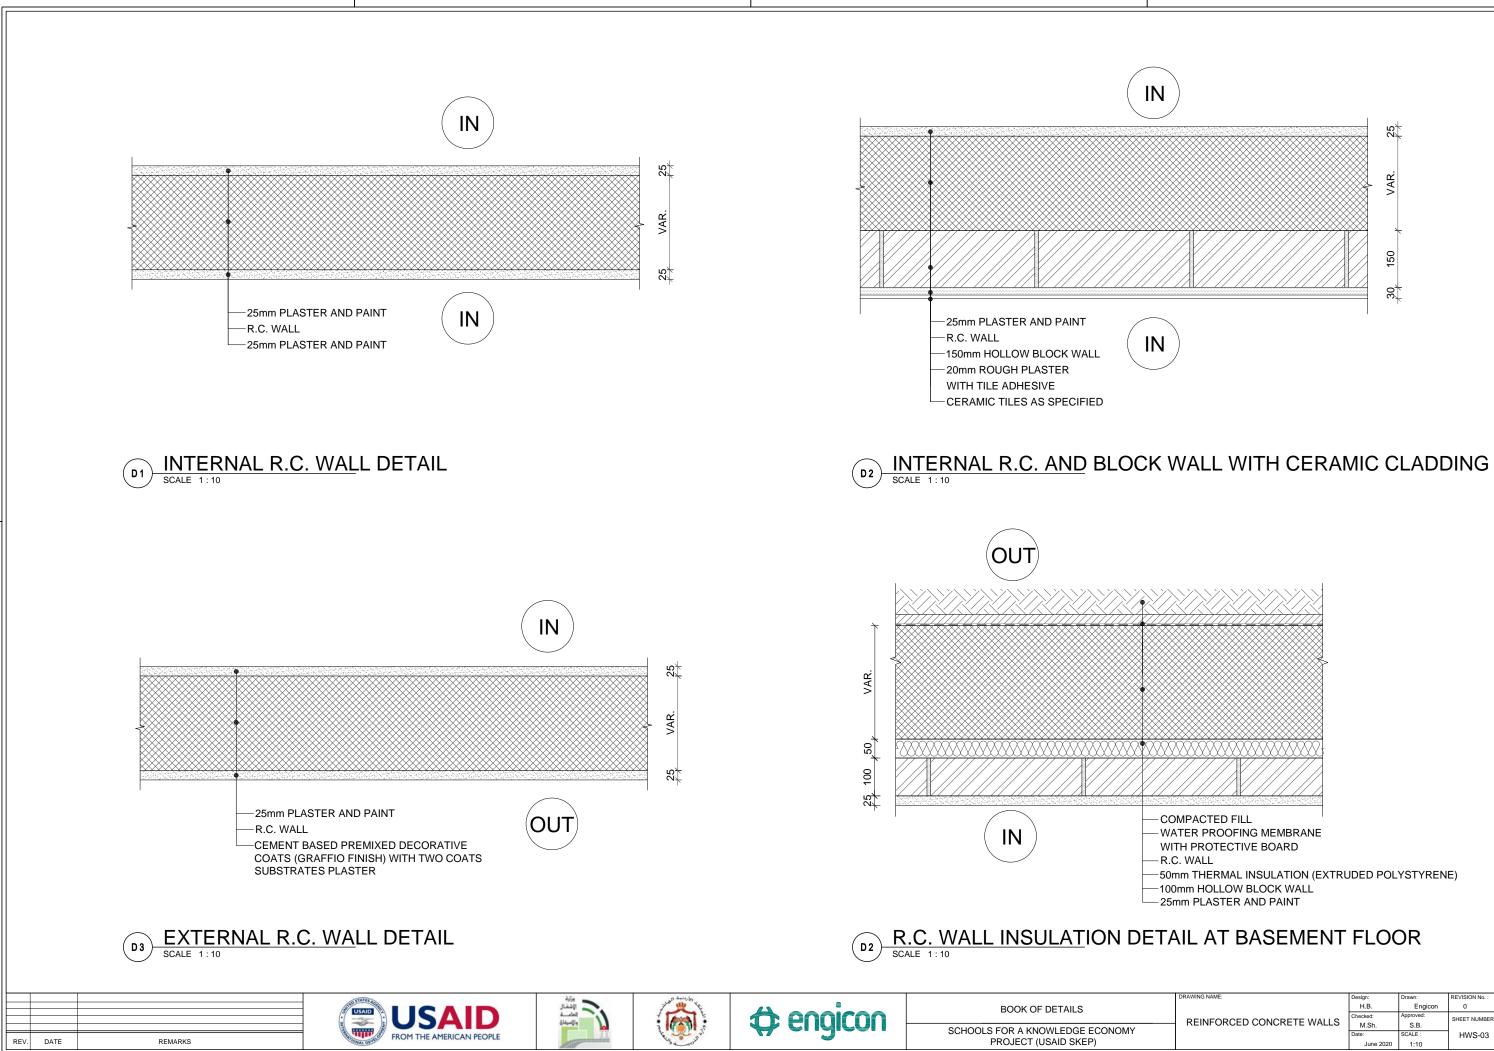


BUILDING DETAILS INTERNAL STAIRS DETAILS

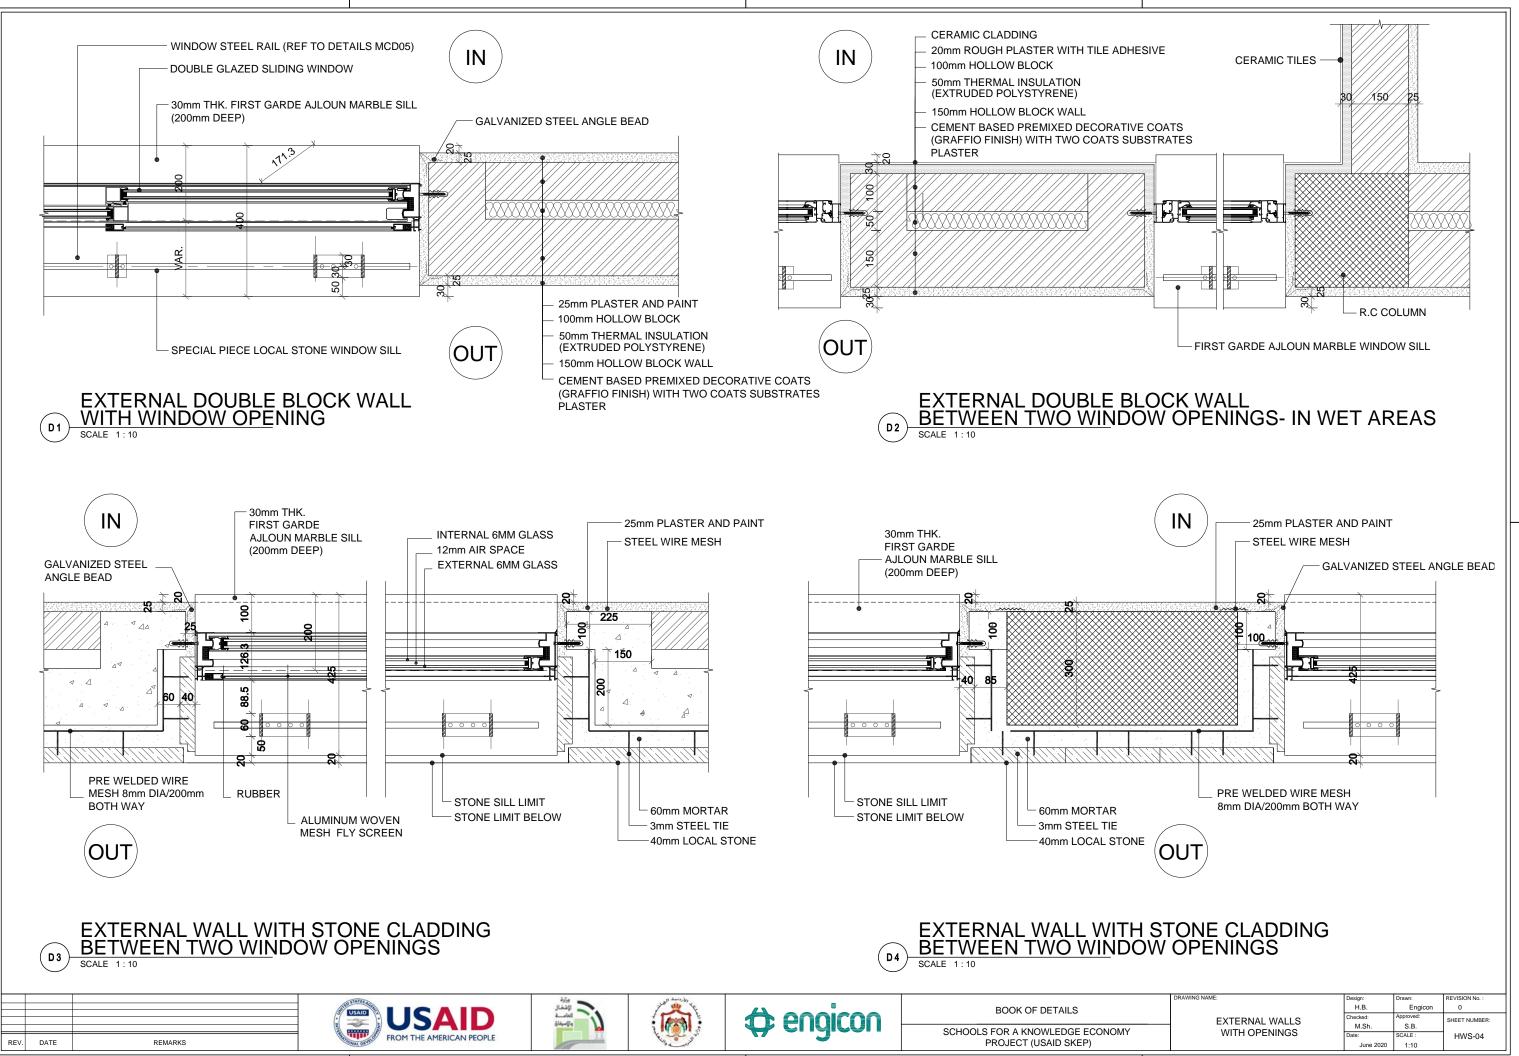


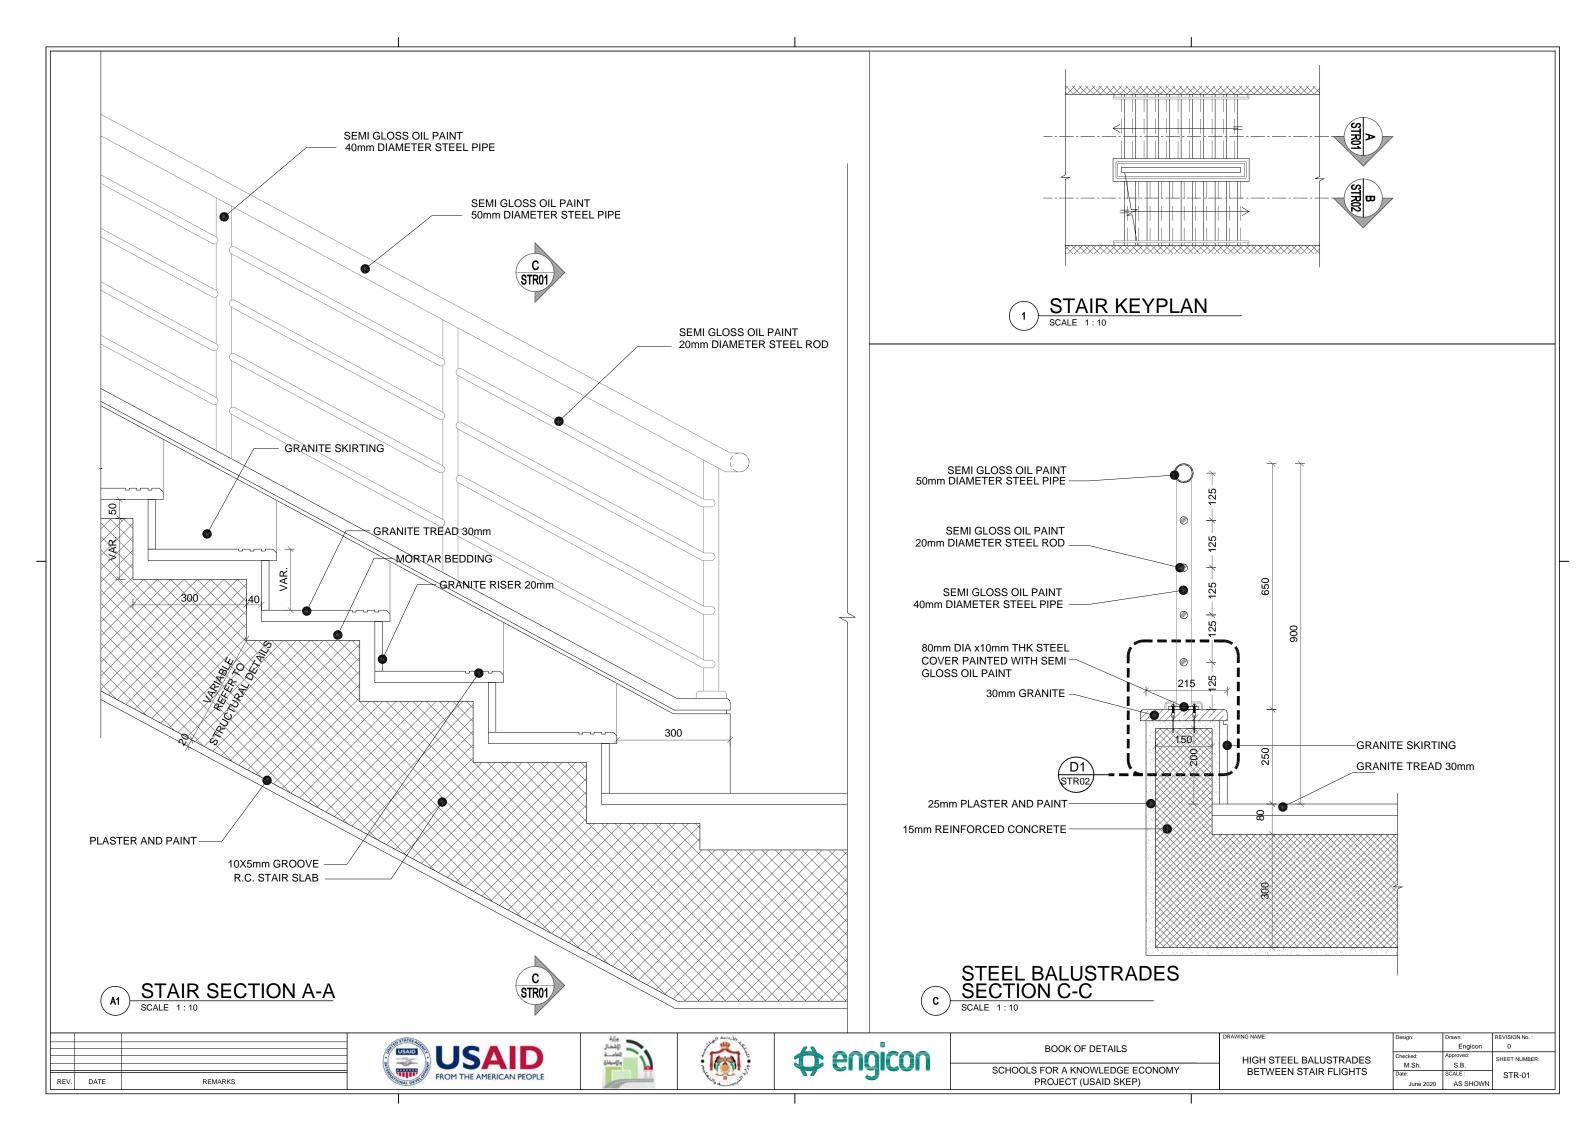


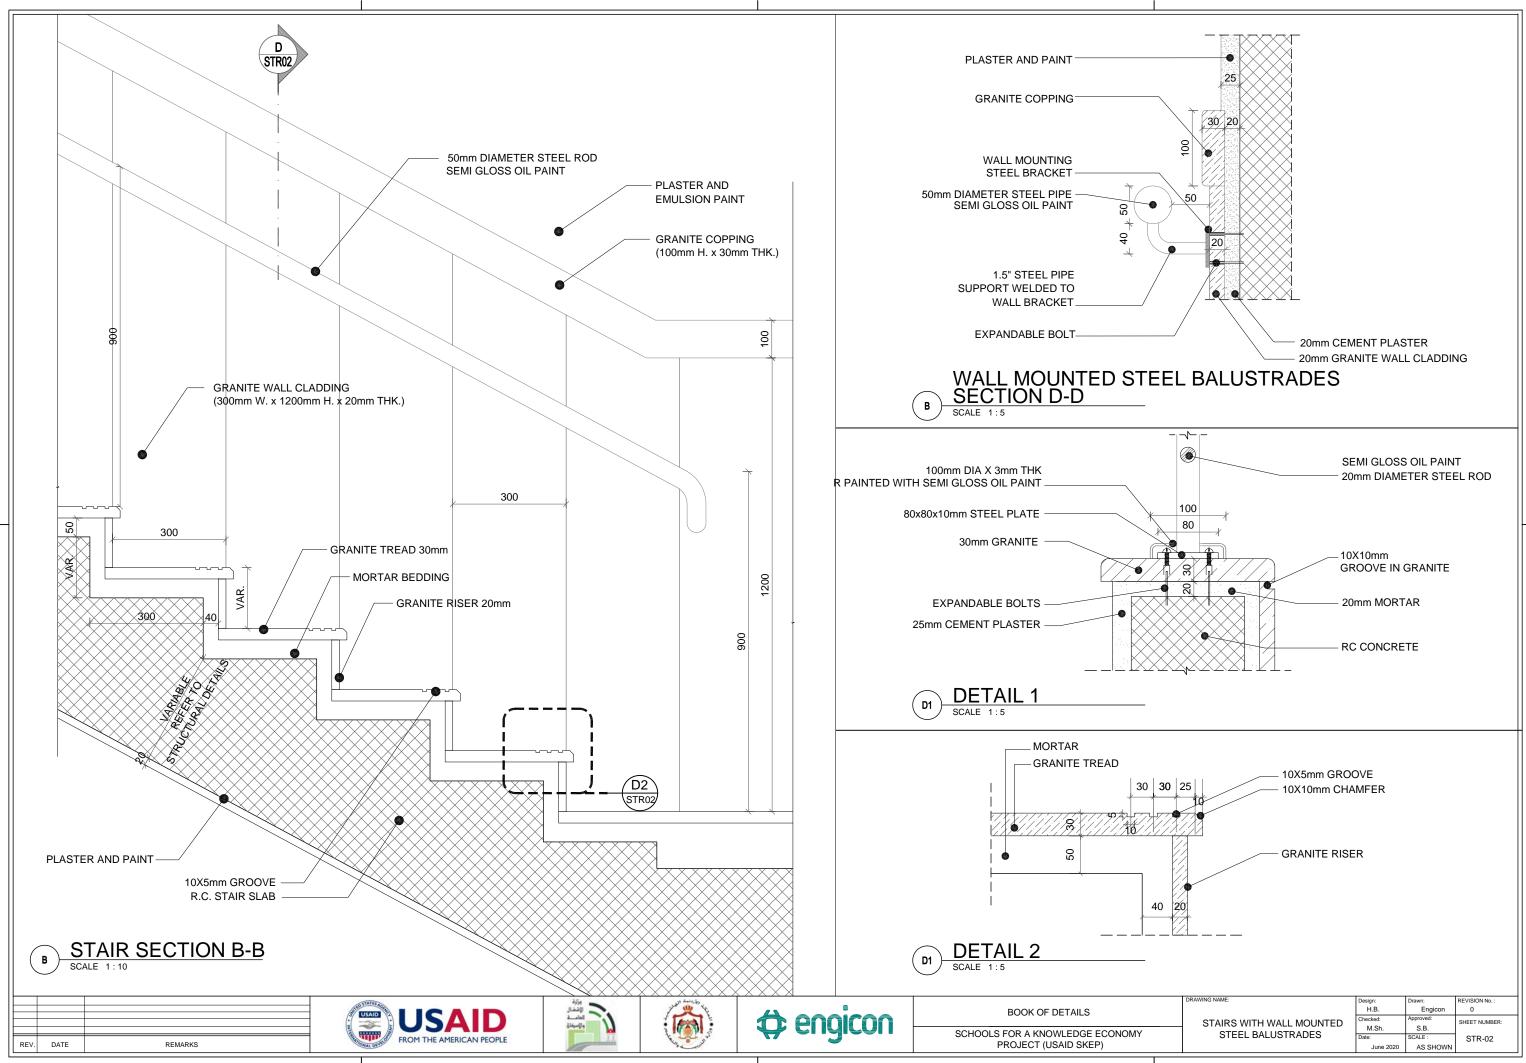

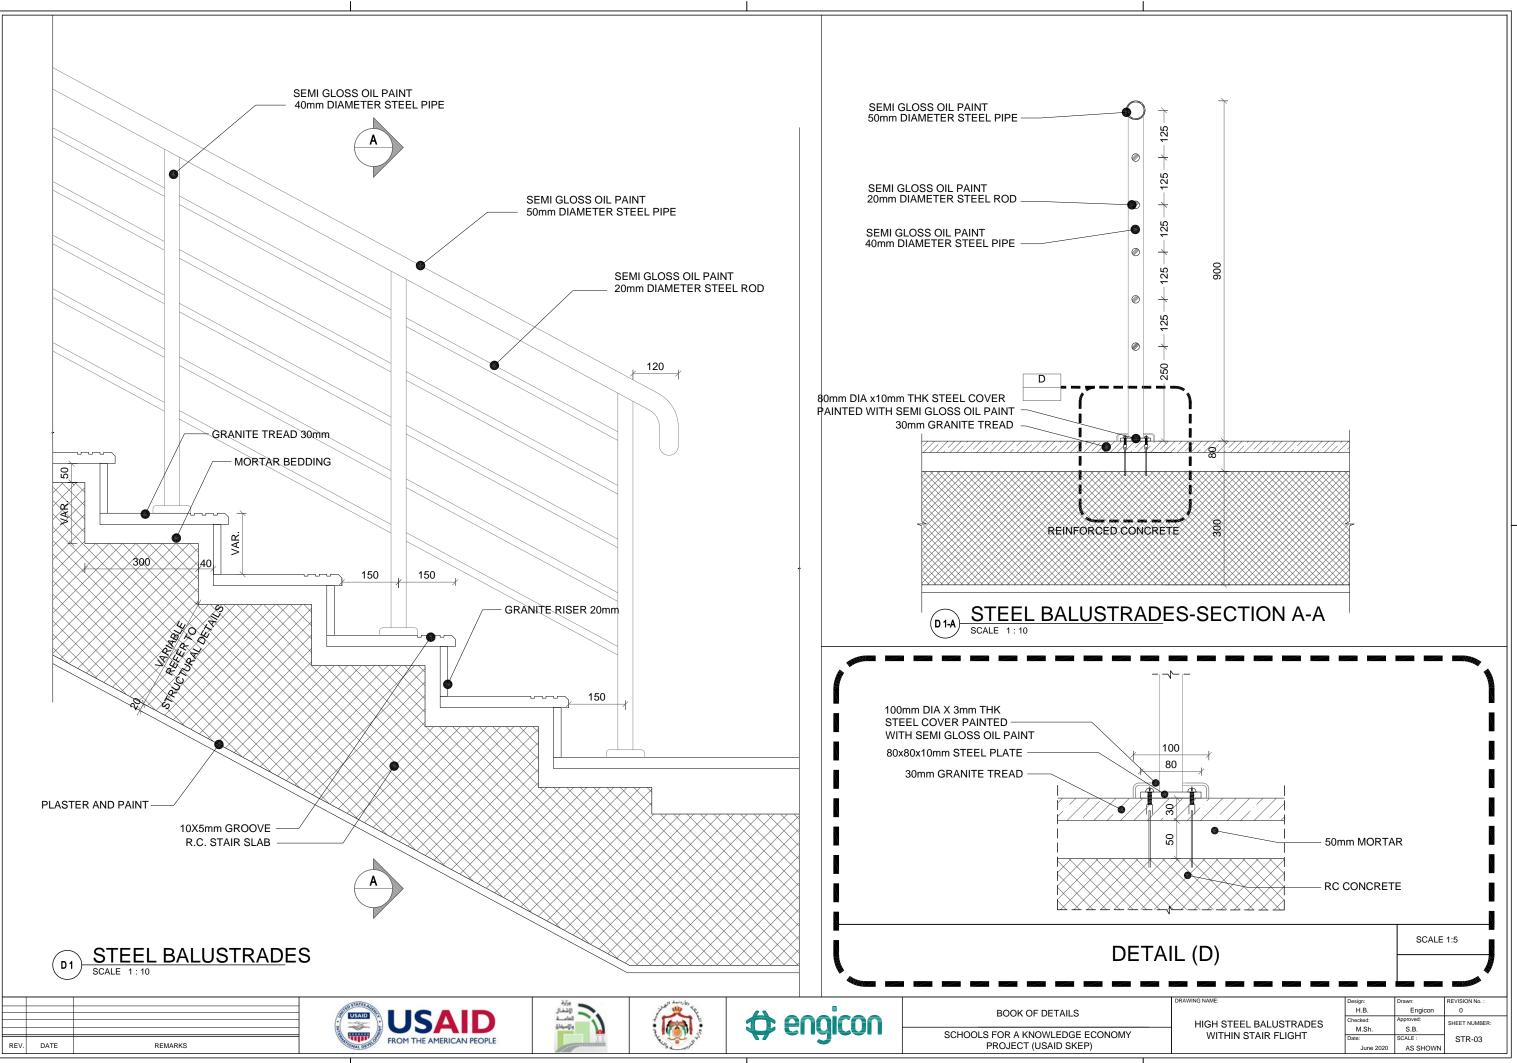


BUILDING DETAILS EXPANSION JOINT DETAILS

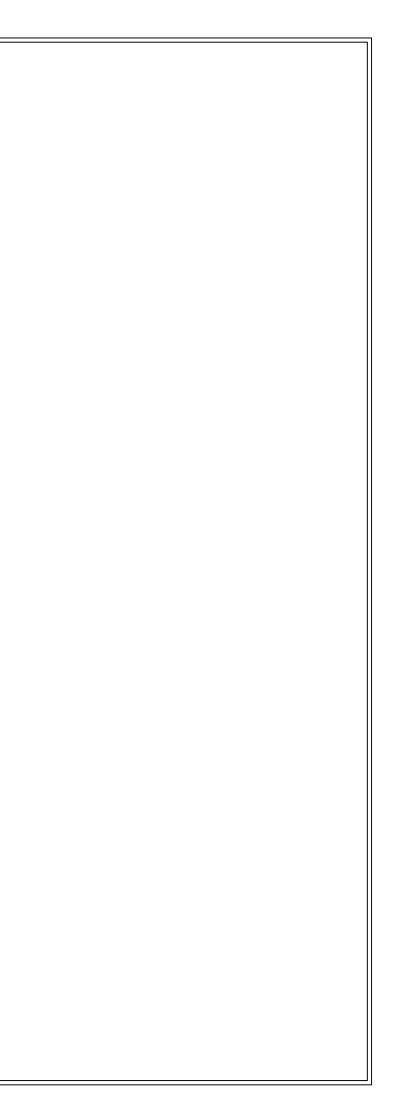


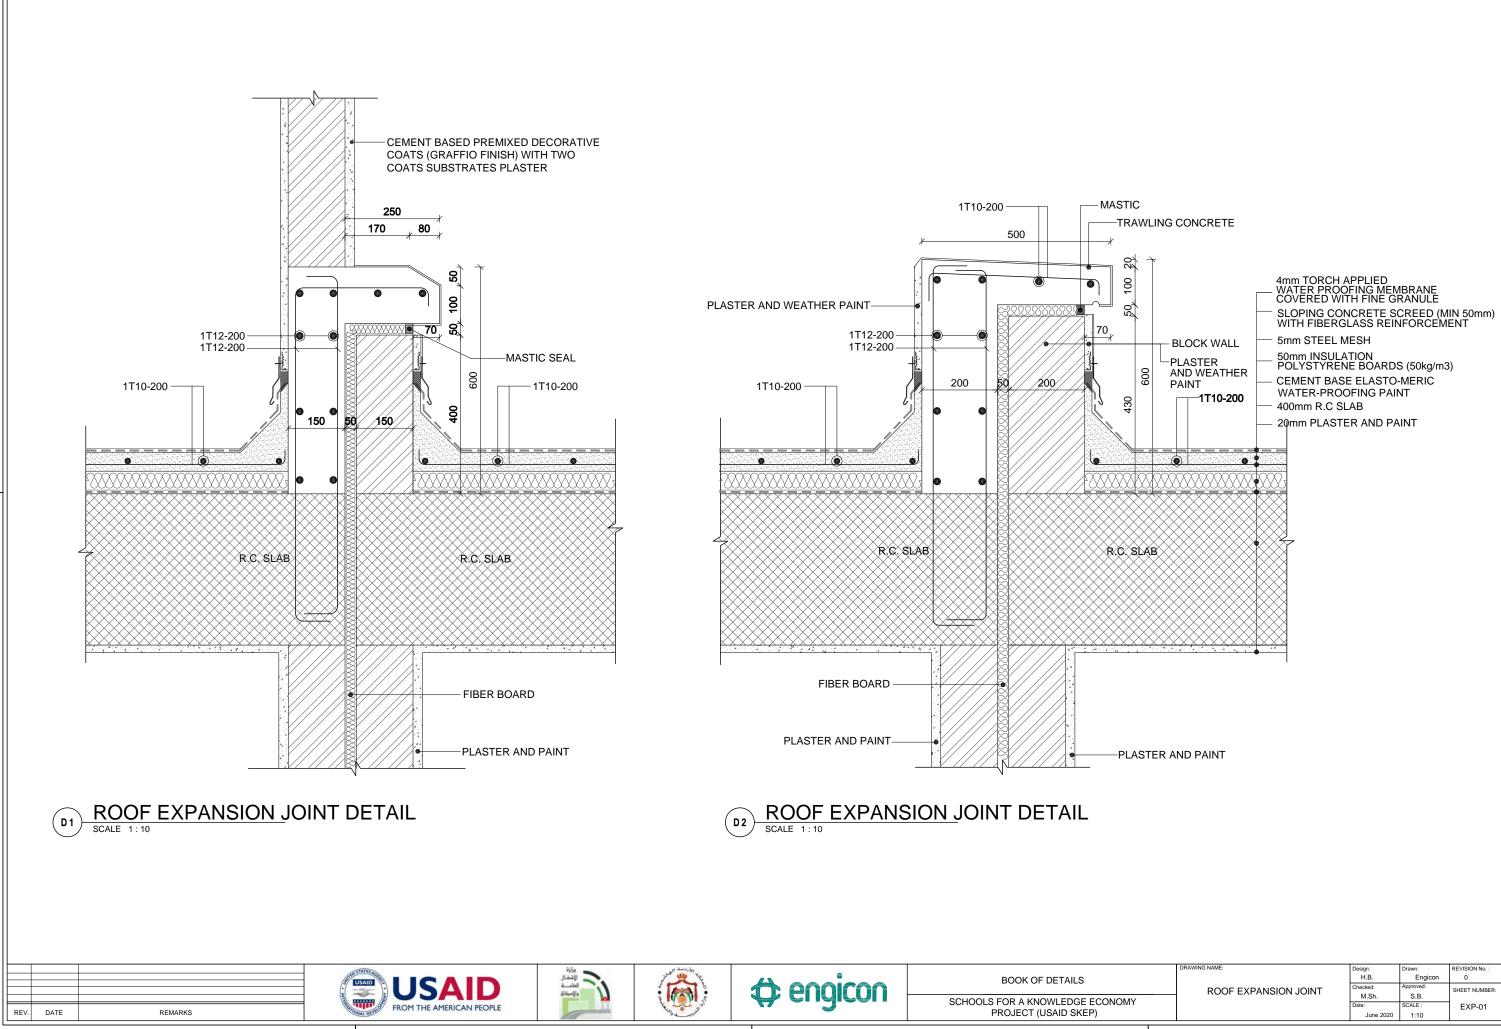


DRAWING NAME:	Design:	Drawn:	REVISION No. :
	H.B.	Engicon	0
ROOF EXPANSION JOINT	Checked:	Approved:	SHEET NUMBER
	M.Sh.	S.B.	GHEET HOMBER
	Date:	SCALE :	EXP-01
	June 2020	1:10	

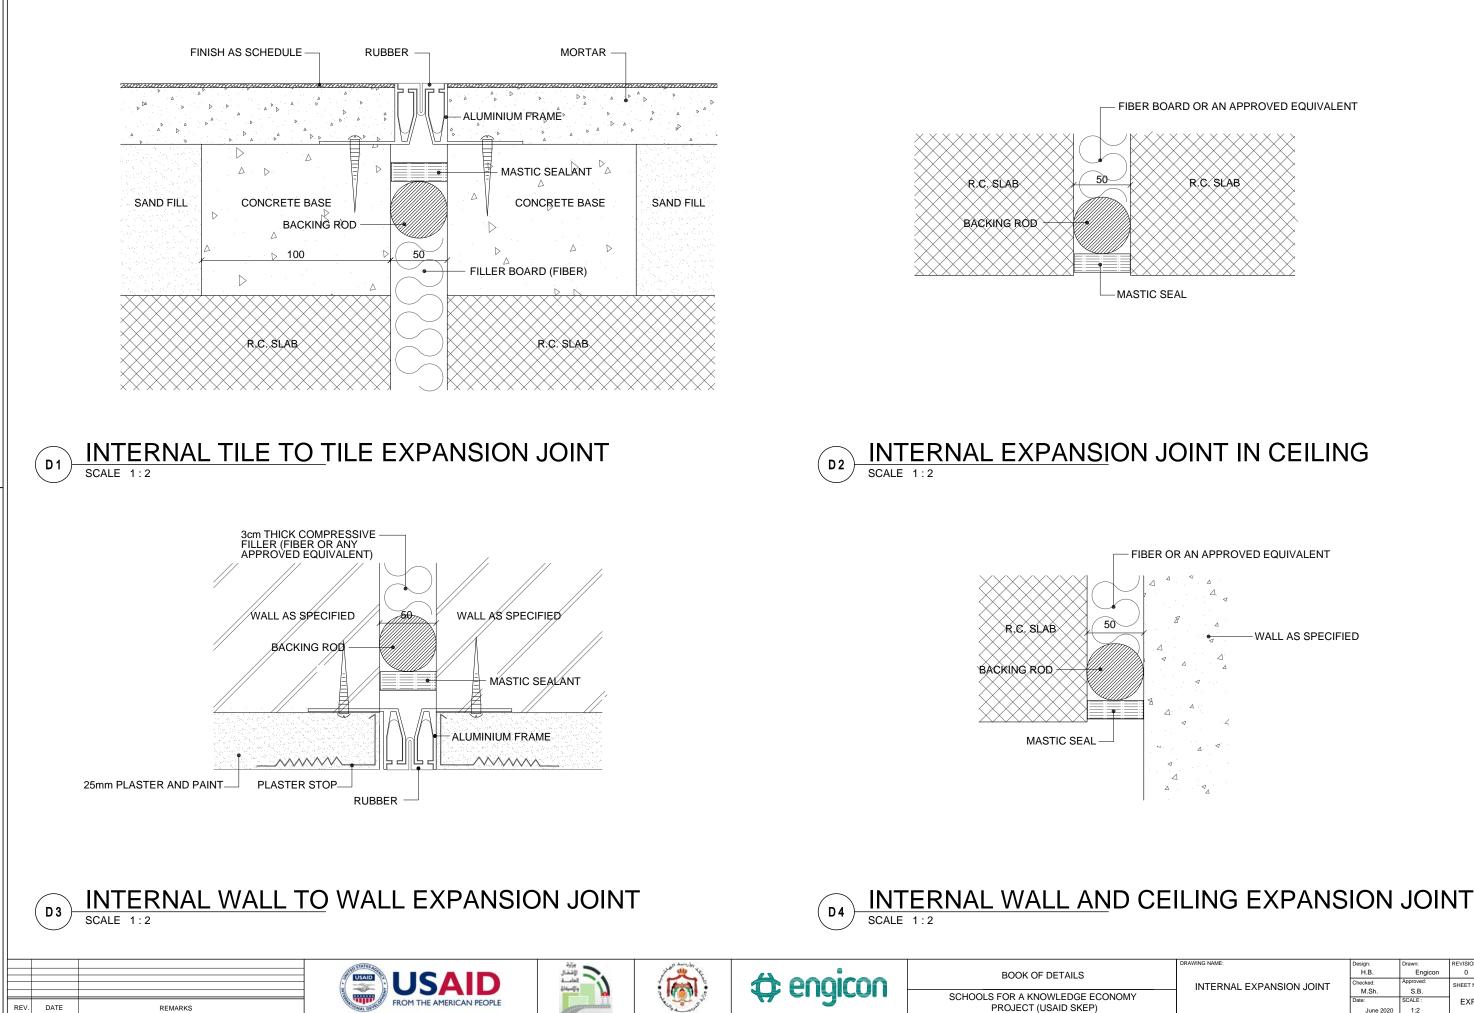

DRAWING NAME:	Design:	Drawn:	REVISION No. :
	H.B.	Engicon	0
INTERNAL EXPANSION JOINT	Checked:	Approved:	SHEET NUMBER:
INTERNAL EXPANSION JOINT	M.Sh.	S.B.	
	Date:	SCALE :	EXP-02
	June 2020	1:2	

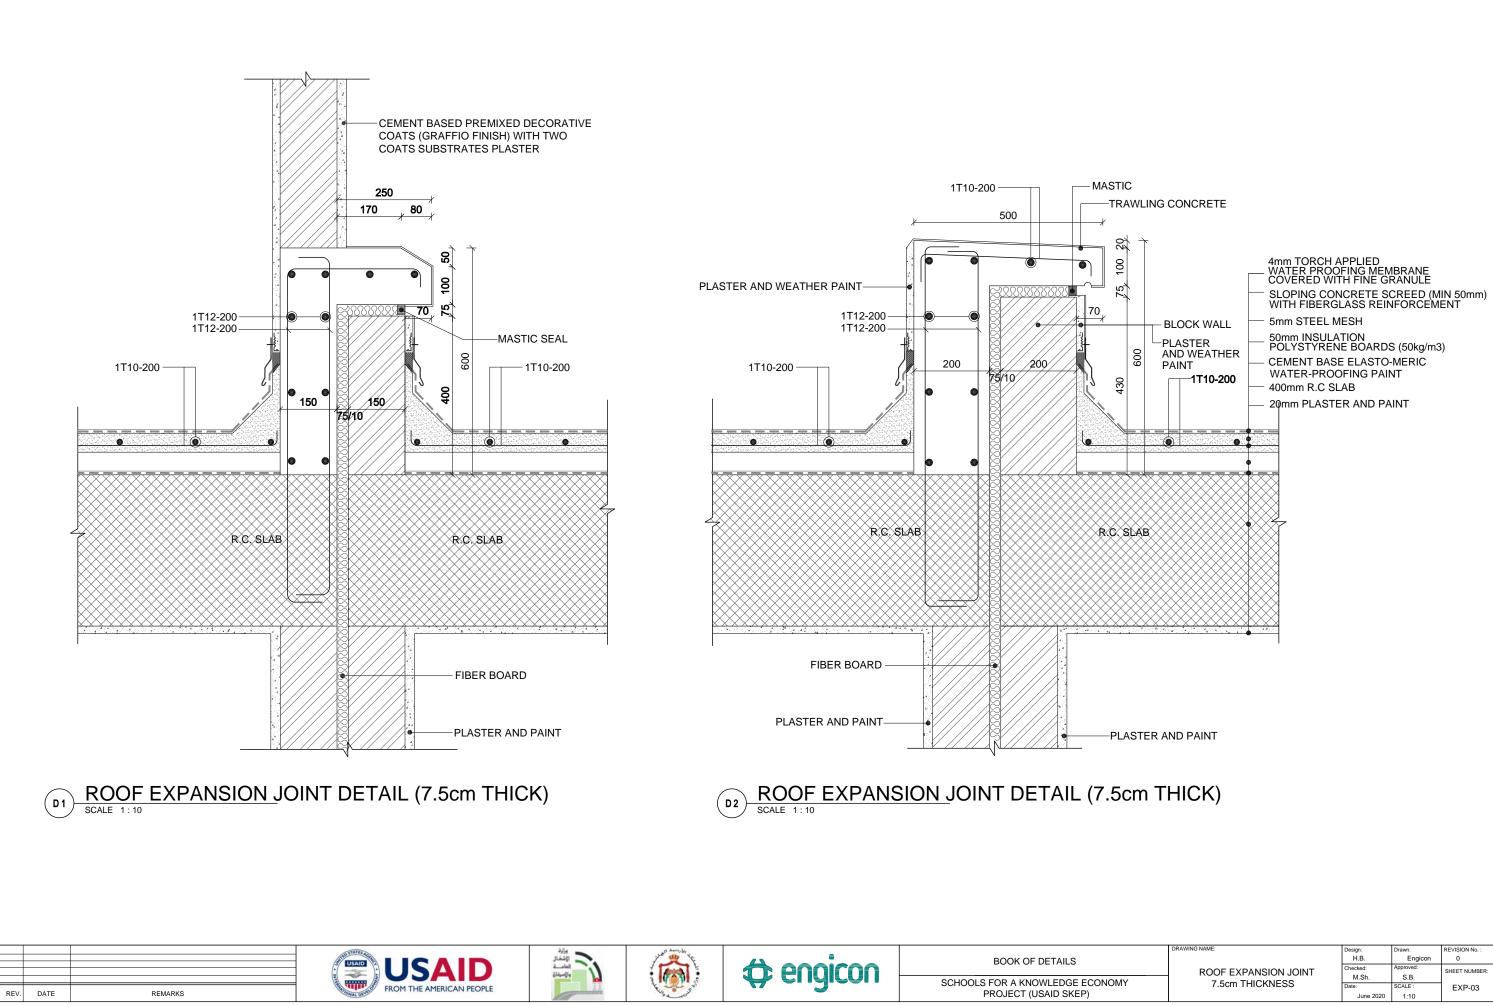



DRAWING NAME:	Design: H.B.	Drawn: Engicon	REVISION No. : 0	
	Checked: M.Sh.	Approved: S.B.	SHEET NUMBER:	
7.5cm THICKNESS	Date: June 2020	SCALE : 1:10	EXP-03	

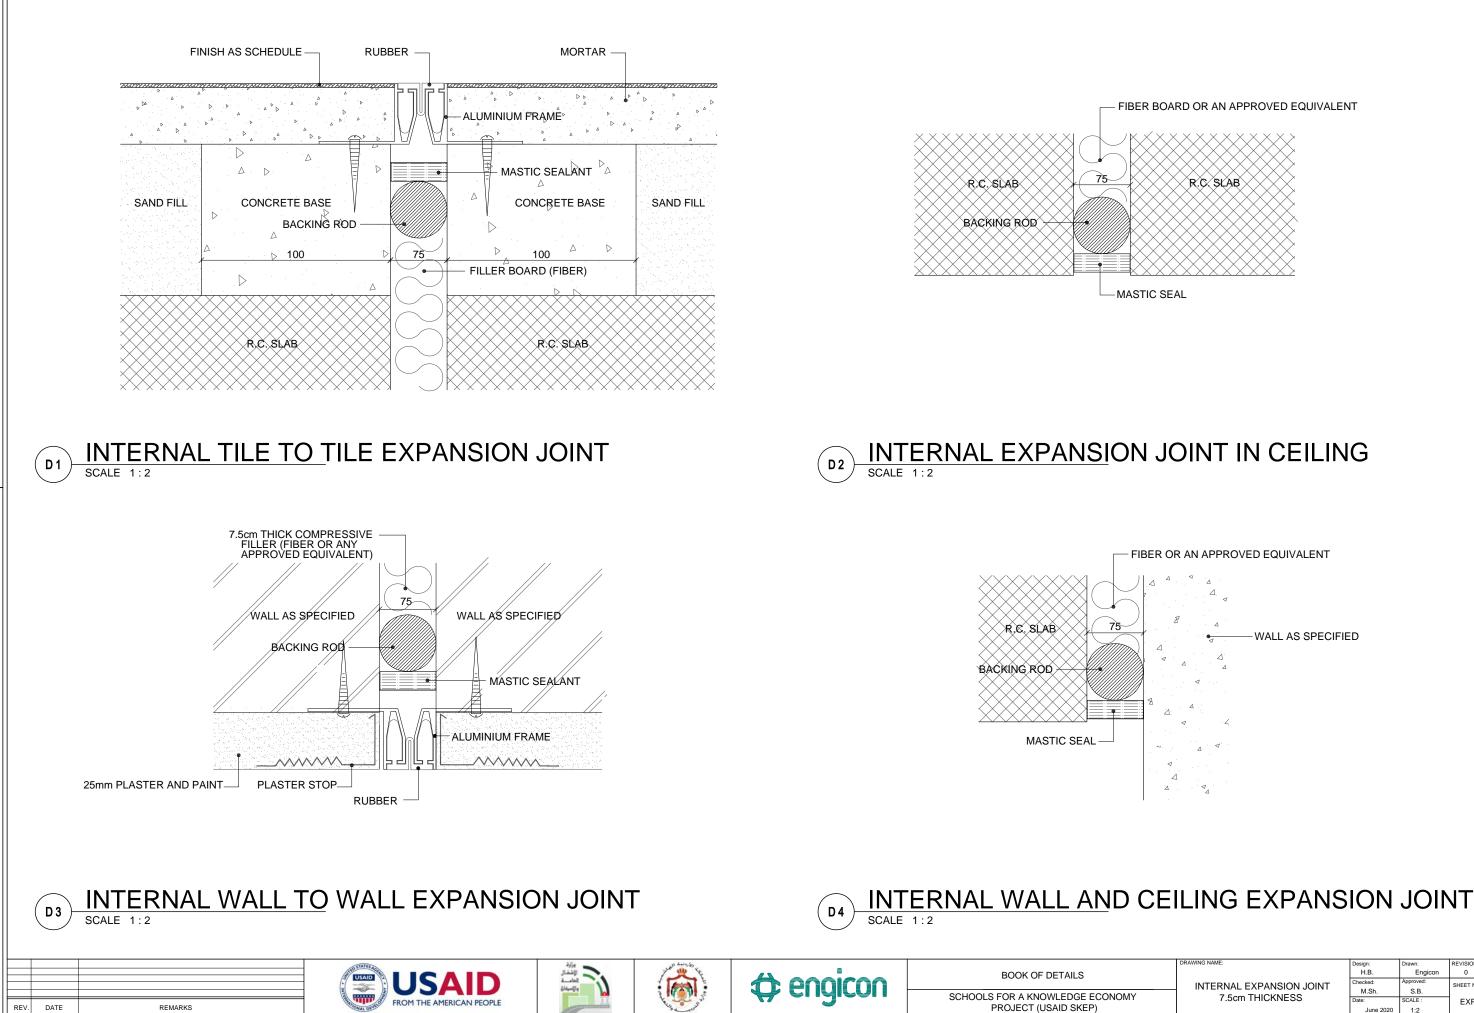

		-	
DRAWING NAME:	Design:	Drawn:	REVISION No. :
	H.B.	Engicon	0
INTERNAL EXPANSION JOINT	Checked:	Approved:	SHEET NUMBER
	M.Sh.	S.B.	
7.5CM THICKNESS	Date:	SCALE :	EXP-04
	June 2020	1:2	
	DRAWING NAME: INTERNAL EXPANSION JOINT 7.5cm THICKNESS	INTERNAL EXPANSION JOINT 7.5cm THICKNESS	INTERNAL EXPANSION JOINT 7.5cm THICKNESS

BUILDING DETAILS MISCELLANEOUS DETAILS

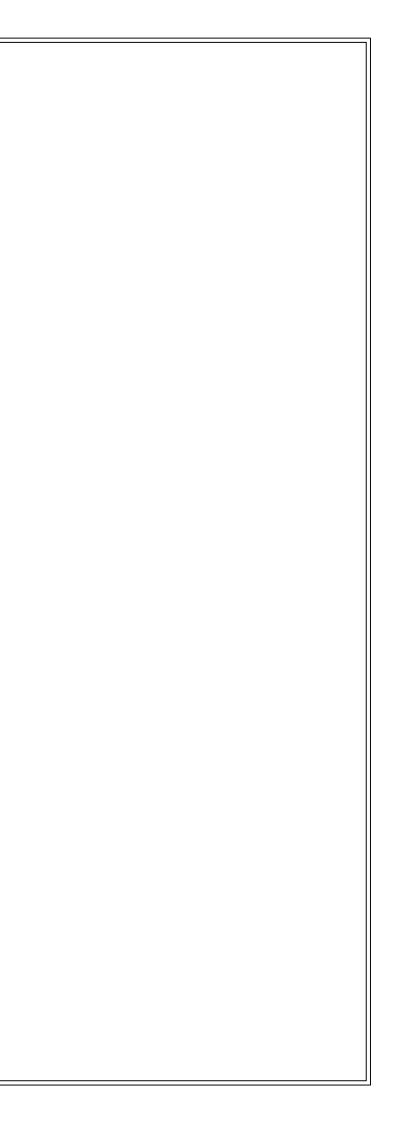

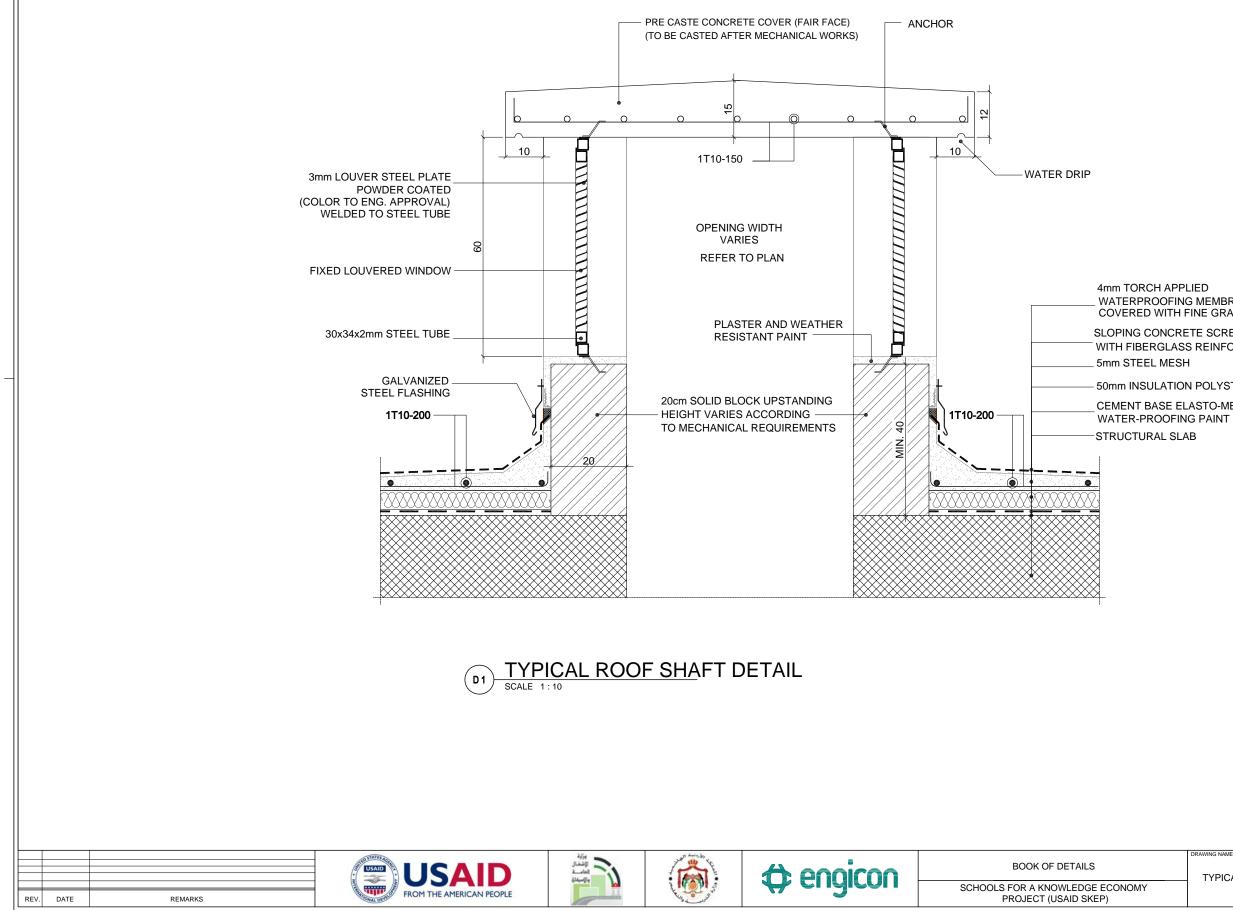


WATERPROOFING MEMBRANE COVERED WITH FINE GRANULE


SLOPING CONCRETE SCREED (MIN. 50mm) WITH FIBERGLASS REINFORCEMENT

- 50mm INSULATION POLYSTYRENE BOARDS (50kg/m3)


CEMENT BASE ELASTO-MERIC


DRAWING NAME:	Design:	Drawn:	REVISION No. :
	H.B.	Engicon	0
TYPICAL ROOF SHAFT DETAIL	Checked:	Approved:	SHEET NUMBER:
 TTFICAL ROOF SHAFT DETAIL	M.Sh.	S.B.	
	Date:	SCALE :	MCD-01
	June 2020	1:10	

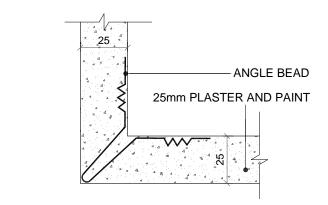

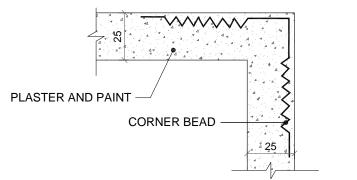

 $\Delta \sim 0$

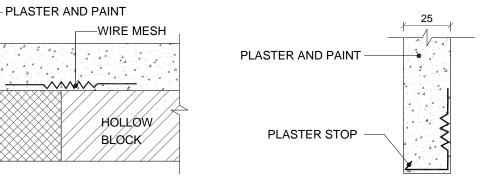

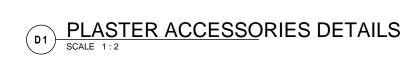



REV. DATE

REMARKS



25


R.C.







BOOK OF DETAILS


	DRAWING NAME:	Design:	Drawn:	REVISION No. :
		H.B.	Engicon	0
	PLASTER ACCESSORIES DETAILS	Checked:	Approved:	SHEET NUMBER:
		M.Sh.	S.B.	
		Date:	SCALE :	MCD-02
		June 2020	1:2	

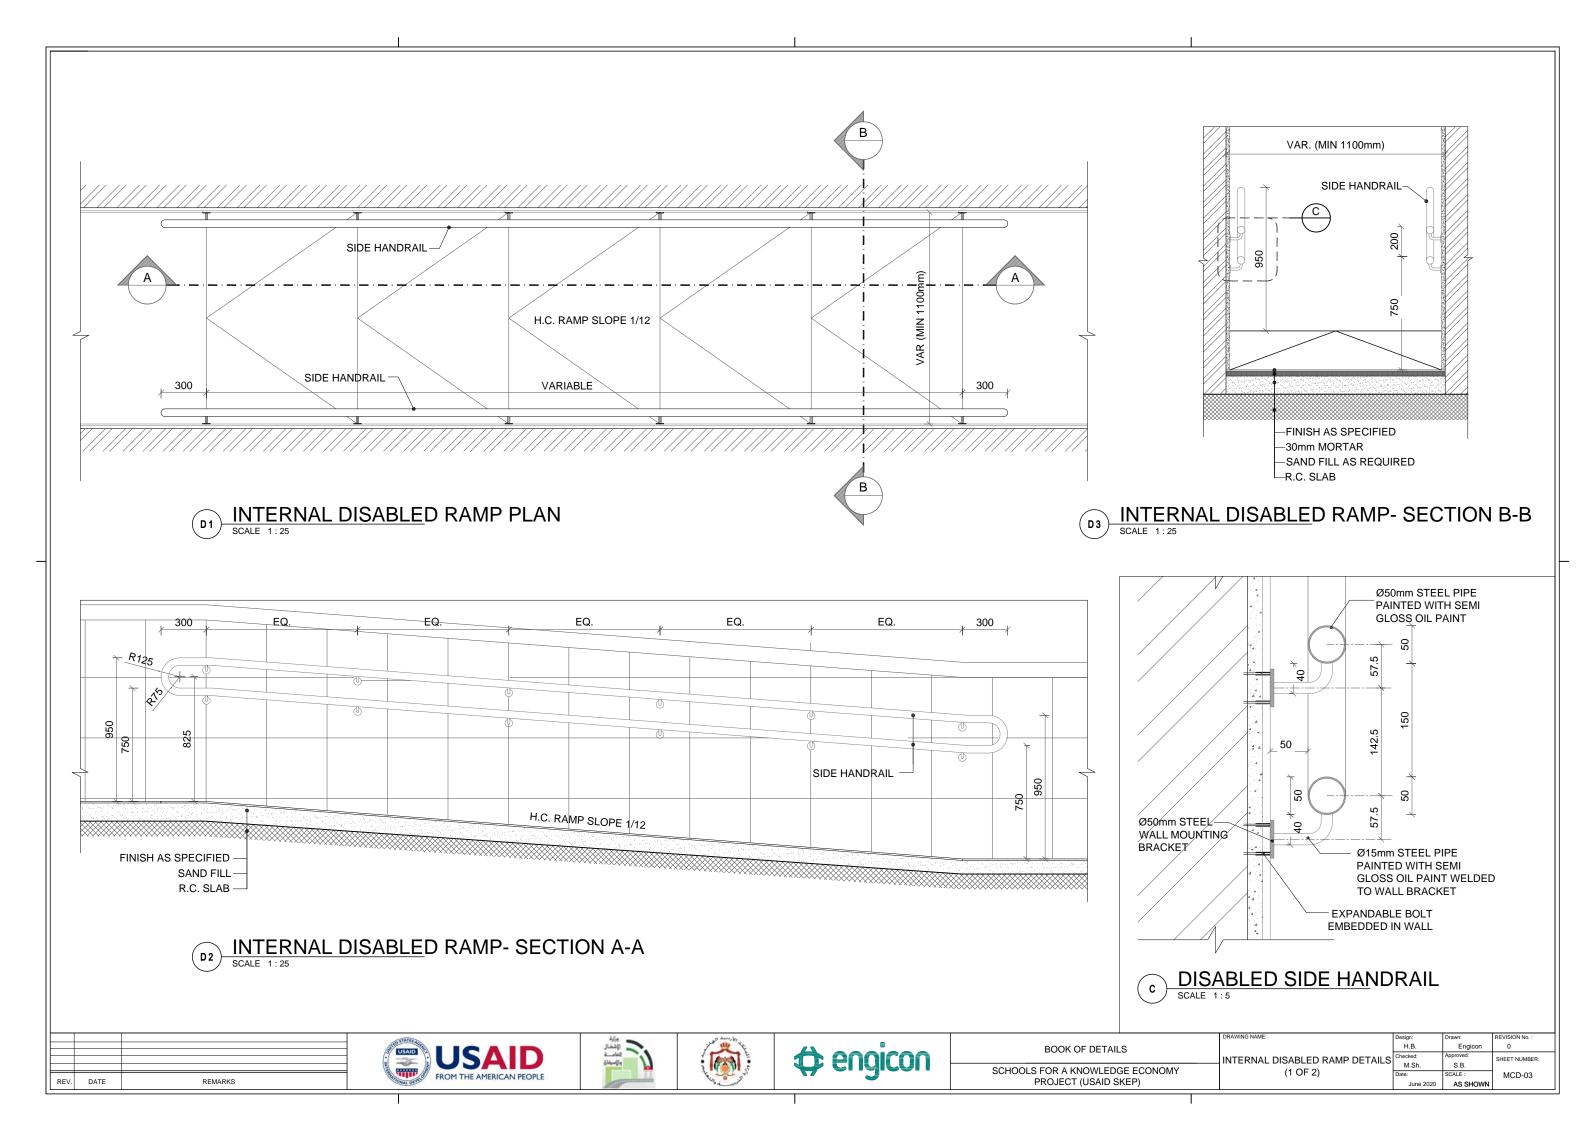

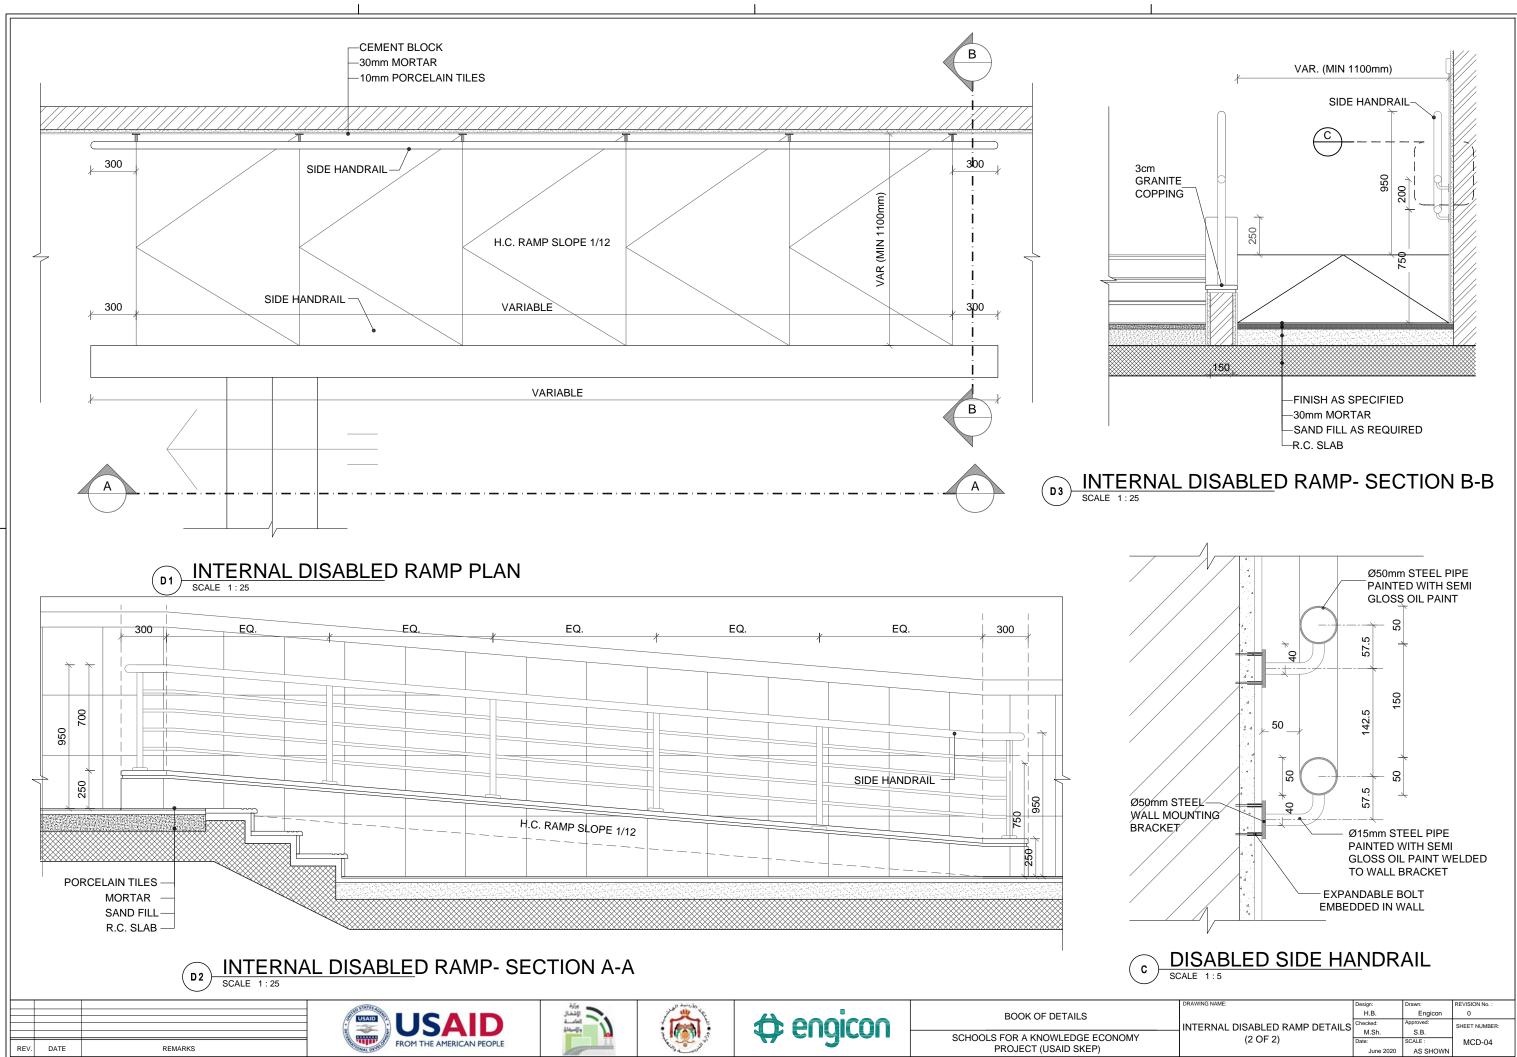



	DRAWING NAME:	Design:	Drawn:	REVISION No. :
	INTERNAL DISABLED RAMP DETAILS	H.B.	Engicon	0
		Checked:	Approved:	SHEET NUMBER:
		M.Sh.	S.B.	GHEET HOMBER
		Date:	SCALE :	MCD-04
		June 2020	AS SHOWN	

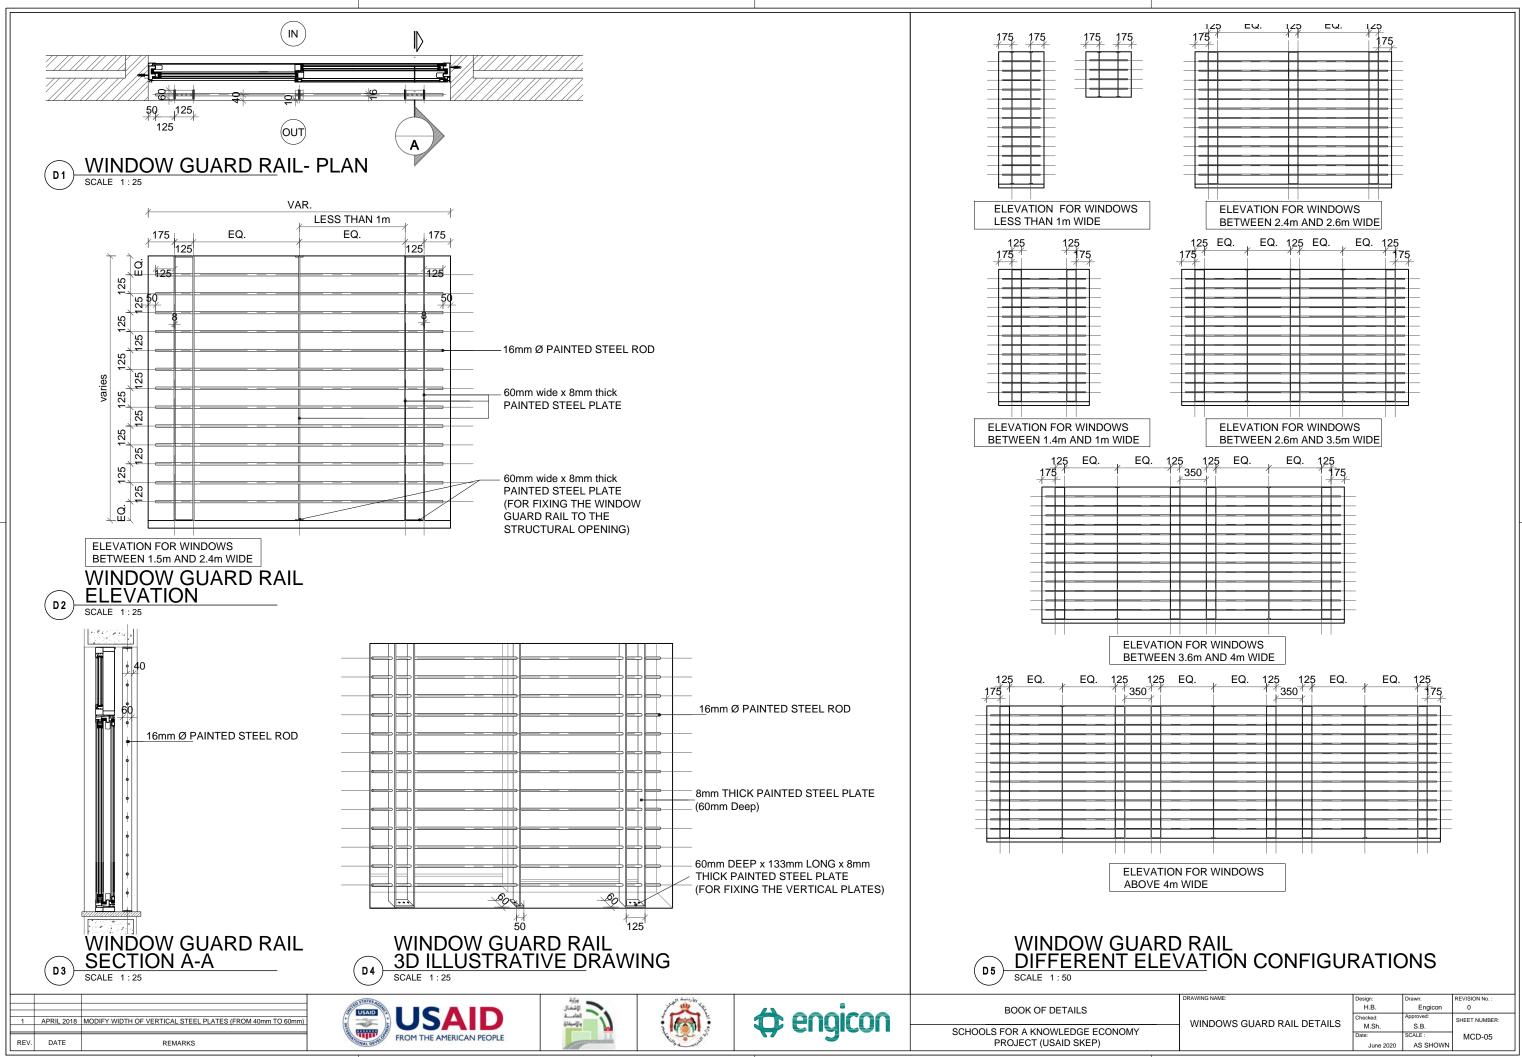

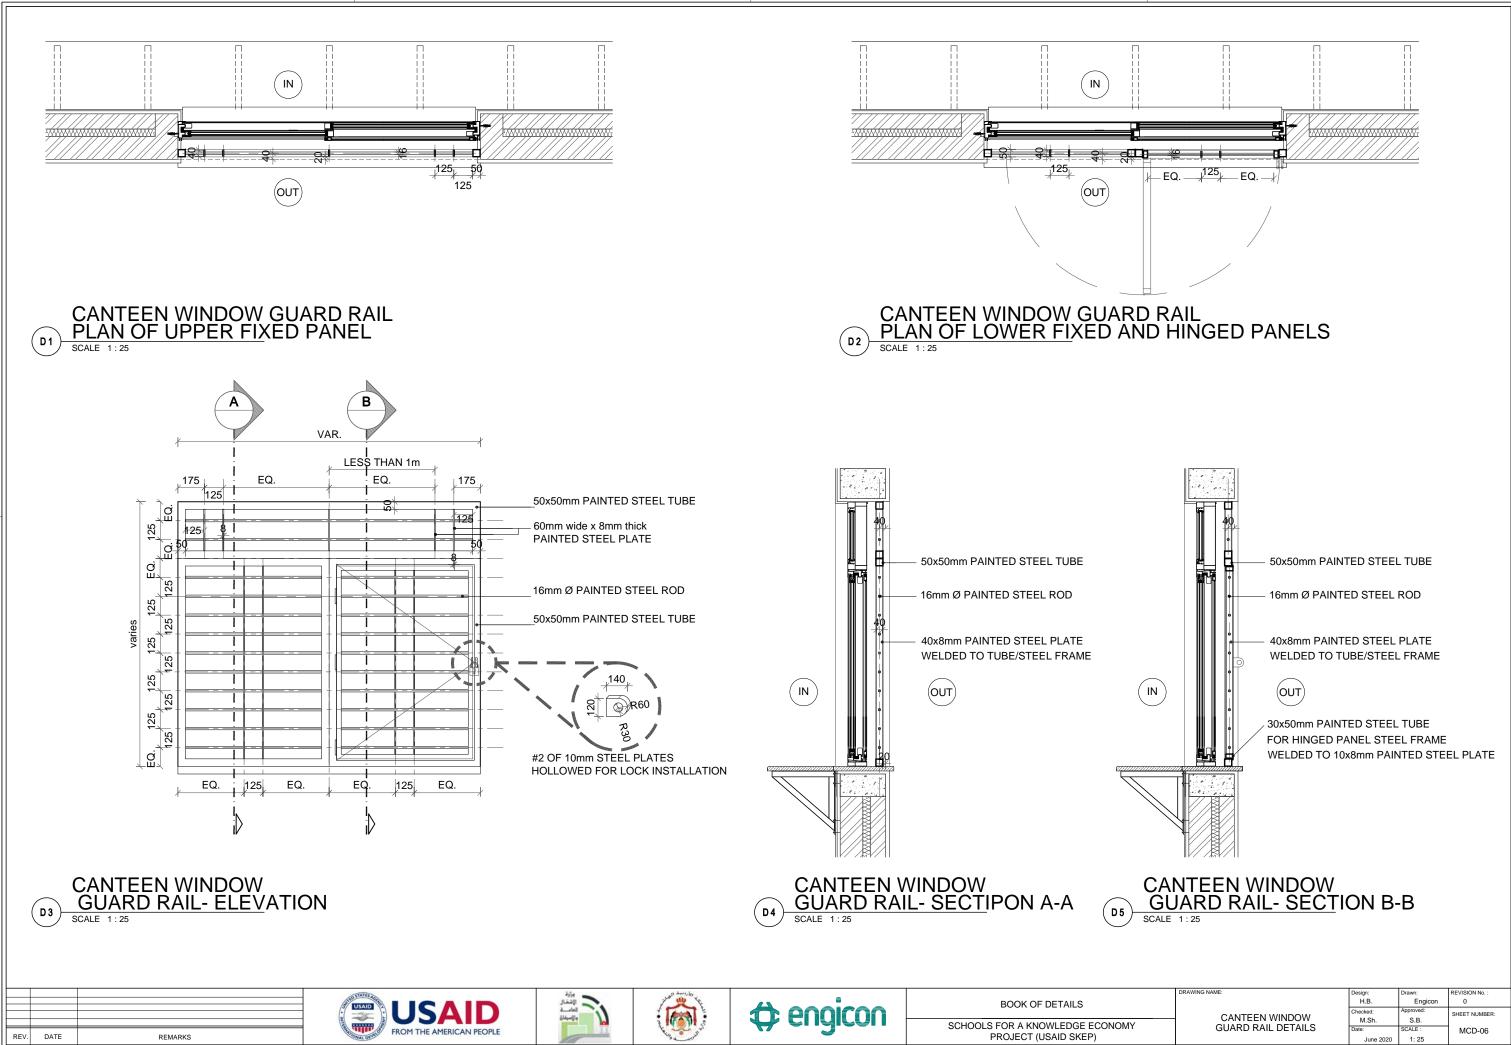

DRAWING NAME:	Design:	Drawn:	REVISION No. :
	H.B.	Engicon	0
	Checked:	Approved:	SHEET NUMBER:
CANTEEN WINDOW	M.Sh.	S.B.	
GUARD RAIL DETAILS	Date:	SCALE :	MCD-06
	June 2020	1: 25	

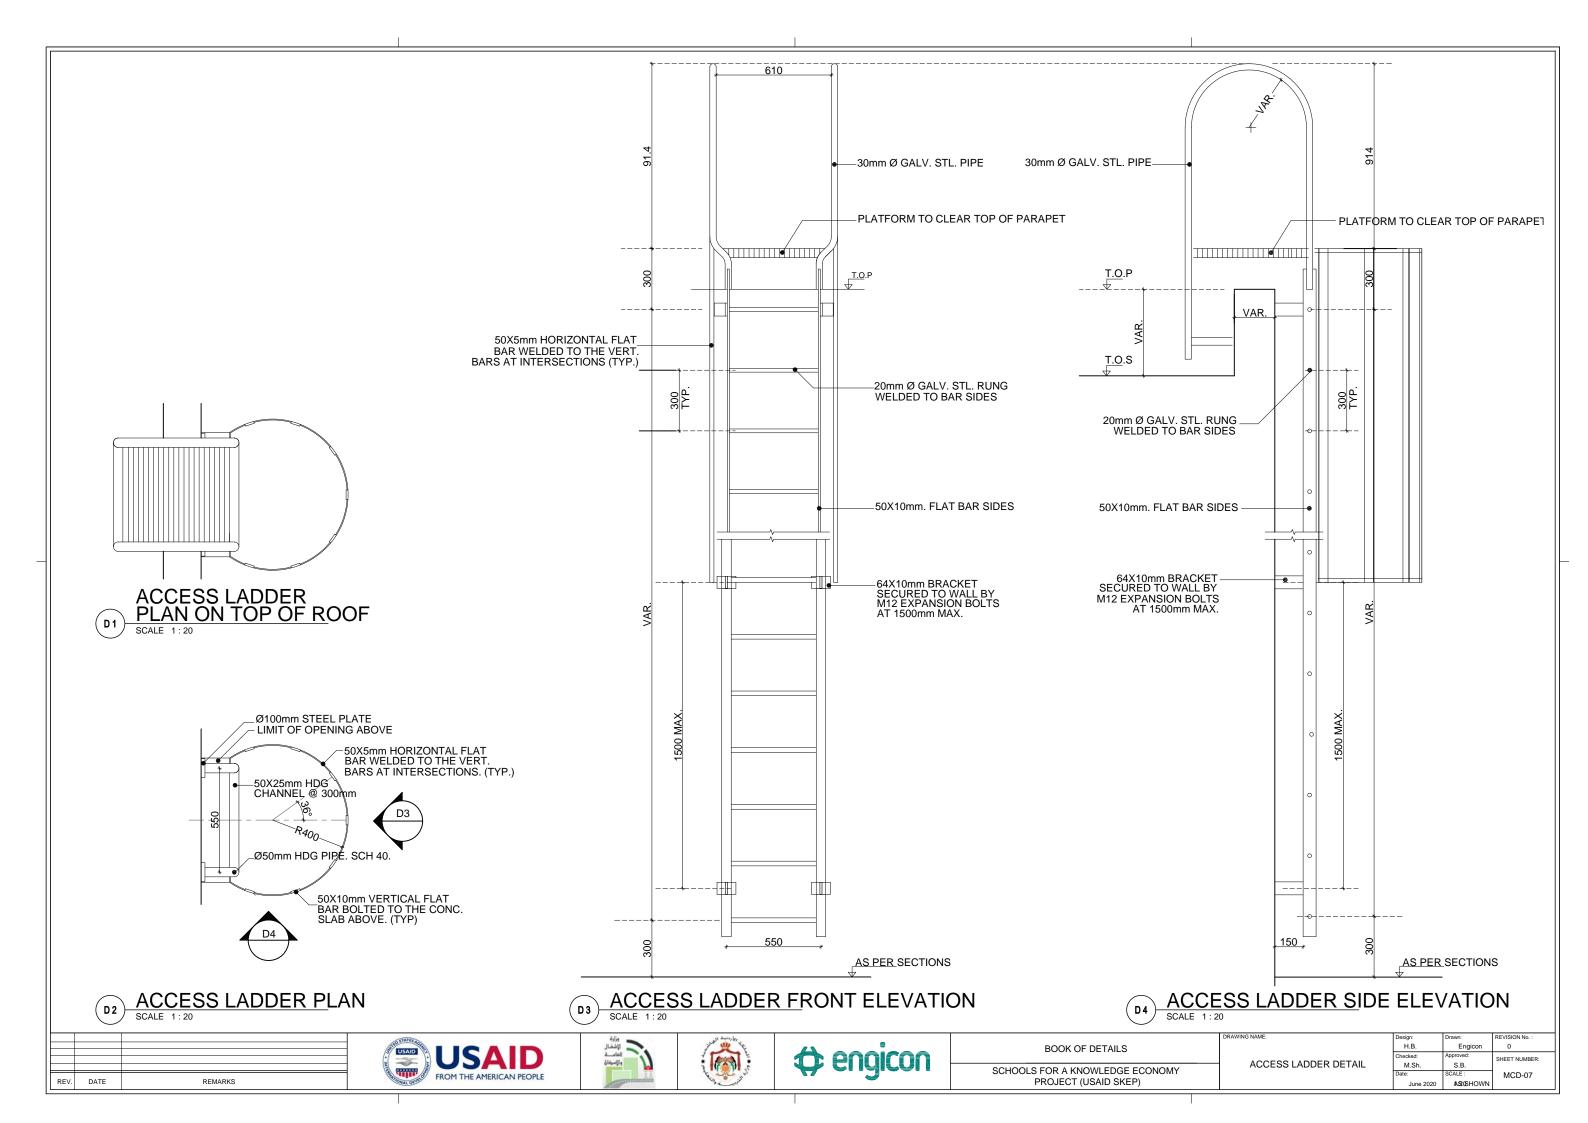


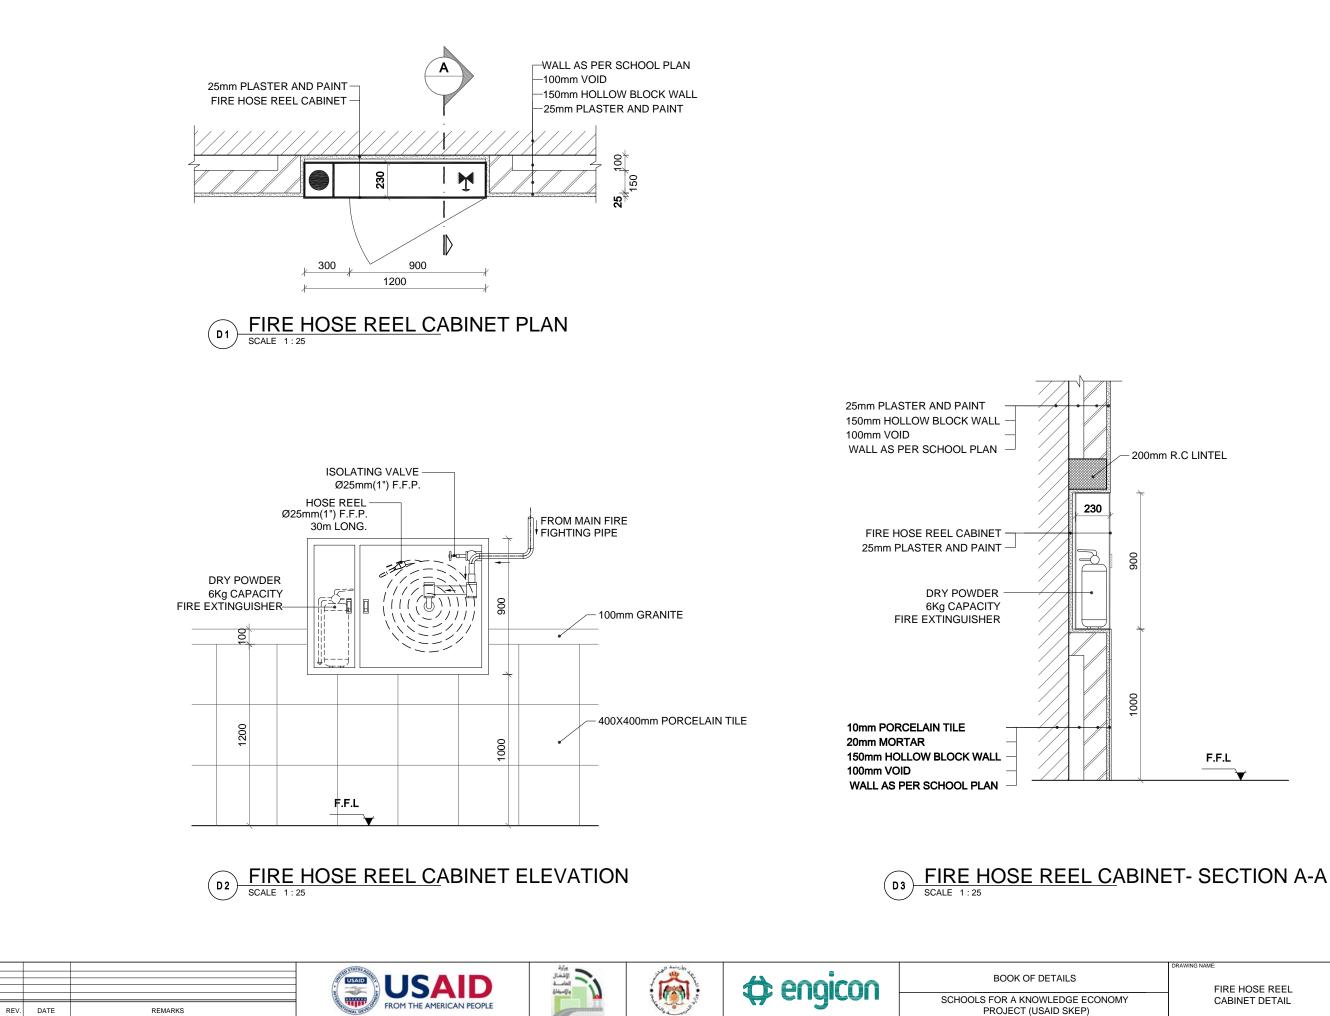


- 200mm R.C LINTEL

F.F.L

DRAWING NAME:	Design:	Drawn:	REVISION No. :
	H.B.	Engicon	0
FIRE HOSE REEL	Checked:	Approved:	SHEET NUMBER:
 	M.Sh.	S.B.	
CABINET DETAIL	Date:	SCALE :	MCD-08
	June 2020	1: 25	

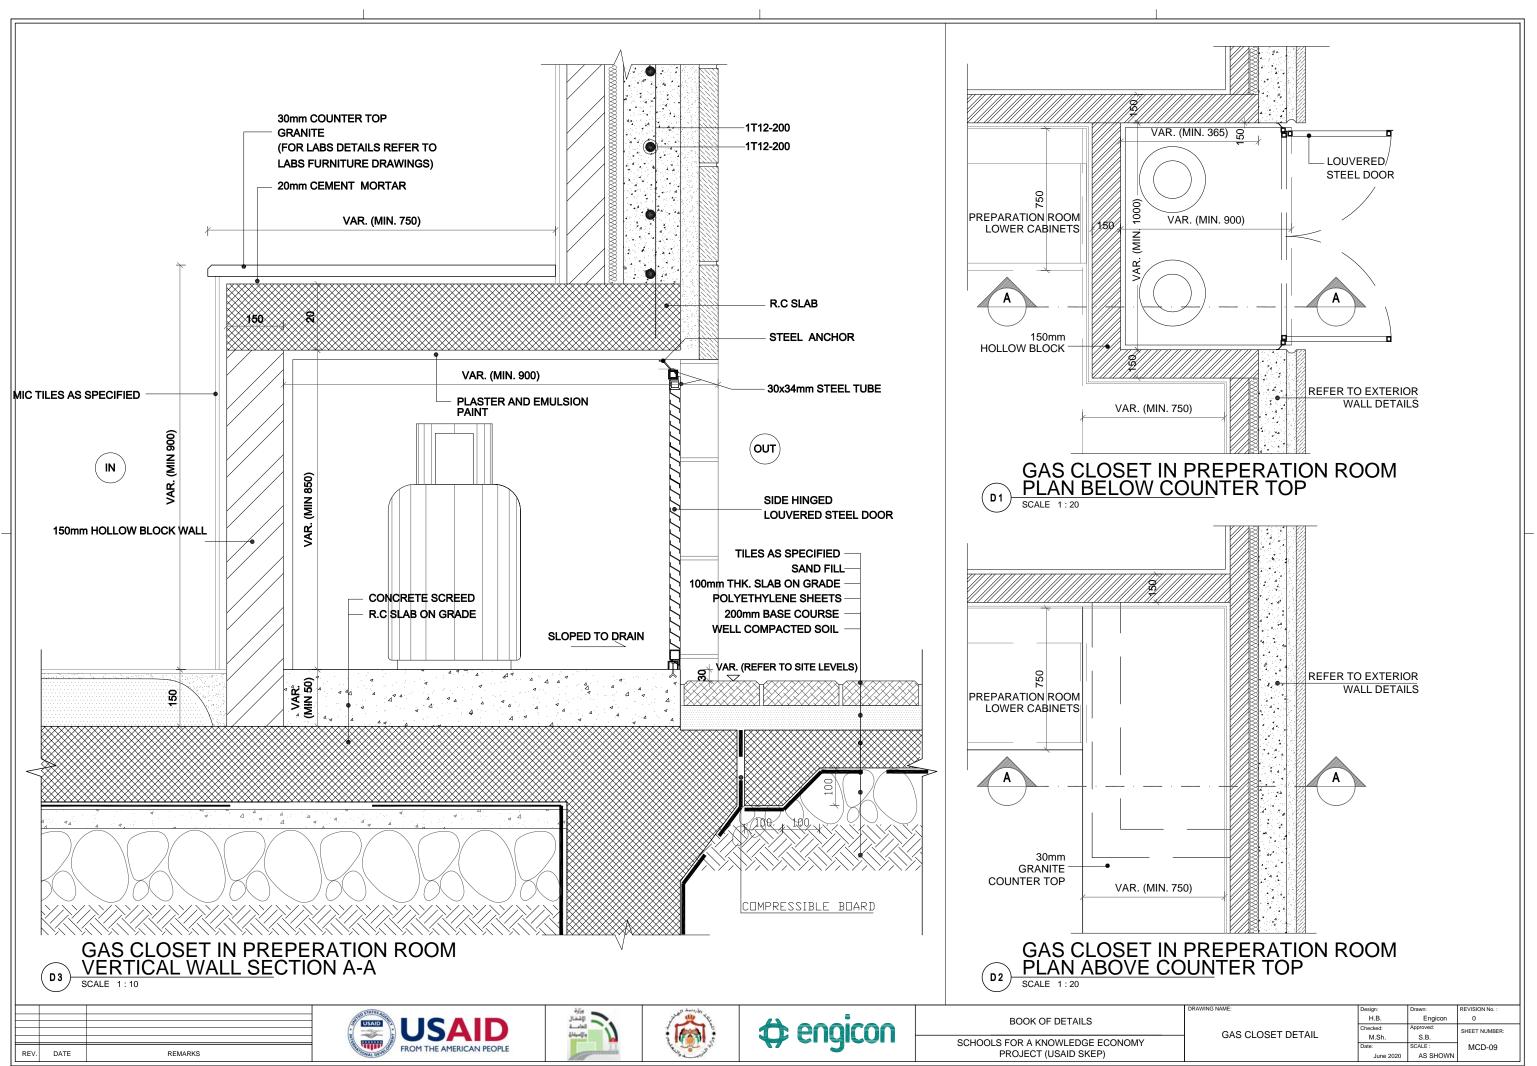


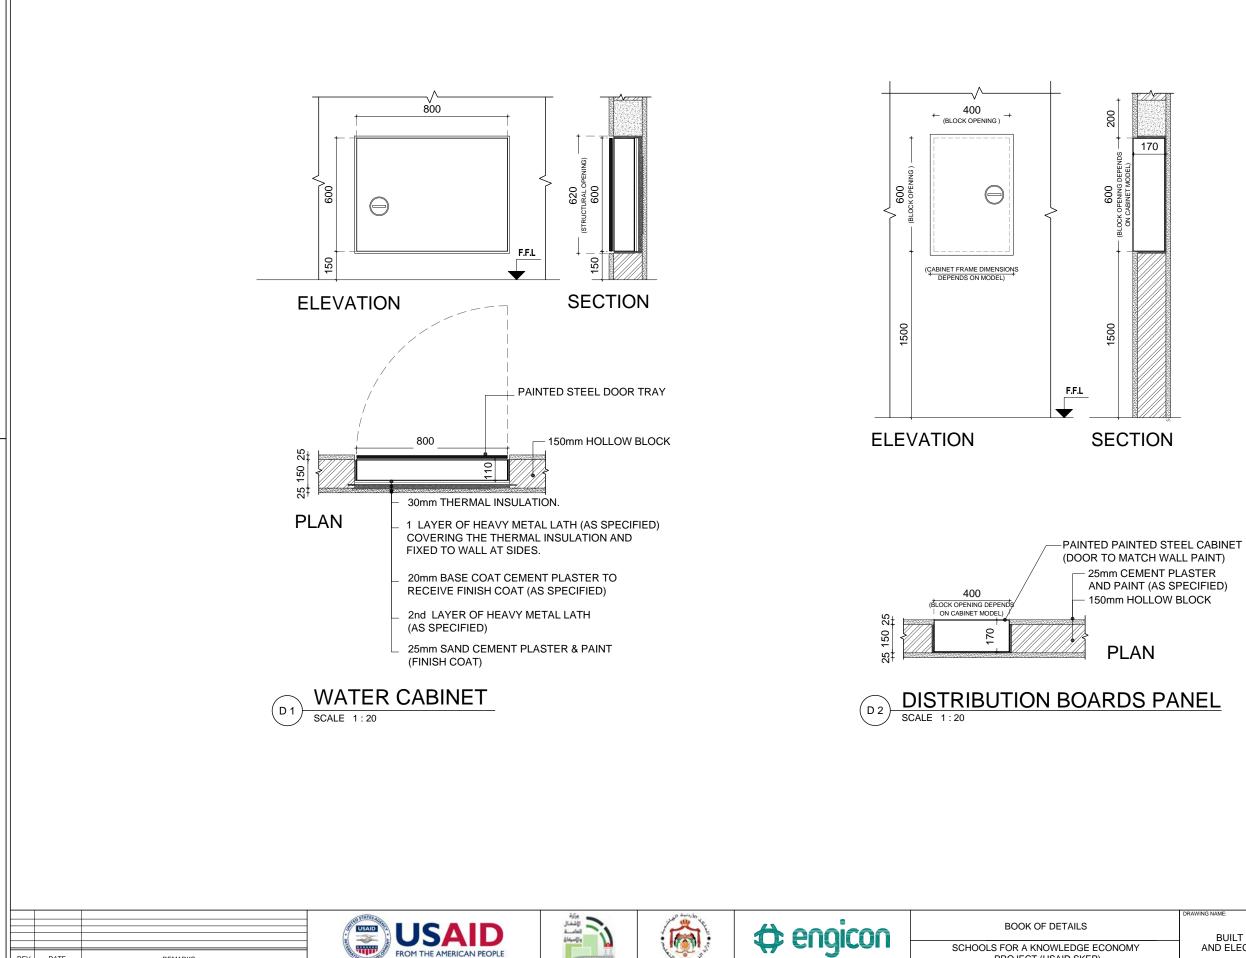

REV. DATE

REMARKS


DRAWING NAME:	Design:	Drawn:	REVISION No. :
	H.B.	Engicon	0
BUILT IN MECHANICAL	Checked:	Approved:	SHEET NUMBER:
AND ELECTRICAL CABINETS	M.Sh.	S.B.	
AND ELECTRICAL CADINETS	Date:	SCALE :	MCD-10
	June 2020	1:20	

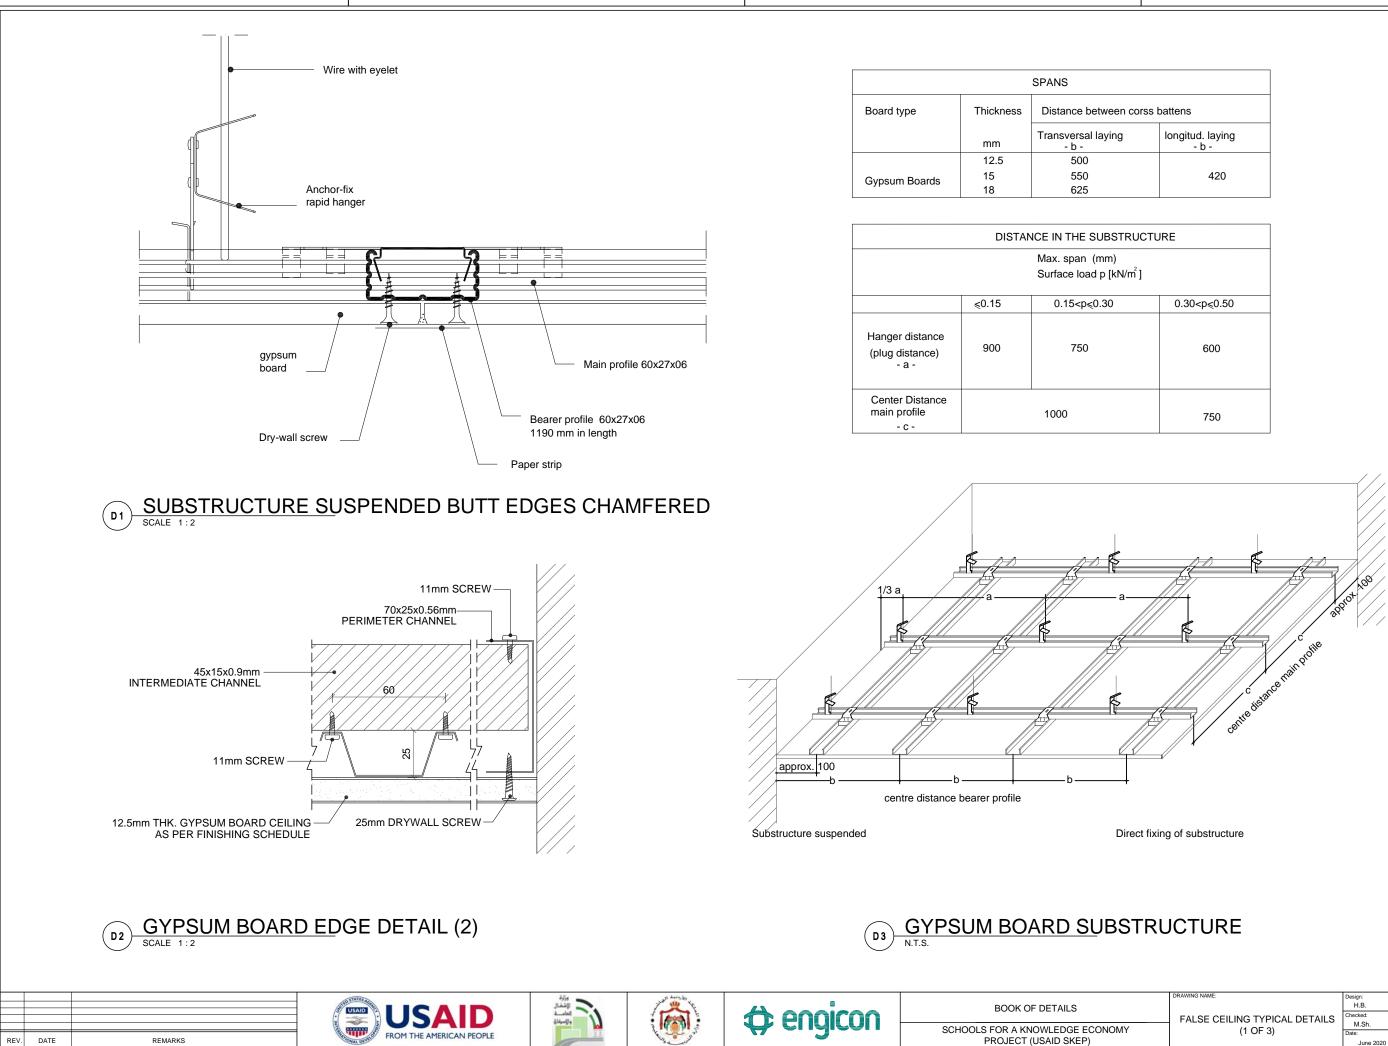



DRAWING NAME:	Design:	Drawn:	REVISION No. :
	Н.В.	Engicon	0
FALSE CEILING TYPICAL DETAILS	Checked:	Approved:	SHEET NUMBER:
	M.Sh.	S.B.	
(1 OF 3)	Date:	SCALE :	MCD-11
	June 2020	AS SHOWN	


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	600
	750

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	longitud. laying - b -
	420

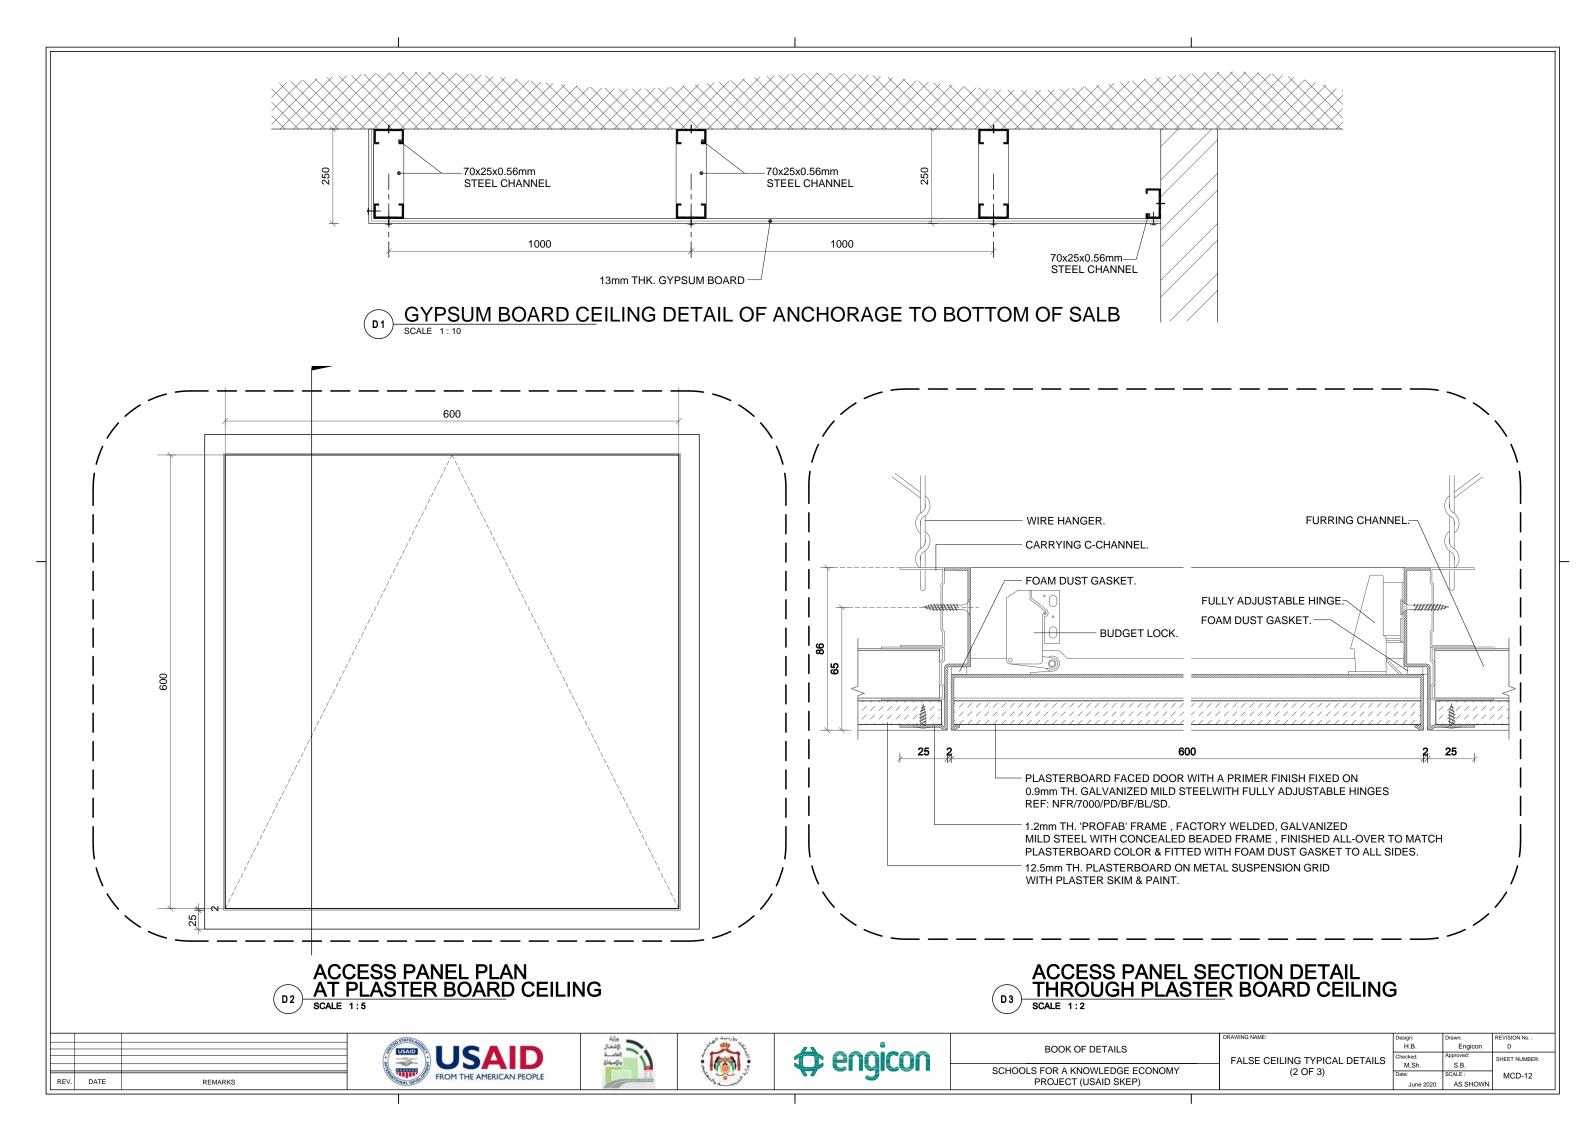


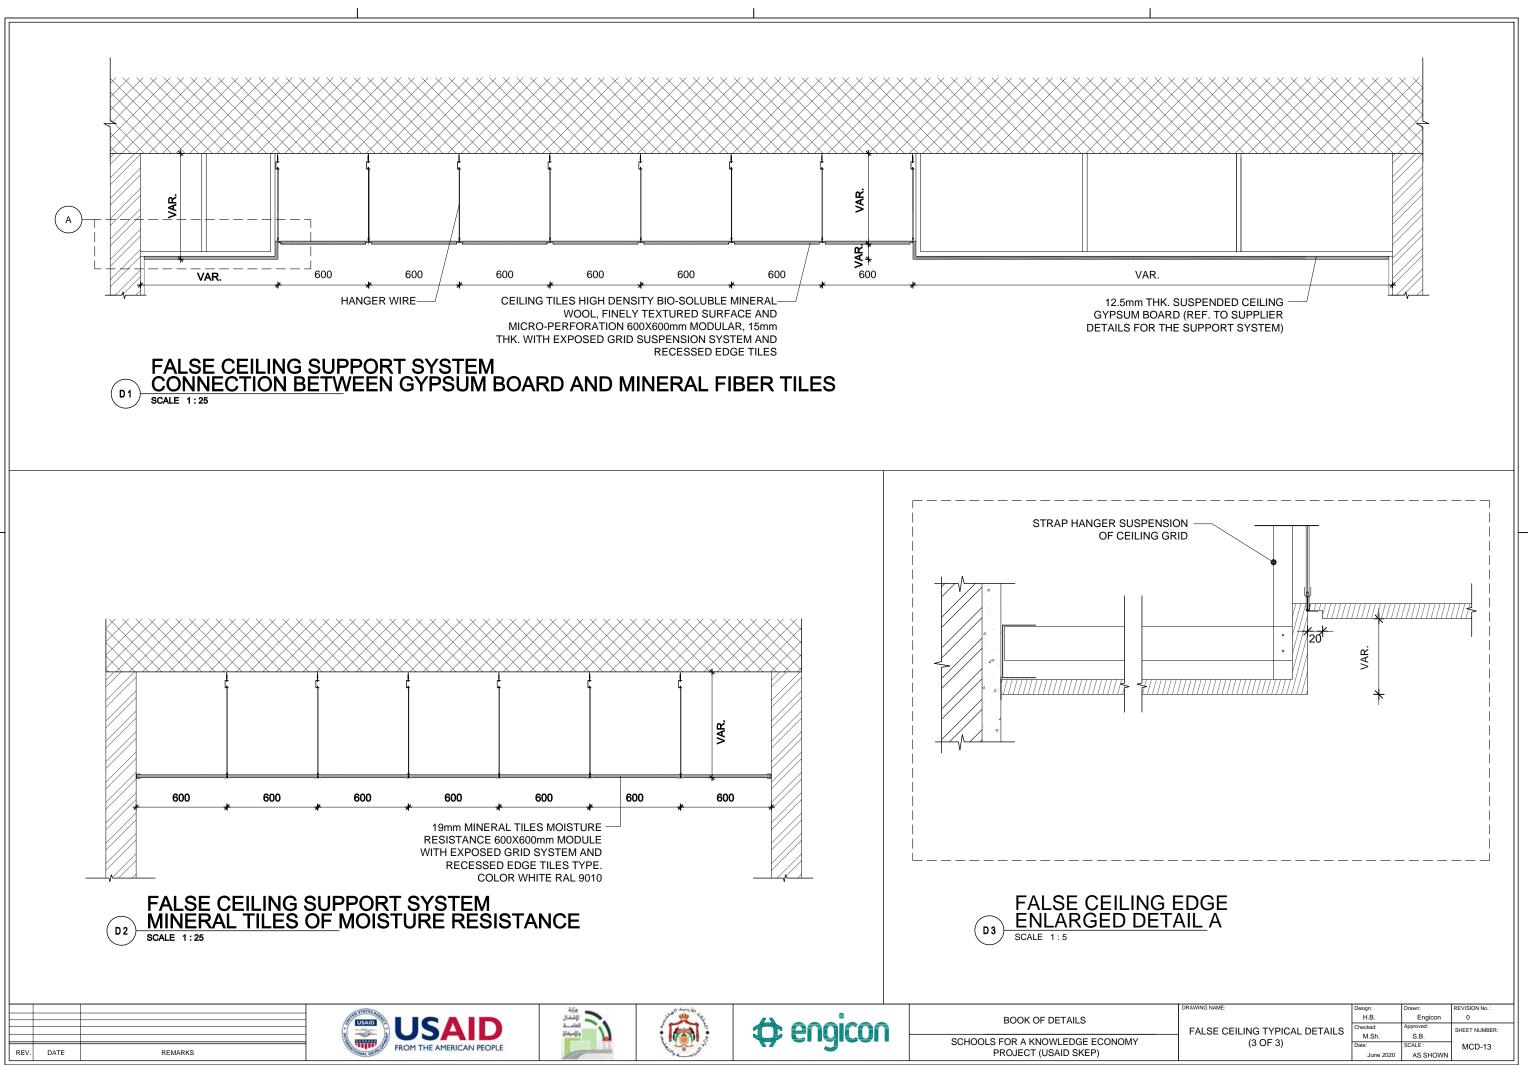

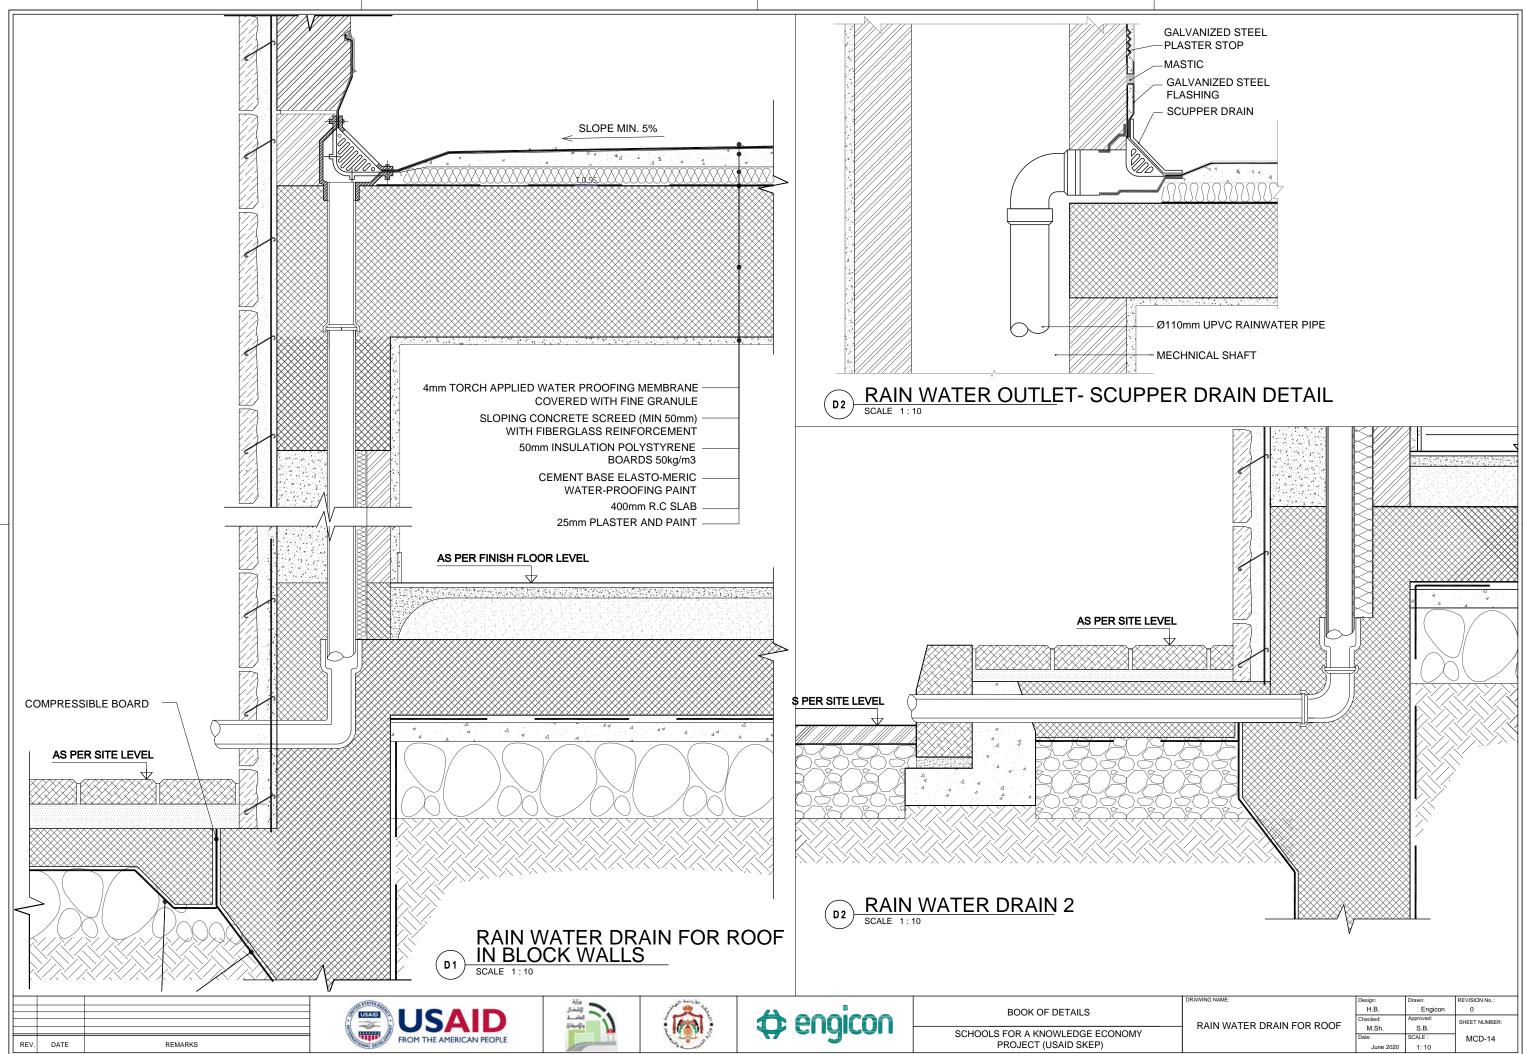


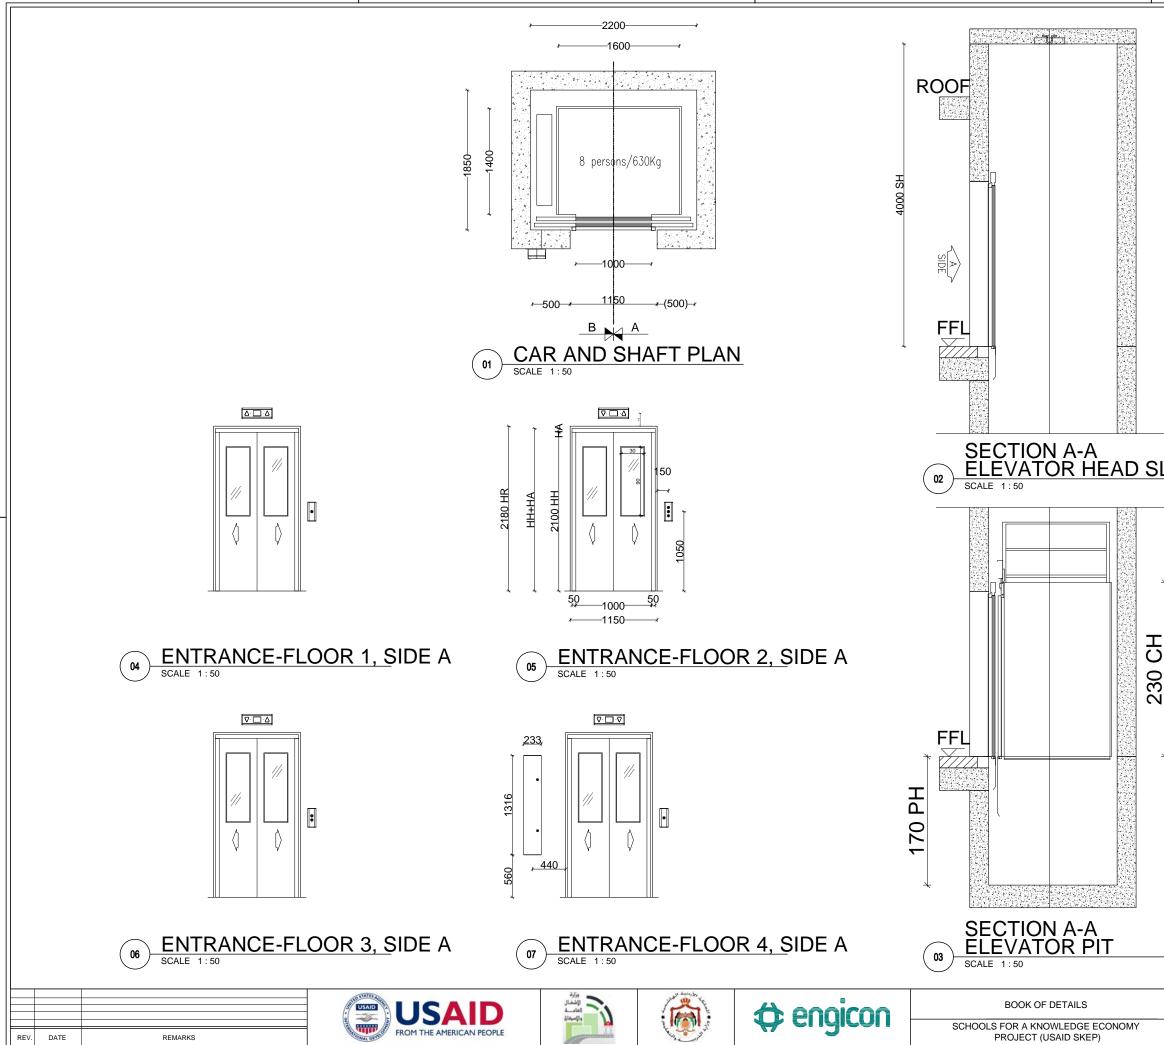



SLA	<u>B</u>			
	DRAWING NAME: TYPICAL ELEVATOR DETAIL WITH 1 ENTRANCE	Design: H.B. Checked: M.Sh. Date: June 2020	Drawn: Engicon Approved: S.B. SCALE : 1: 50	REVISION No. : 0 SHEET NUMBER: MCD-15

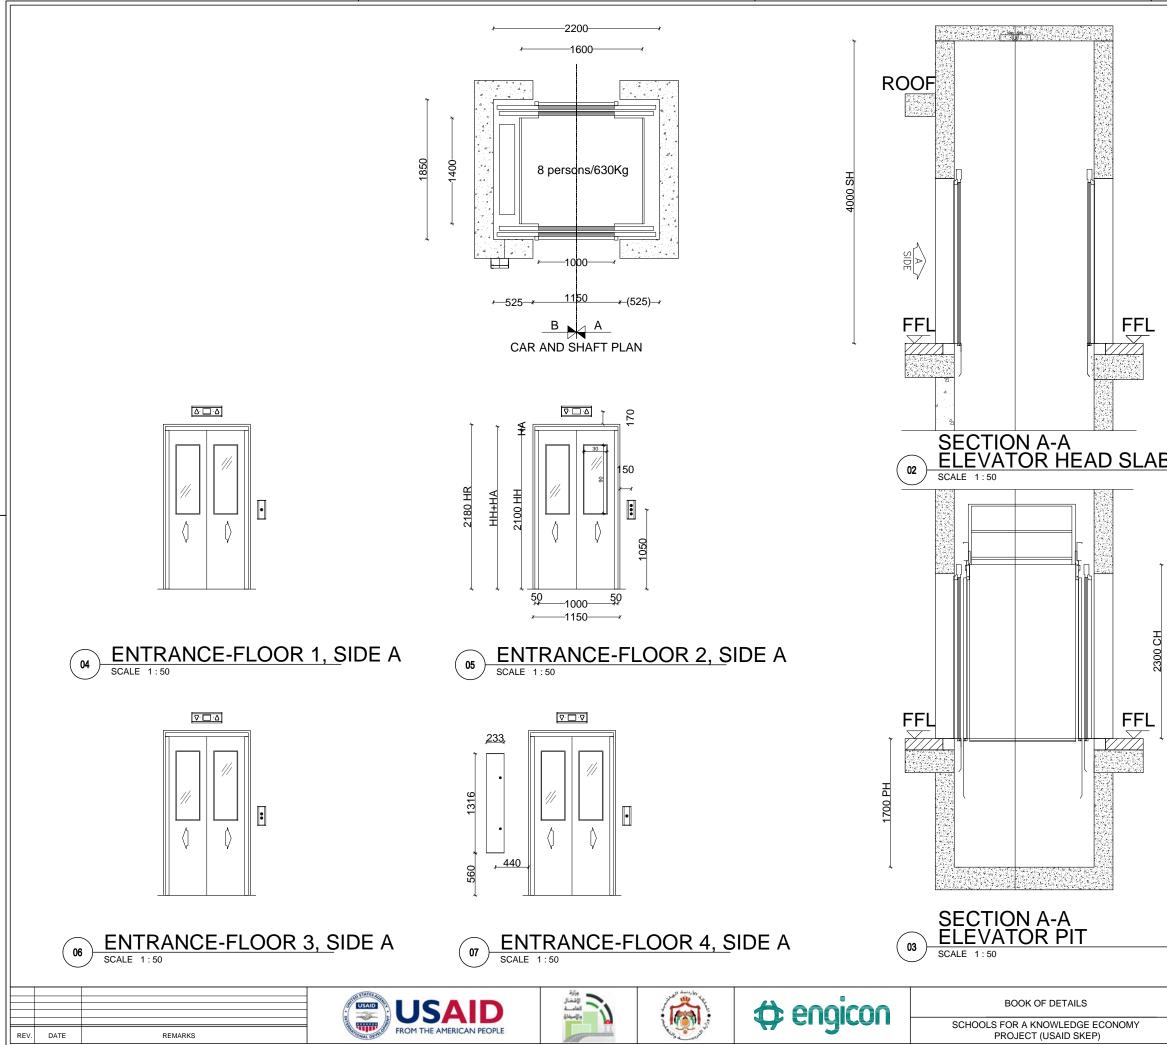



-	SDE			
∆B				
2300 CH	2425 E			
	DRAWING NAME:	Design: H.B.	Drawn: Engicon	REVISION No. : 0
	TYPICAL ELEVATOR DETAIL WITH 2 ENTRANCES	H.B. Checked: M.Sh. Date: June 2020	Engicon Approved: S.B. SCALE : 1: 50	0 SHEET NUMBER: MCD-16

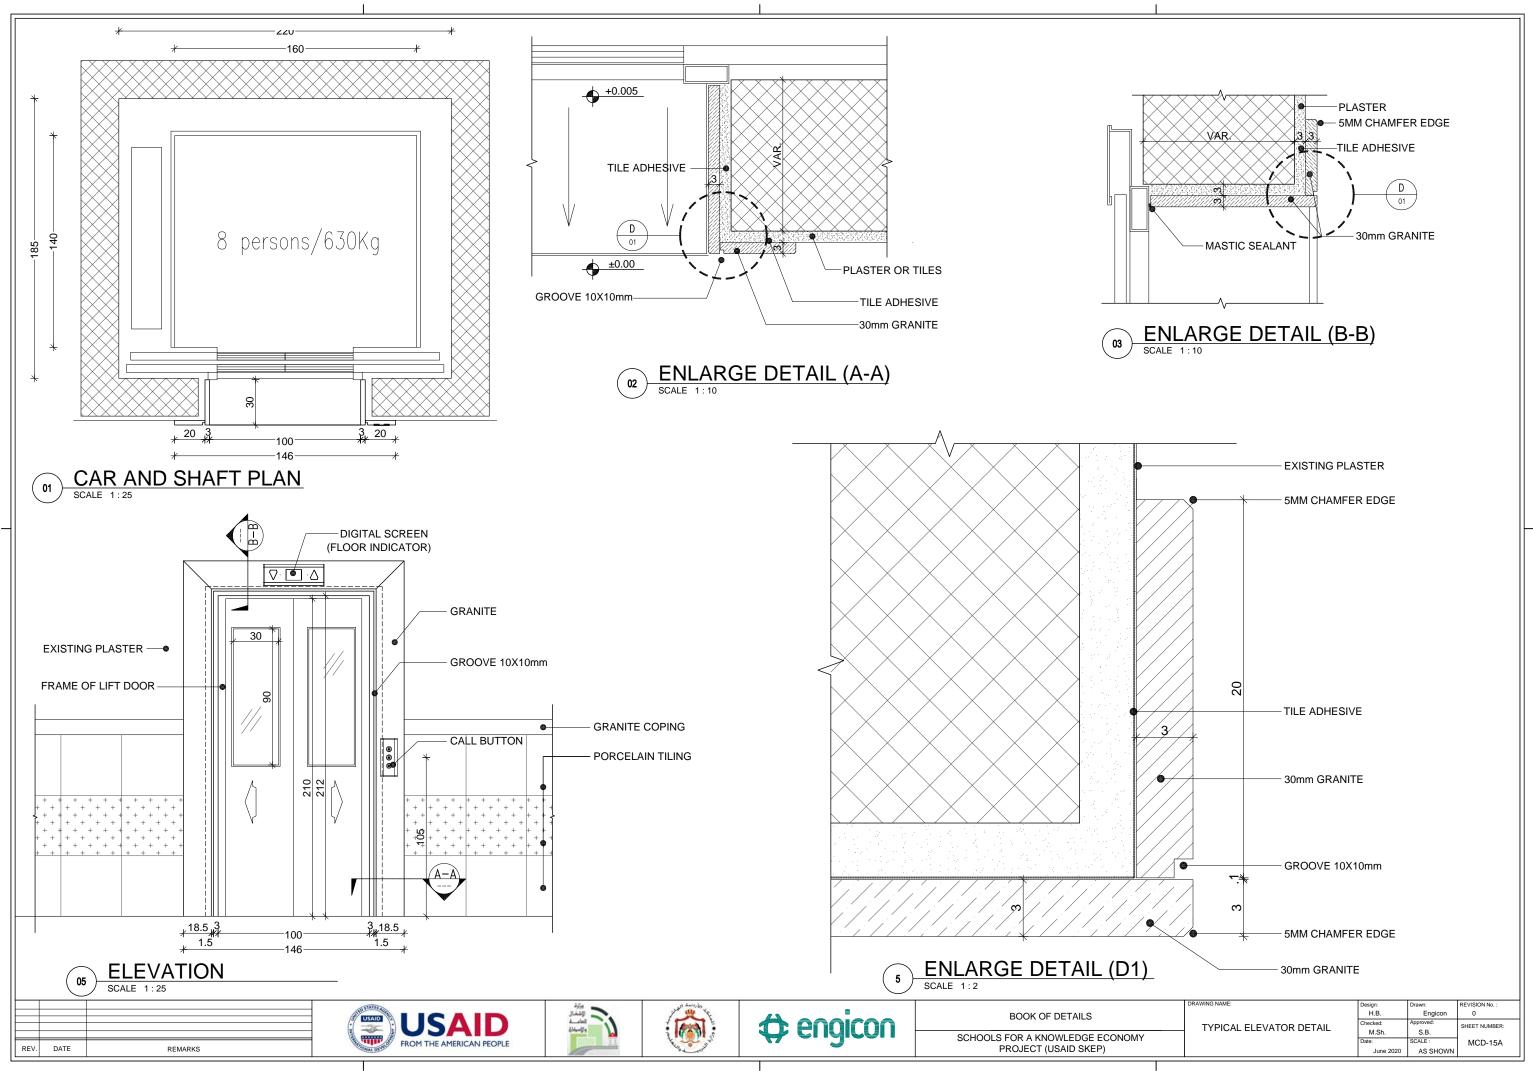


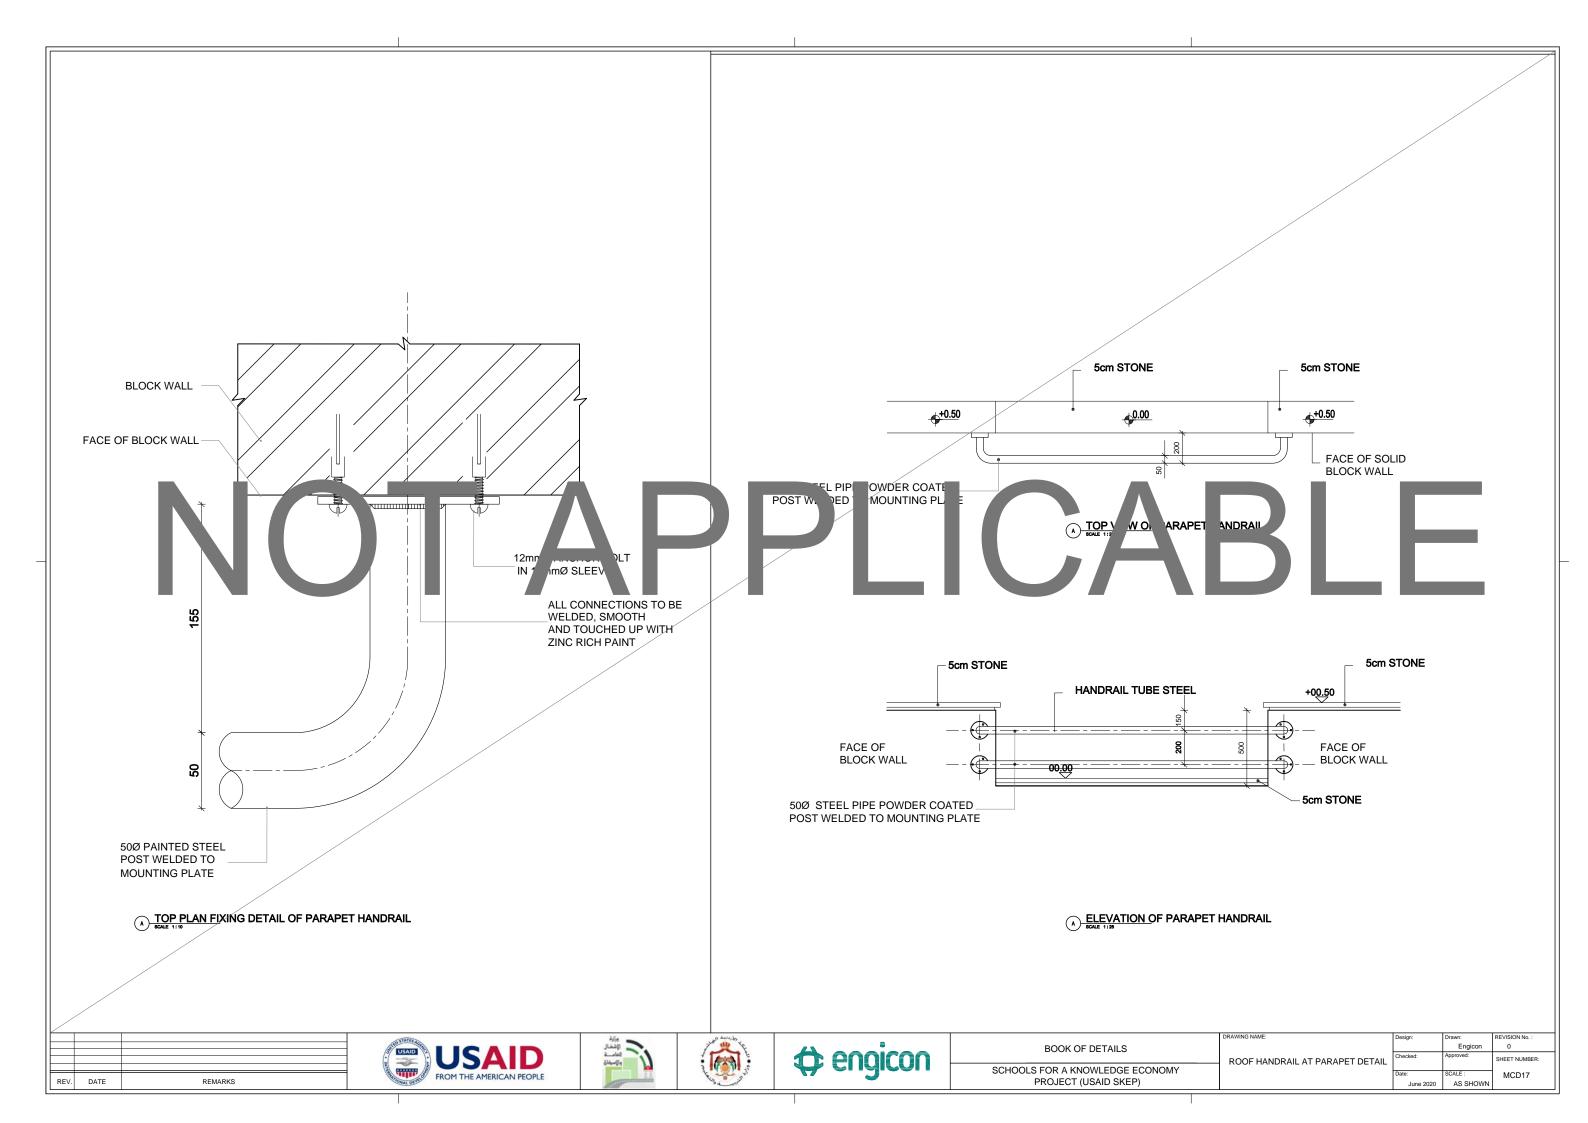

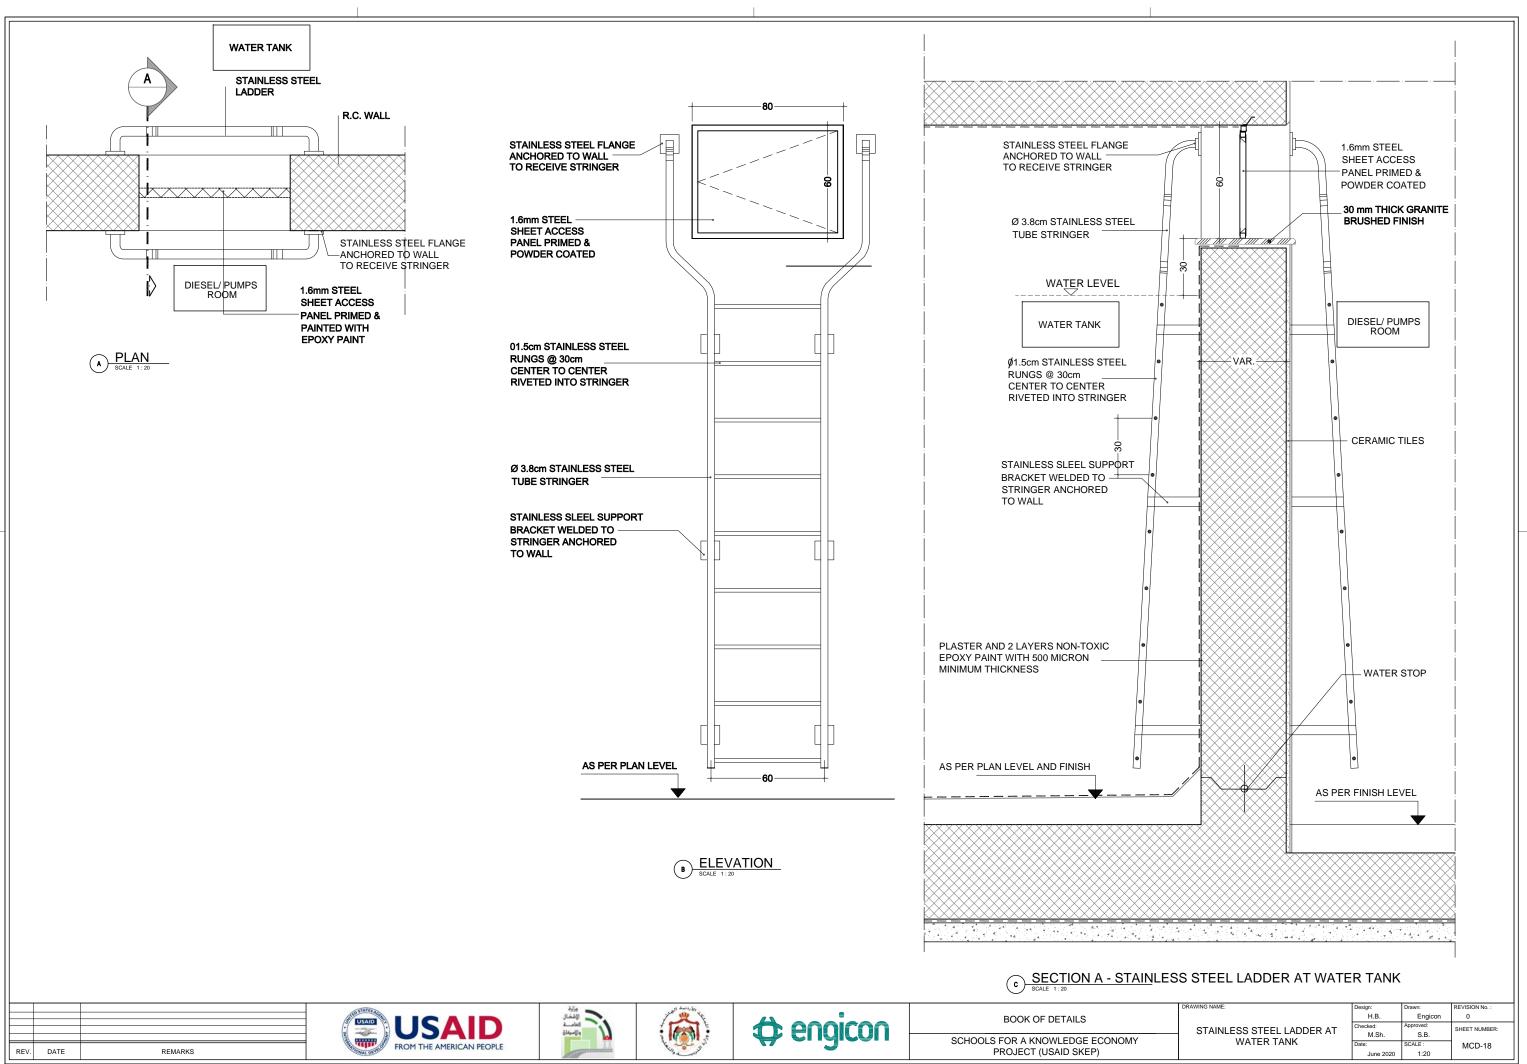


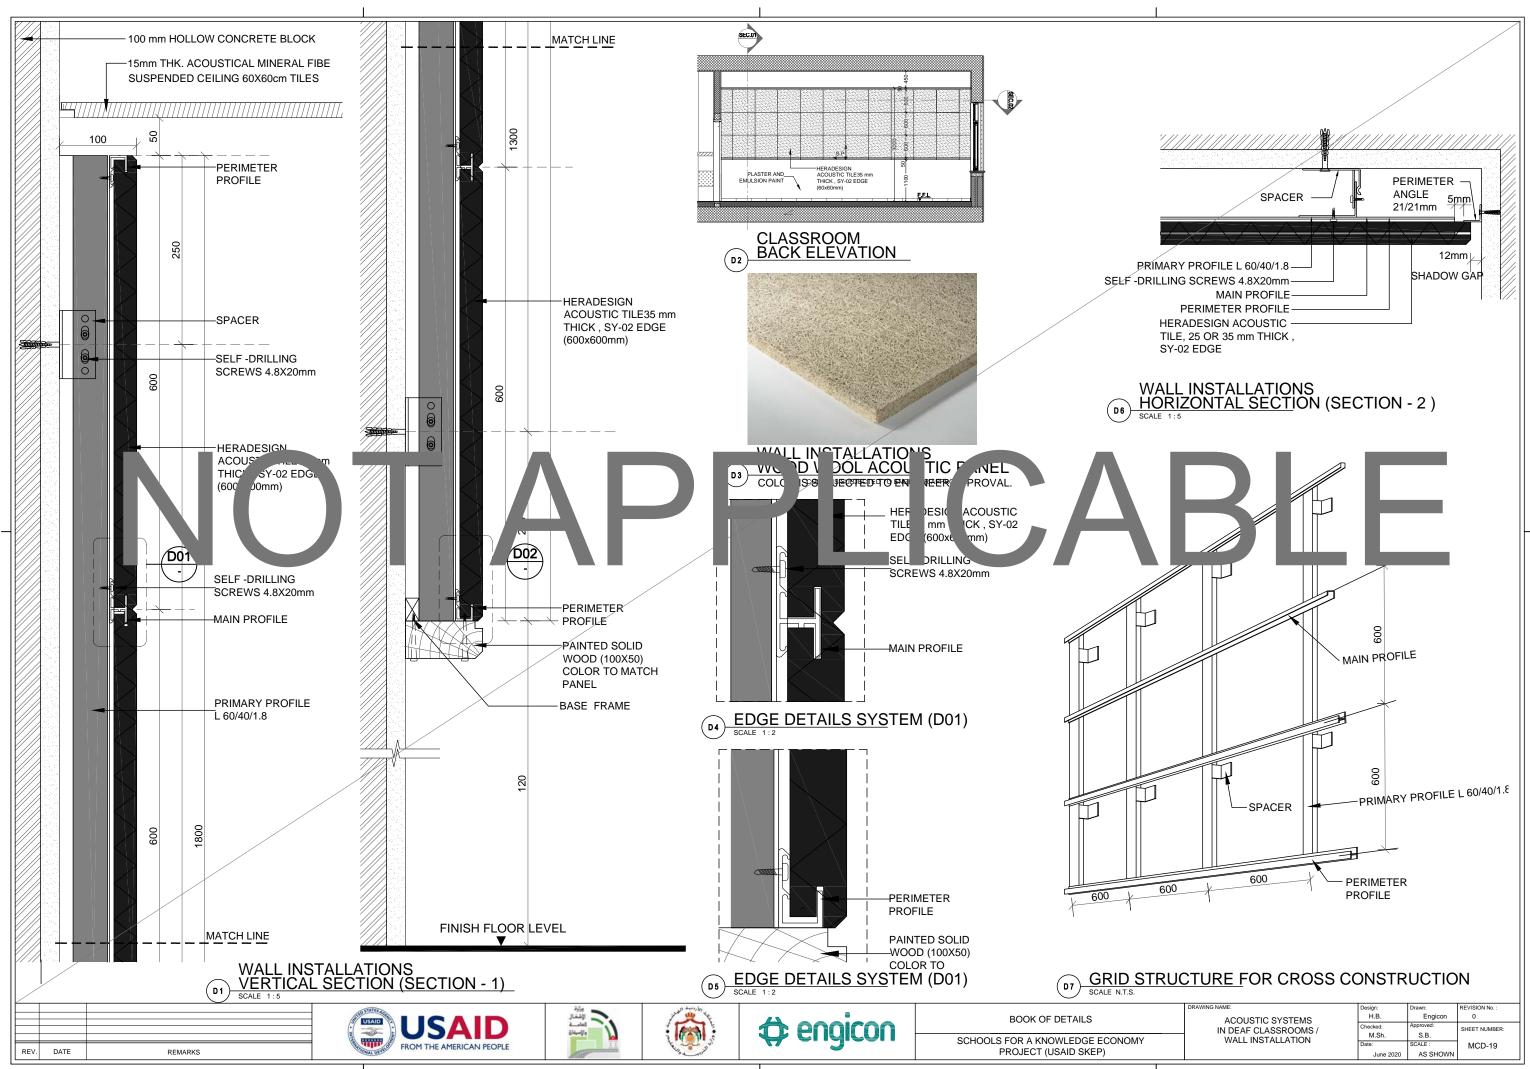

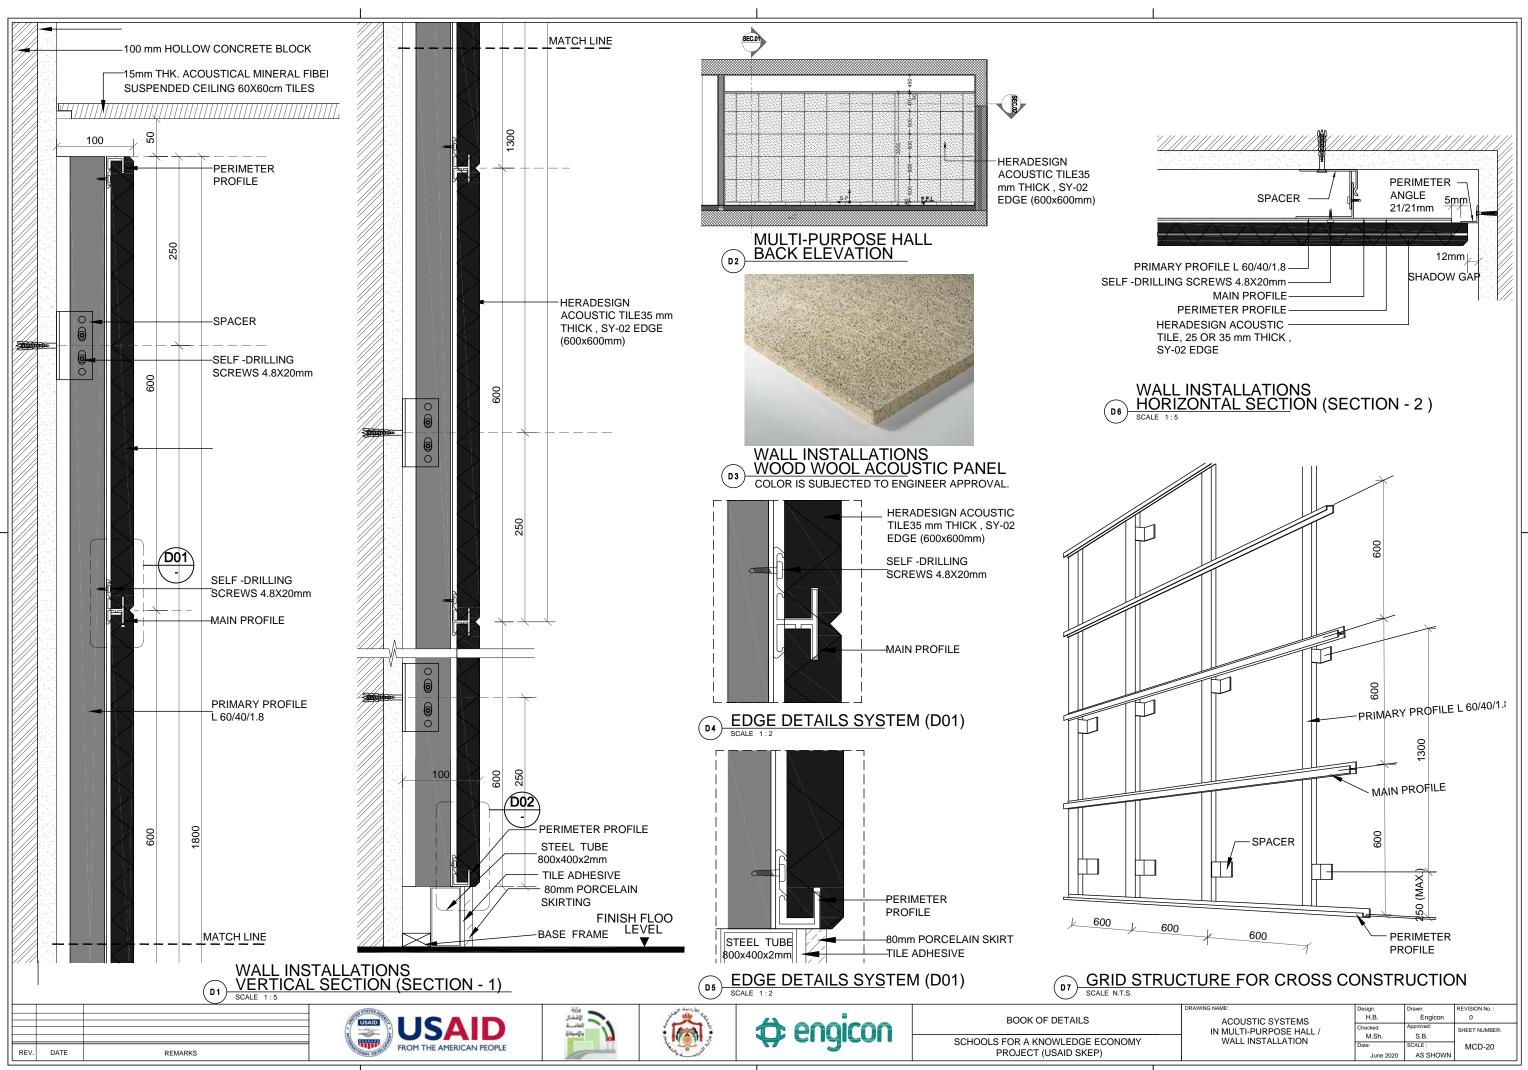


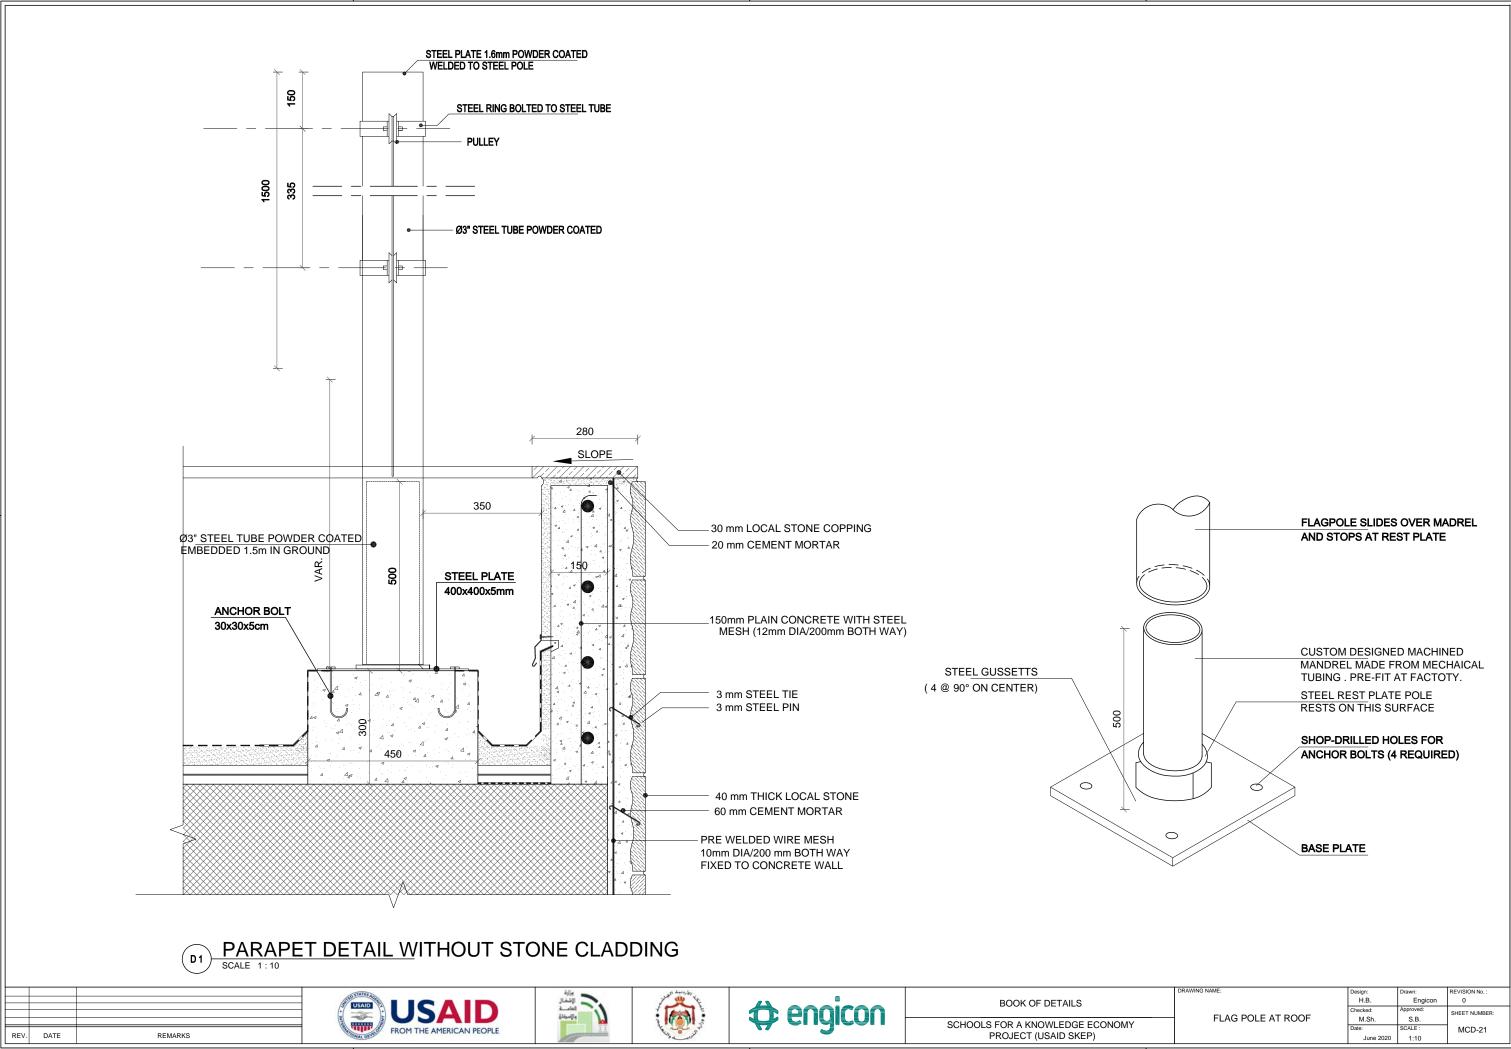


		1
		REVISION No. :
H.B.		0
Checked:	Approved:	SHEET NUMBER:
M.Sh.	S.B.	GHEET HOMBER
Date:	SCALE :	MCD-21
June 2020	1:10	
	M.Sh. Date:	H.B. Engicon Checked: Approved: M.Sh. S.B. Date: SCALE :

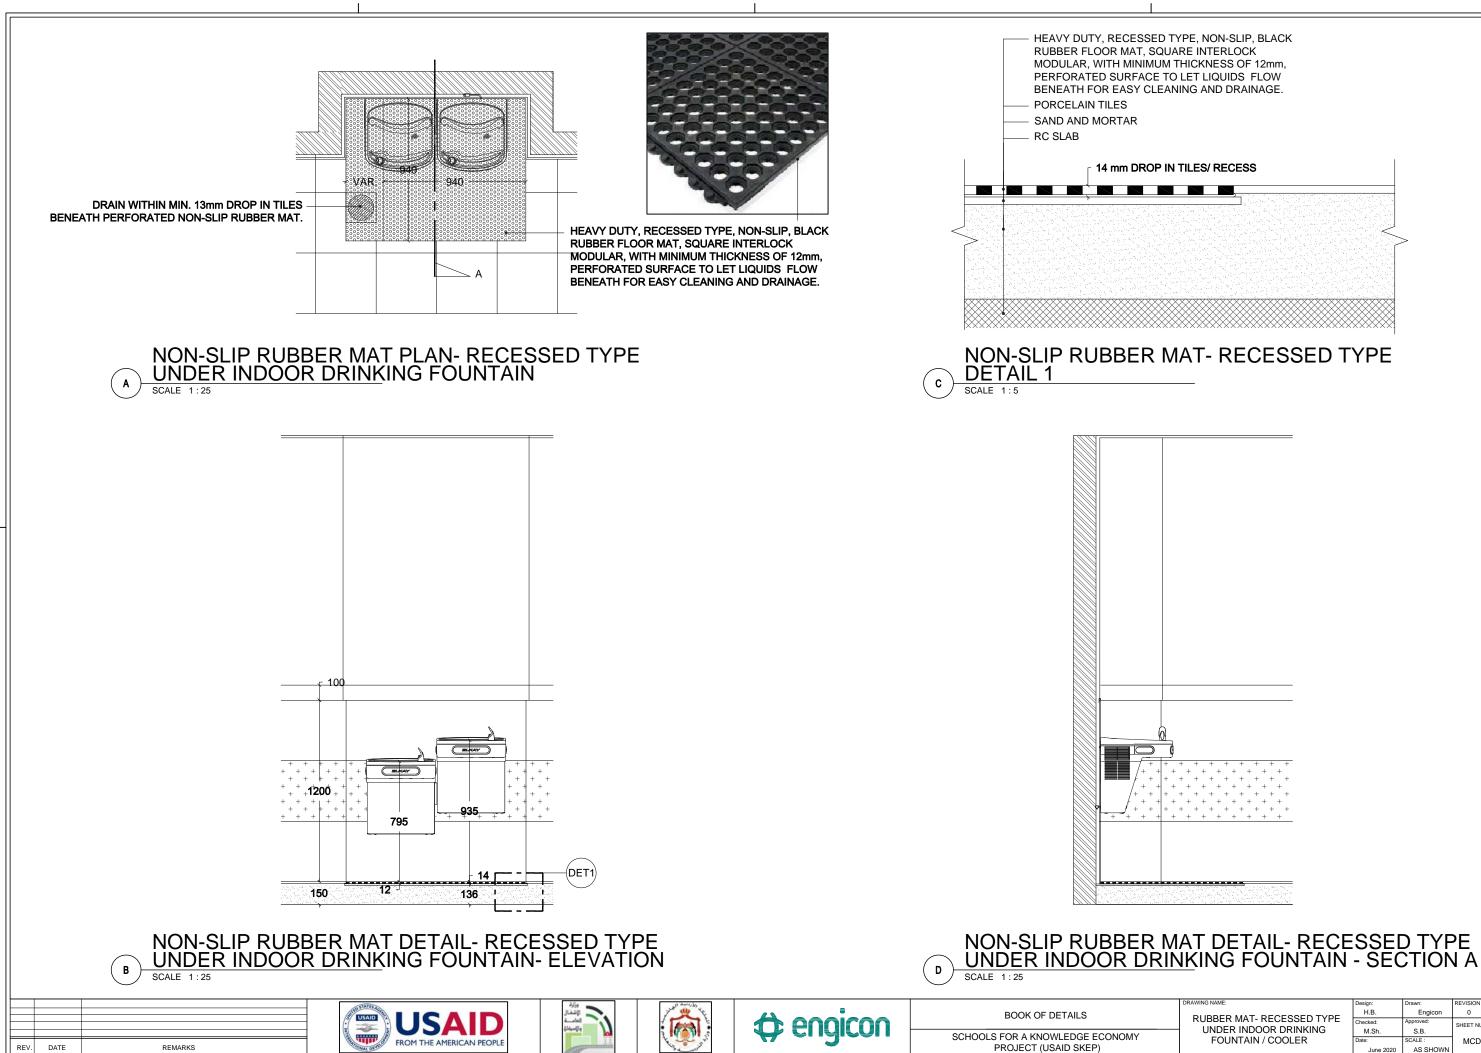

DRAWING NAME:	Design:	Drawn:	REVISION No. :
	H.B.	Engicon	0
RUBBER MAT- RECESSED TYPE	Checked:	Approved:	SHEET NUMBER
UNDER INDOOR DRINKING	M.Sh.	S.B.	
FOUNTAIN / COOLER	Date:	SCALE :	MCD-22
	June 2020	AS SHOWN	

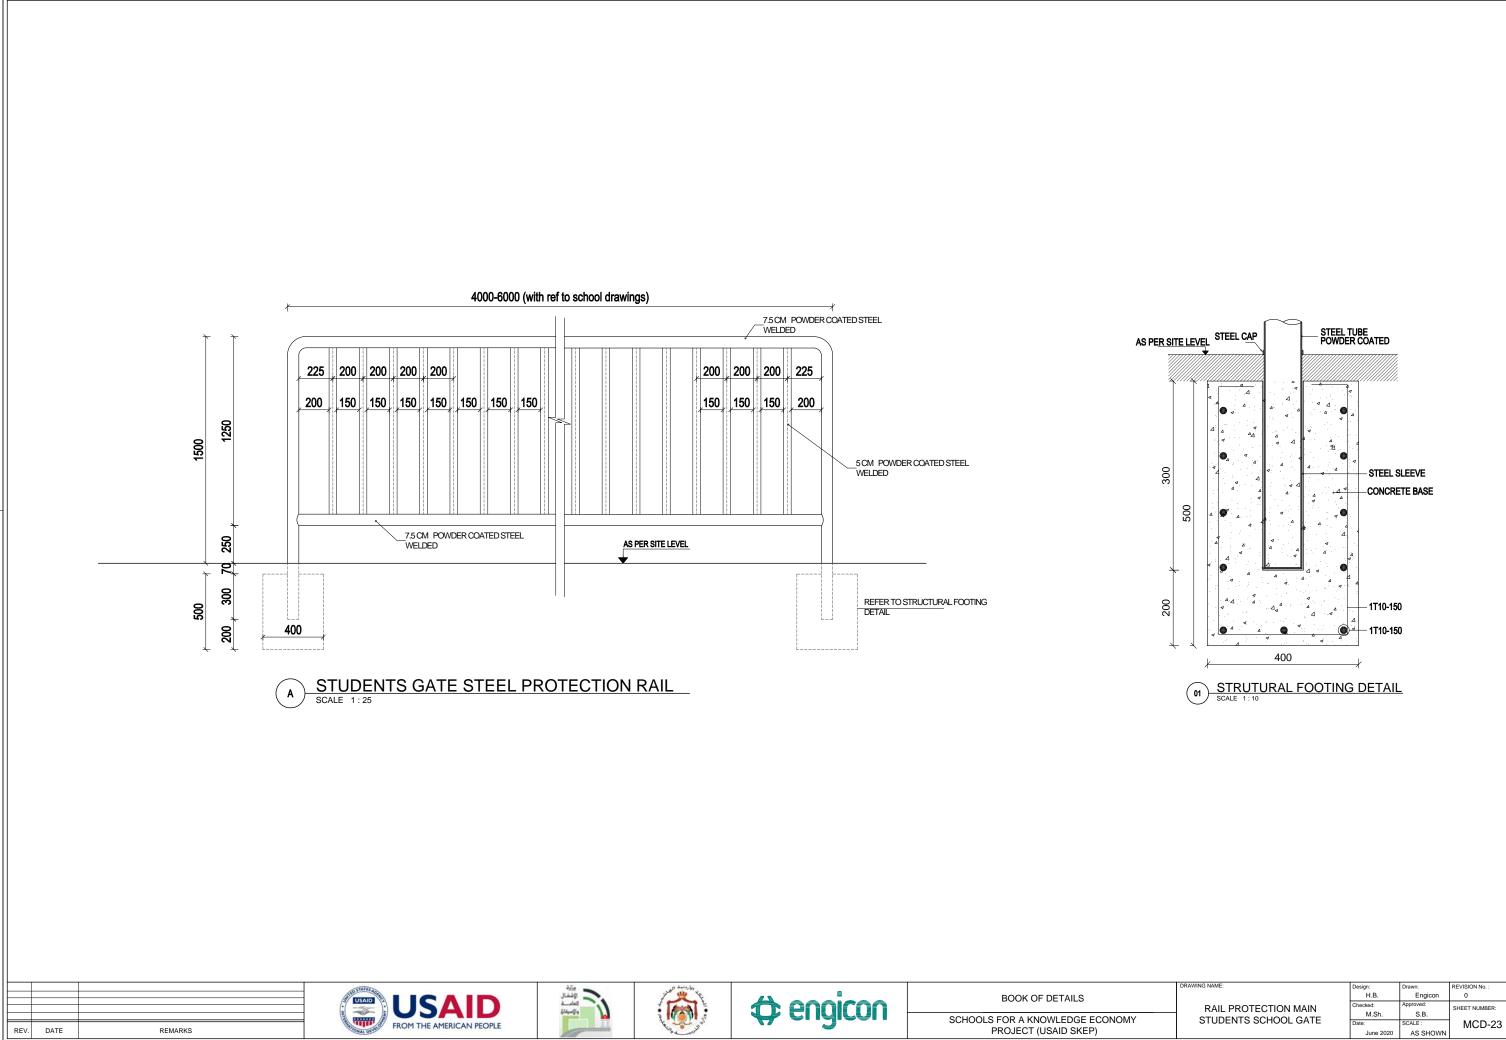

LANDSCAPE DETAILS (LSD)

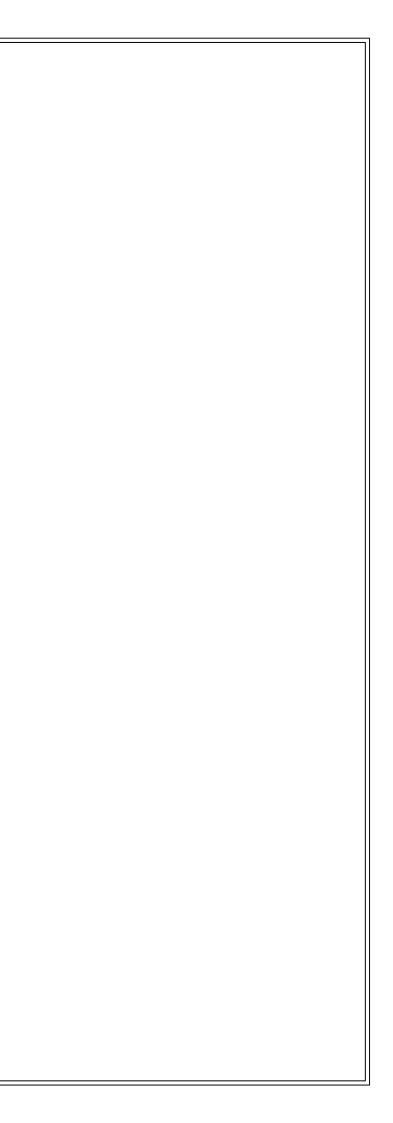

- 65mm THK. INTERLOCK TILE - 70mm (min) SAND FILL -100mm THK. R.C. SLAB ON GRADE -POLYETHYLENE SHEETS - 200mm BASE COURSE LAYER - WELL COMPACTED SOIL AS PER SITE LEVEL SLOPE AS SHOWN ON PLAN 65 8 5 200 TYPICAL DETAIL AT INTERLOCK TILES TYPICAL DETAIL AT ASPHALT В Α SCALE 1:10 SCALE 1:10



REV. DATE


REMARKS






BOOK OF DETAILS


SCHOOLS FOR A KNOWLEDGE ECONOMY PROJECT (USAID SKEP)

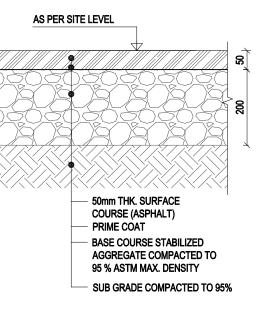


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DRAWING NAME:	Design:	Drawn:	REVISION No. :	
	H.B.	Engicon	0	
TYPICAL SITE DETAILS	Checked:	Approved:	SHEET NUMBER:	I
TIFICAL SITE DETAILS	M.Sh.	S.B.		
	Date:	SCALE :	LSD-01	I
	June 2020	1:10		I

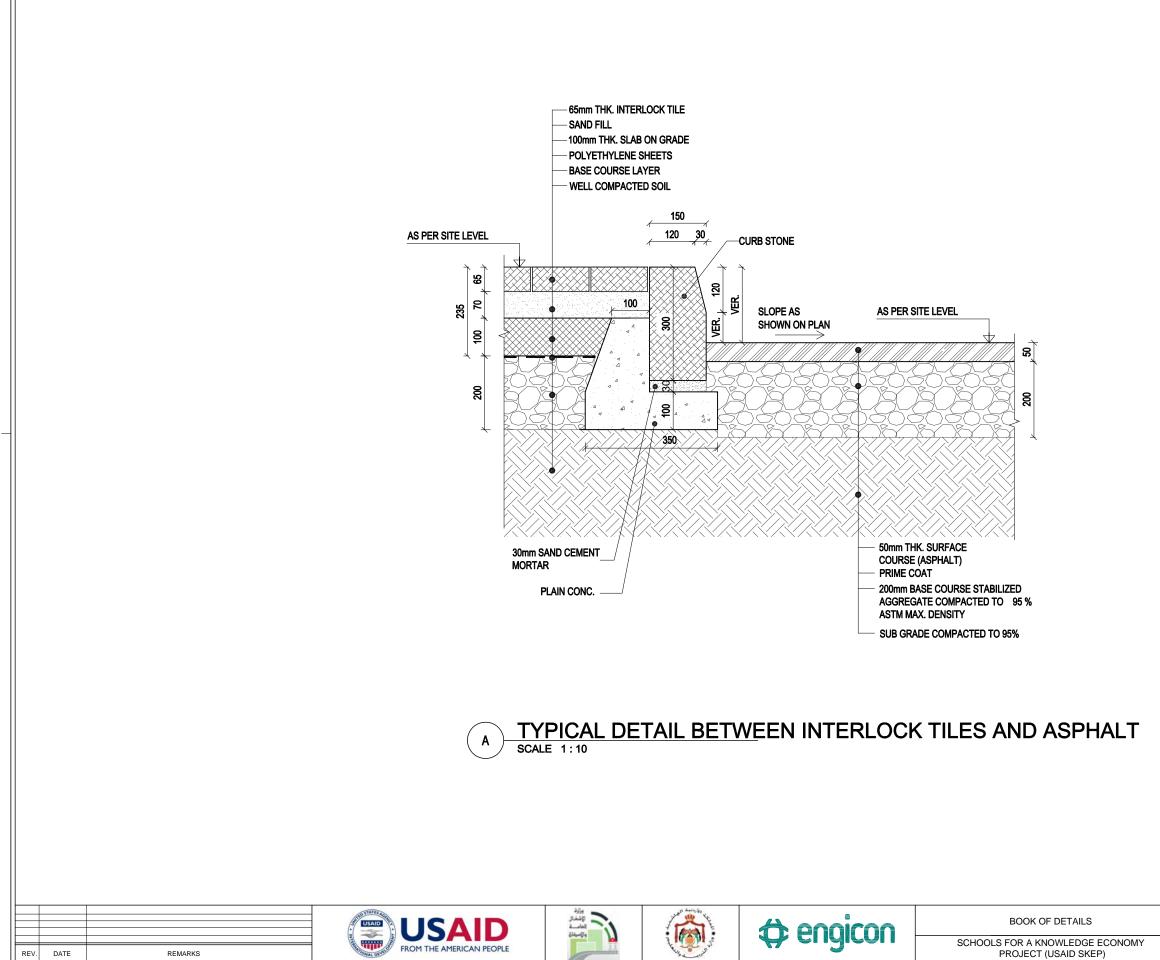


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	H.B.	Engicon	0
TYPICAL SITE DETAILS	Checked:	Approved:	SHEET NUMBER:
 TTFICAL SITE DETAILS	M.Sh.	S.B.	
	Date:	SCALE :	LSD-02
	June 2020	1:10	

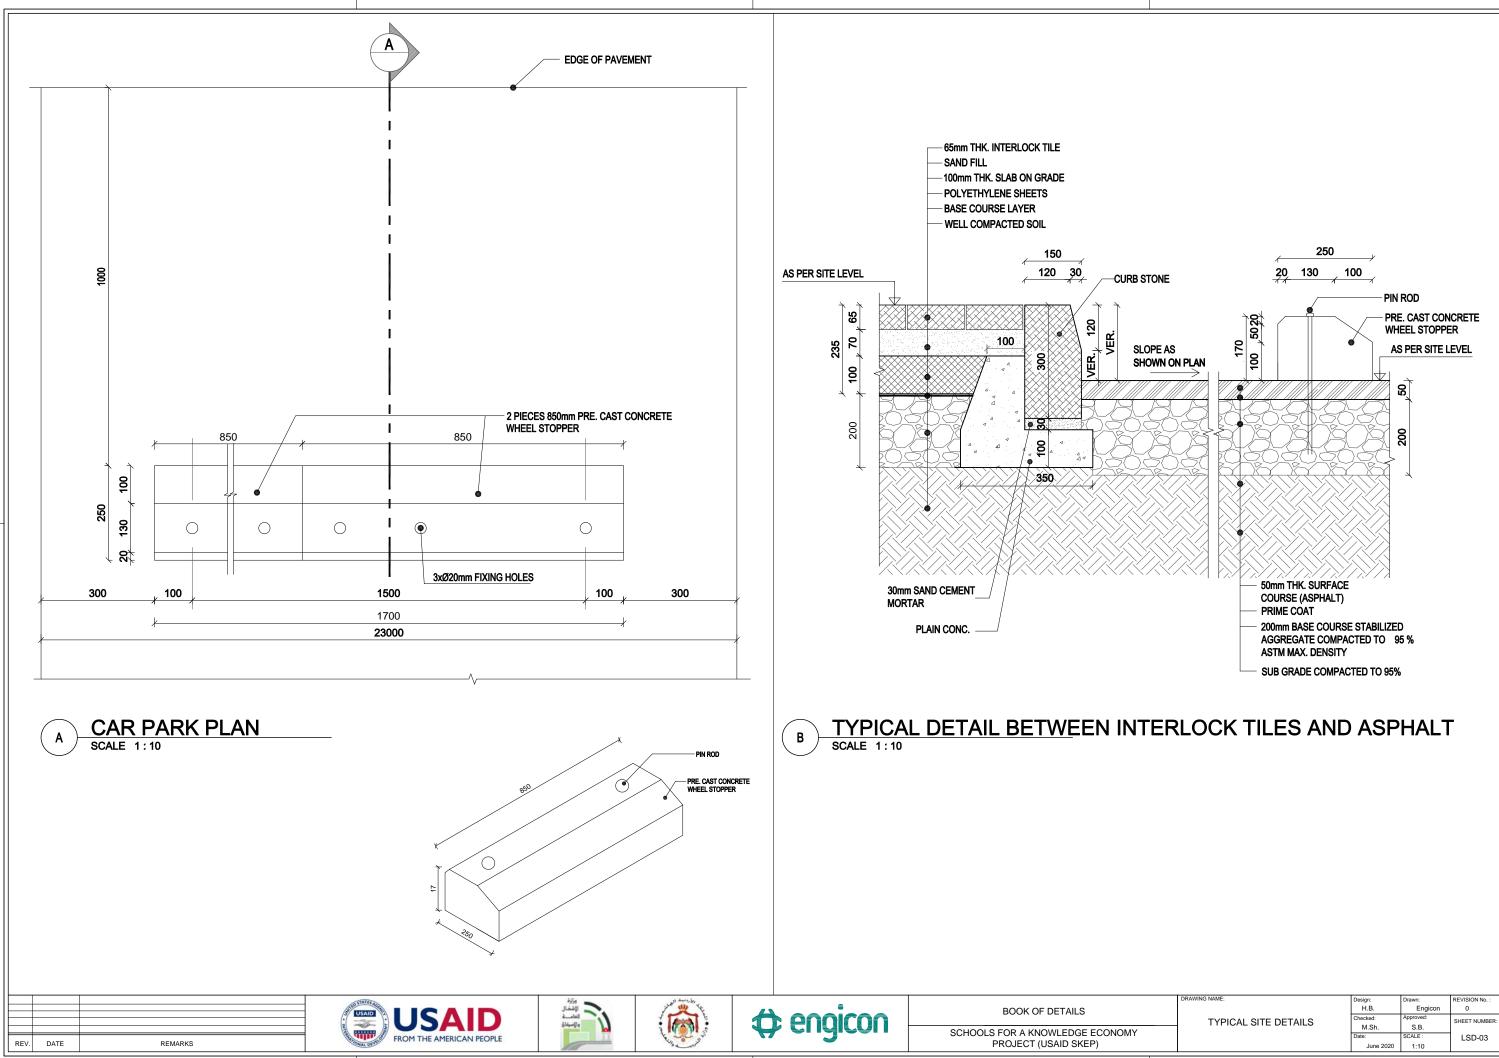


DRAWING NAME:	Design:	Drawn:	REVISION No. :
	H.B.	Engicon	0
TYPICAL SITE DETAILS	Checked:	Approved:	SHEET NUMBER:
	M.Sh.	S.B.	
	Date:	SCALE :	LSD-03
	June 2020	1.10	

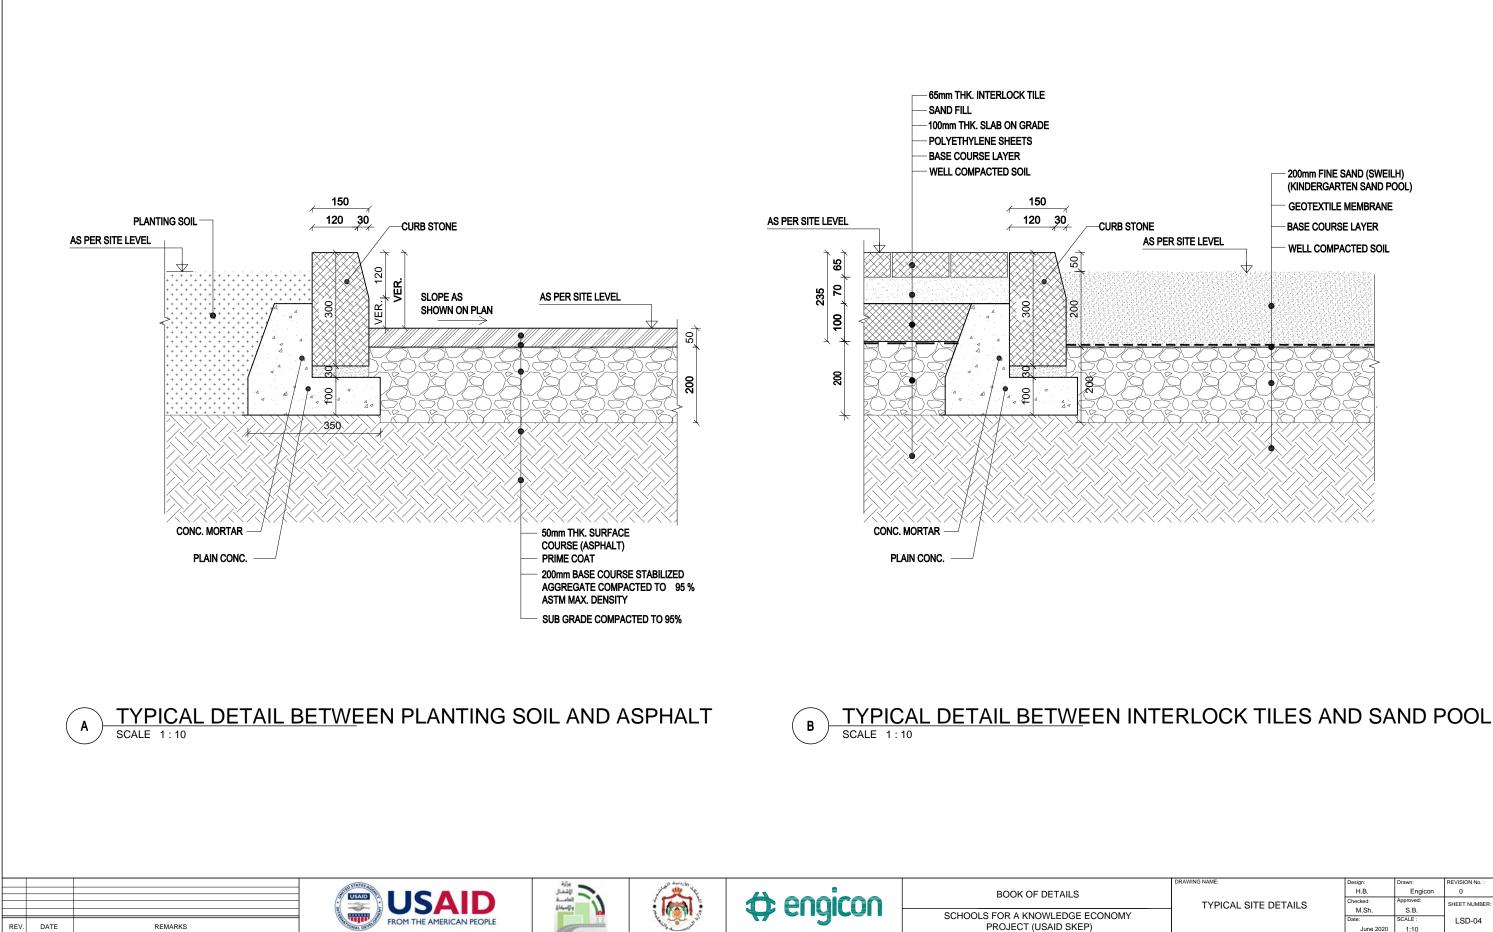

	DRAWING NAME:	Design:	Drawn:	REVISION No. :
	TYPICAL SITE DETAILS	H.B.	Engicon	0
		Checked:	Approved:	SHEET NUMBER:
		M.Sh.	S.B.	
		Date:	SCALE :	LSD-04
		June 2020	1:10	

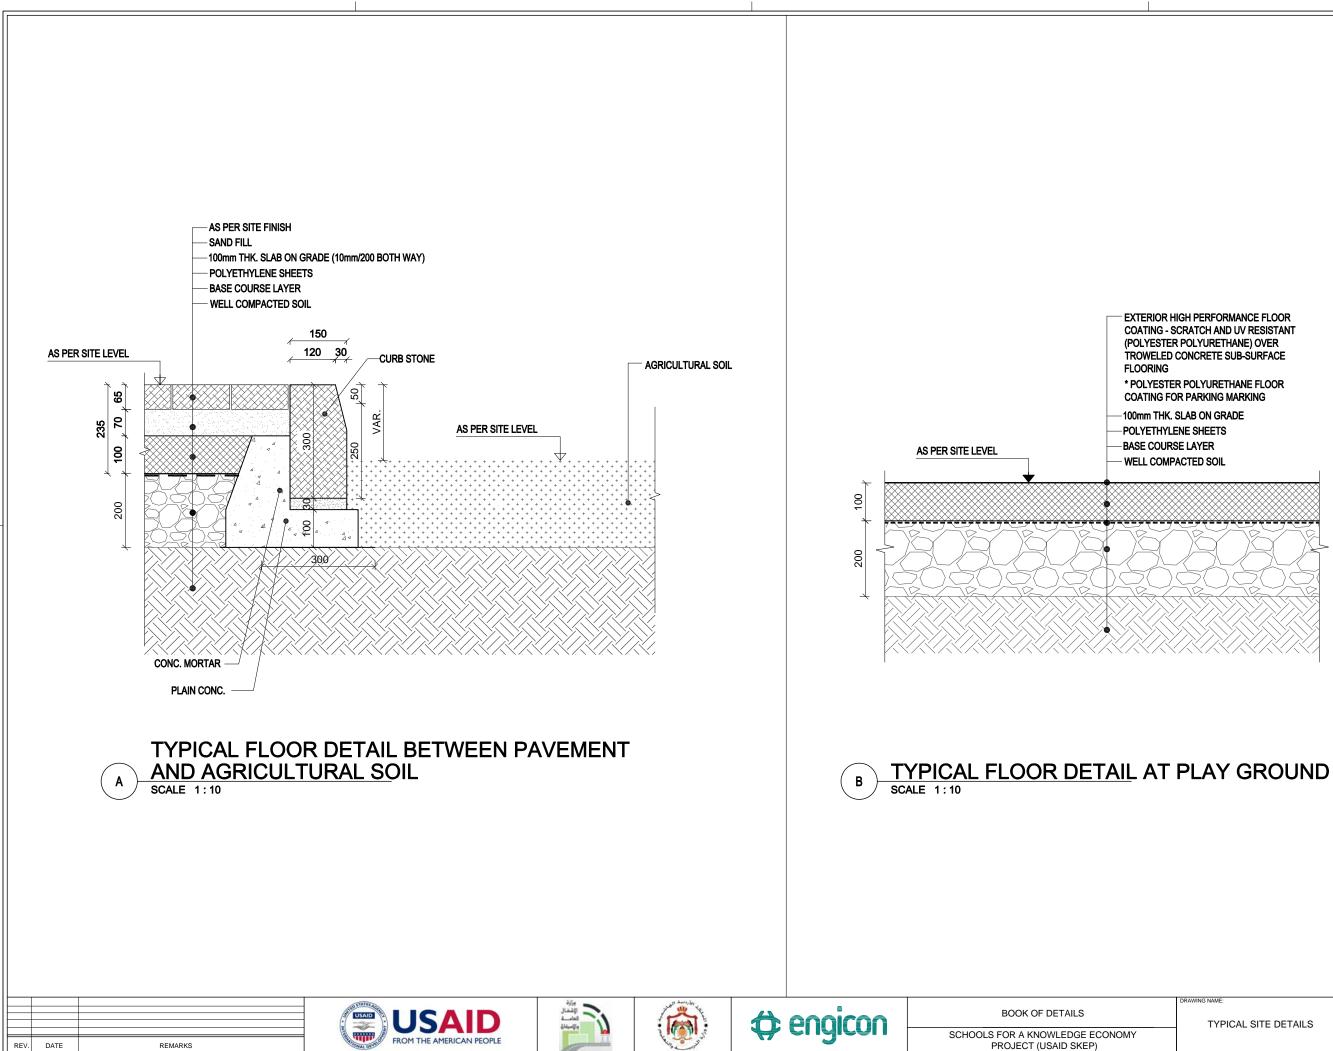

	DRAWING NAME:	Design:	Drawn:	REVISION No. :
		H.B.	Engicon	0
	TYPICAL SITE DETAILS	Checked:	Approved:	SHEET NUMBER:
		M.Sh.	S.B.	
		Date:	SCALE :	LSD-05
		luno 2020	1.10	

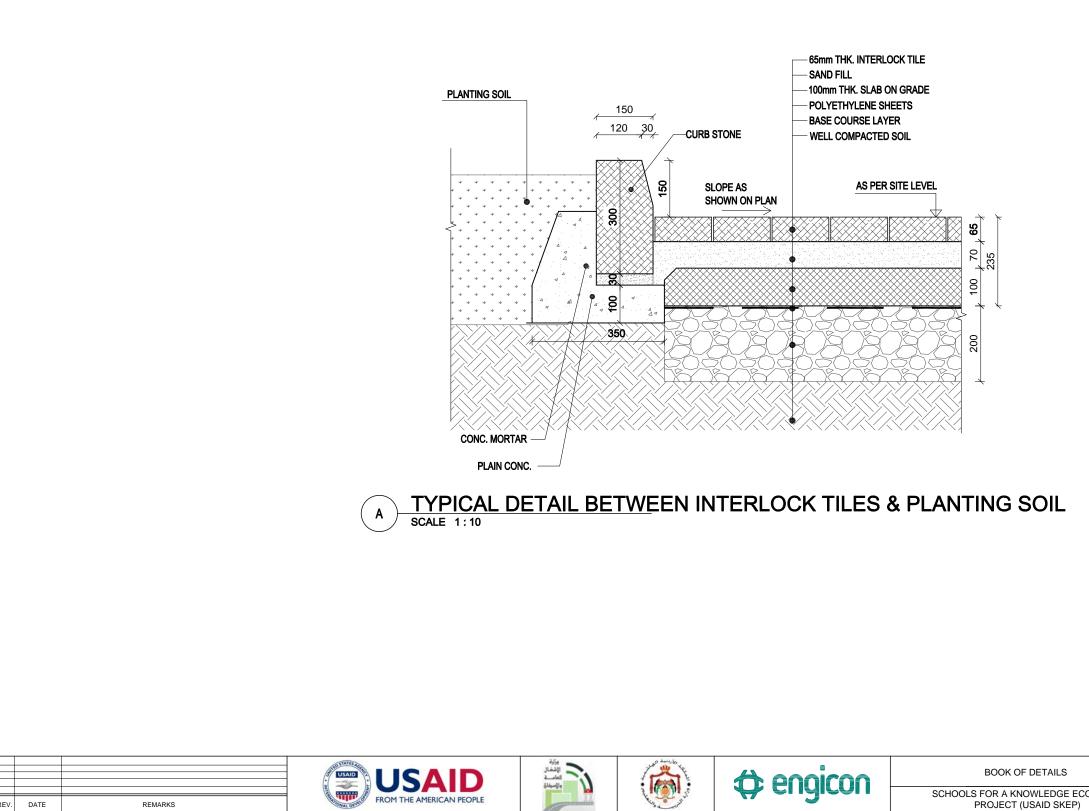


REV. DATE

REMARKS

SCHOOLS FOR A KNOWLEDGE ECONOM
PROJECT (USAID SKEP)

DRAWING NAME:	Design:	Drawn:	REVISION No. :
	H.B.	Engicon	0
TYPICAL SITE DETAILS	Checked:	Approved:	SHEET NUMBER:
ITFICAL SITE DETAILS	M.Sh.	S.B.	CHEET NOMBER
	Date:	SCALE :	LSD-06
	June 2020	1:10	

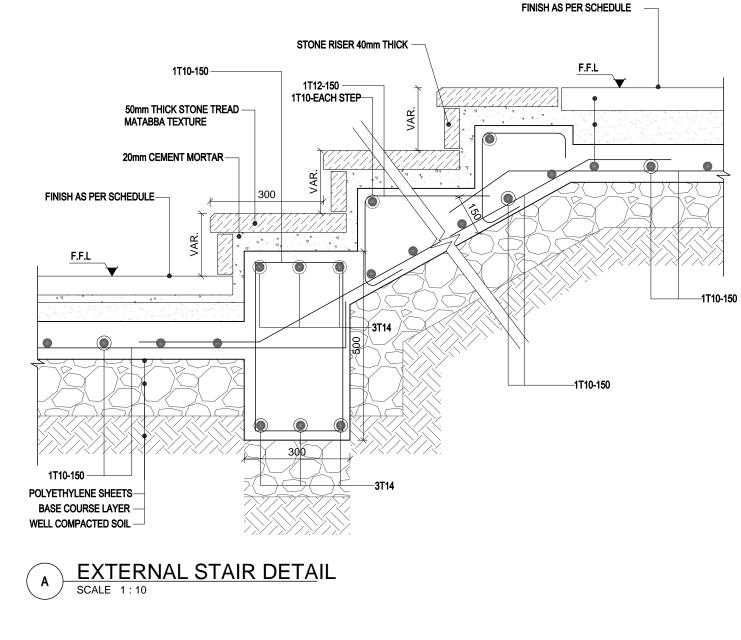


characteristics

مرزد الإشغال العامة




REV. DATE


REMARKS

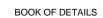


SCHOOLS FOR A KNOWLEDGE ECONOMY PROJECT (USAID SKEP)

	DRAWING NAME:	Design:	Drawn:	REVISION No. :
		H.B.	Engicon	0
	EXTERNAL STAIR DETAILS	Checked:	Approved:	SHEET NUMBER:
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		Date:	SCALE :	LSD-07
		June 2020	1:10	

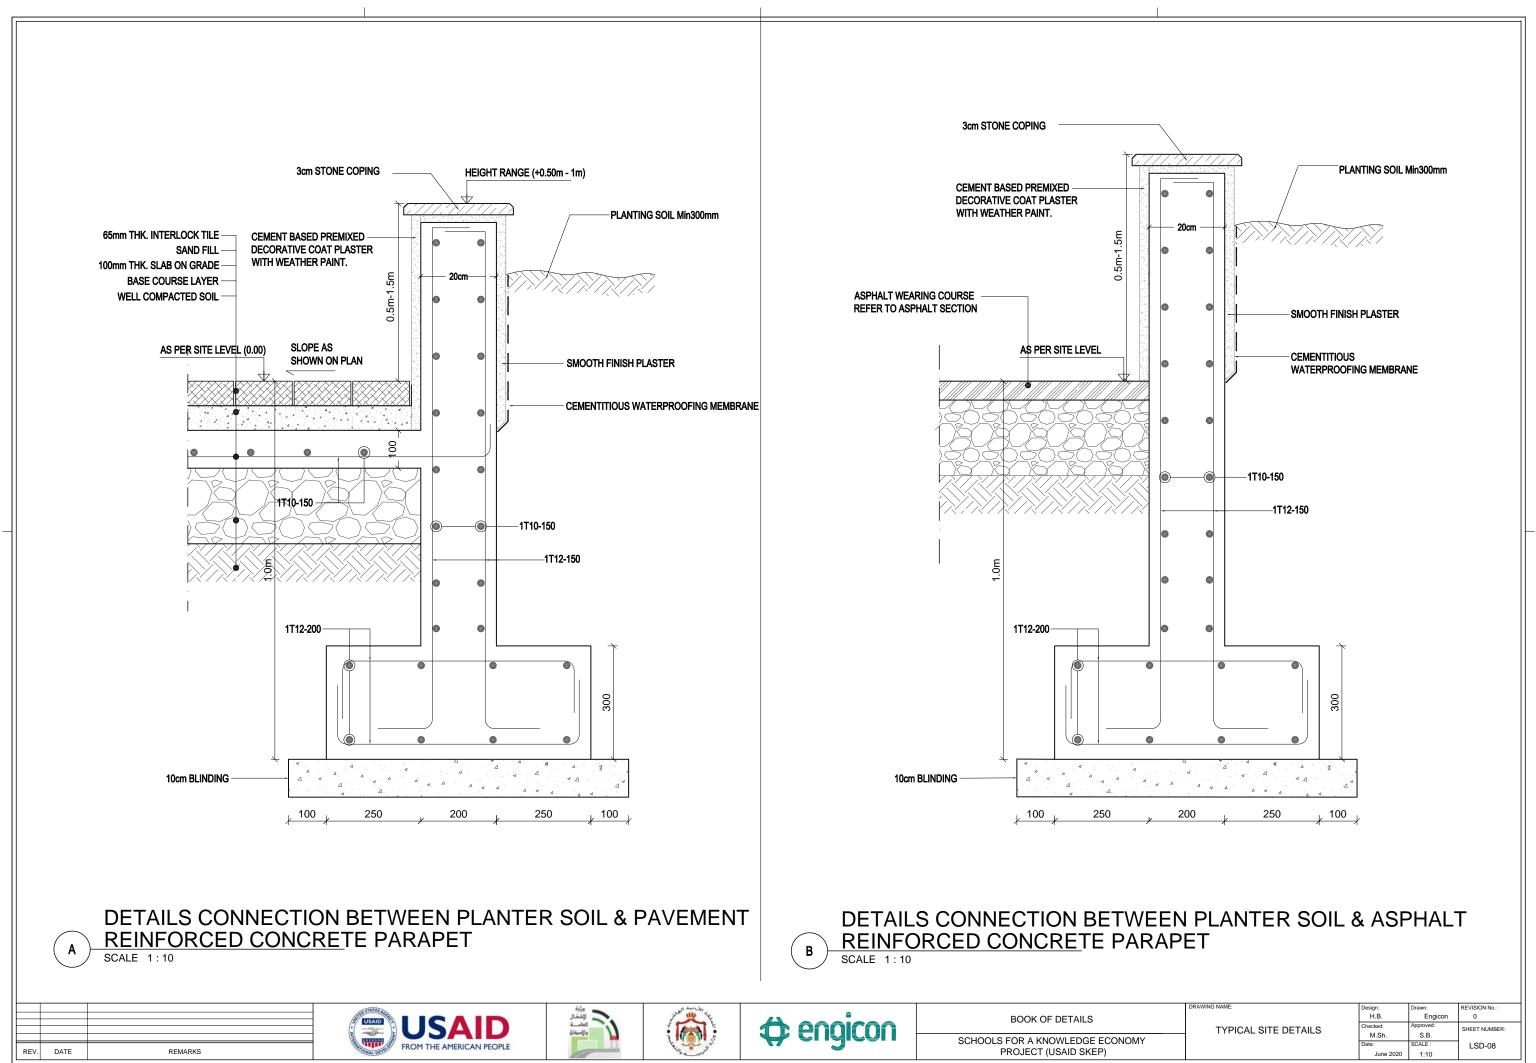


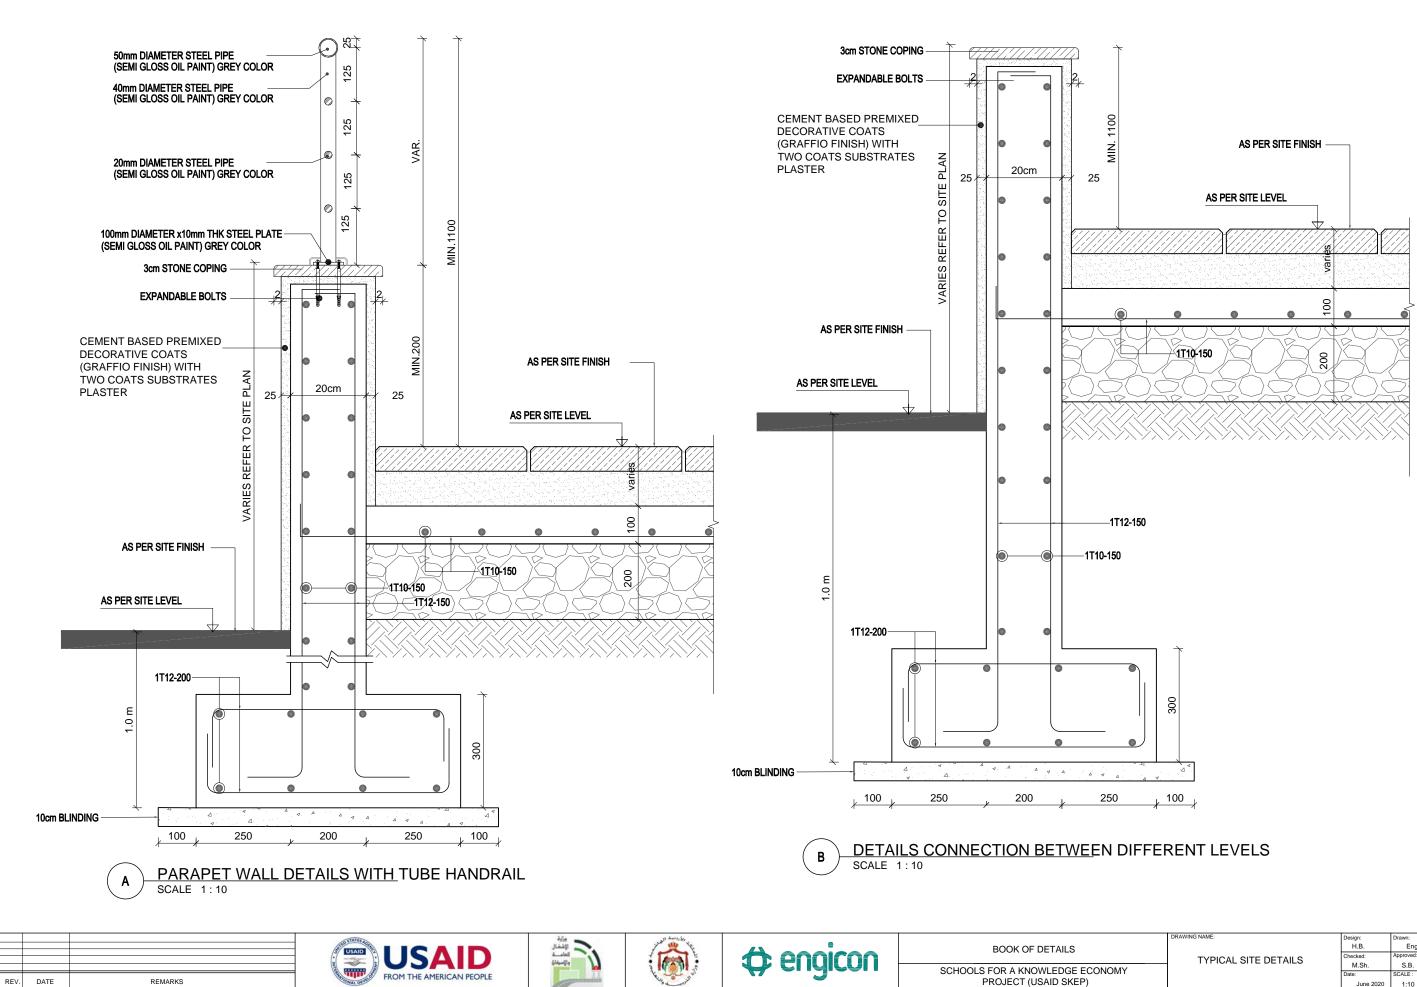


	DRAWING NAME:	Design:	Drawn:	REVISION No. :
		H.B.	Engicon	0
	TYPICAL SITE DETAILS	Checked:	Approved:	SHEET NUMBER:
		M.Sh.	S.B.	
		Date:	SCALE :	LSD-09
		June 2020	1:10	

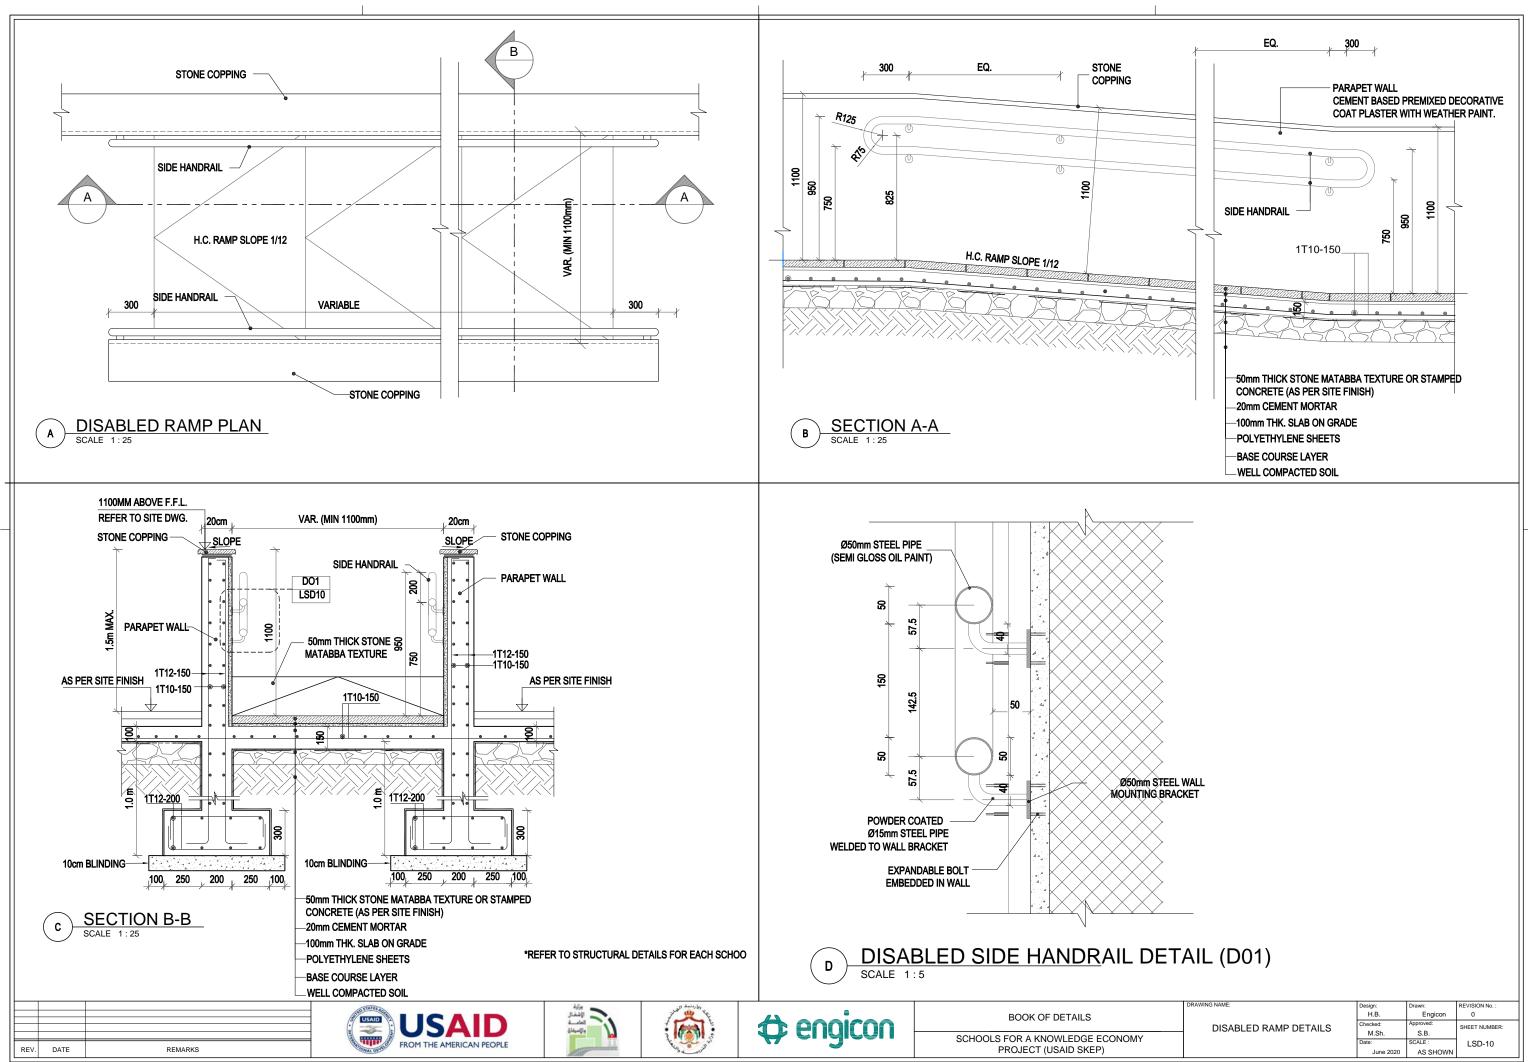

DRAWING NAME:	Design:	Drawn:	REVISION No. :
	H.B.	Engicon	0
DISABLED RAMP DETAILS	Checked:	Approved:	SHEET NUMBER:
DISABLED RAIVIF DETAILS	M.Sh.	S.B.	
	Date:	SCALE :	LSD-10
	June 2020	AS SHOWN	

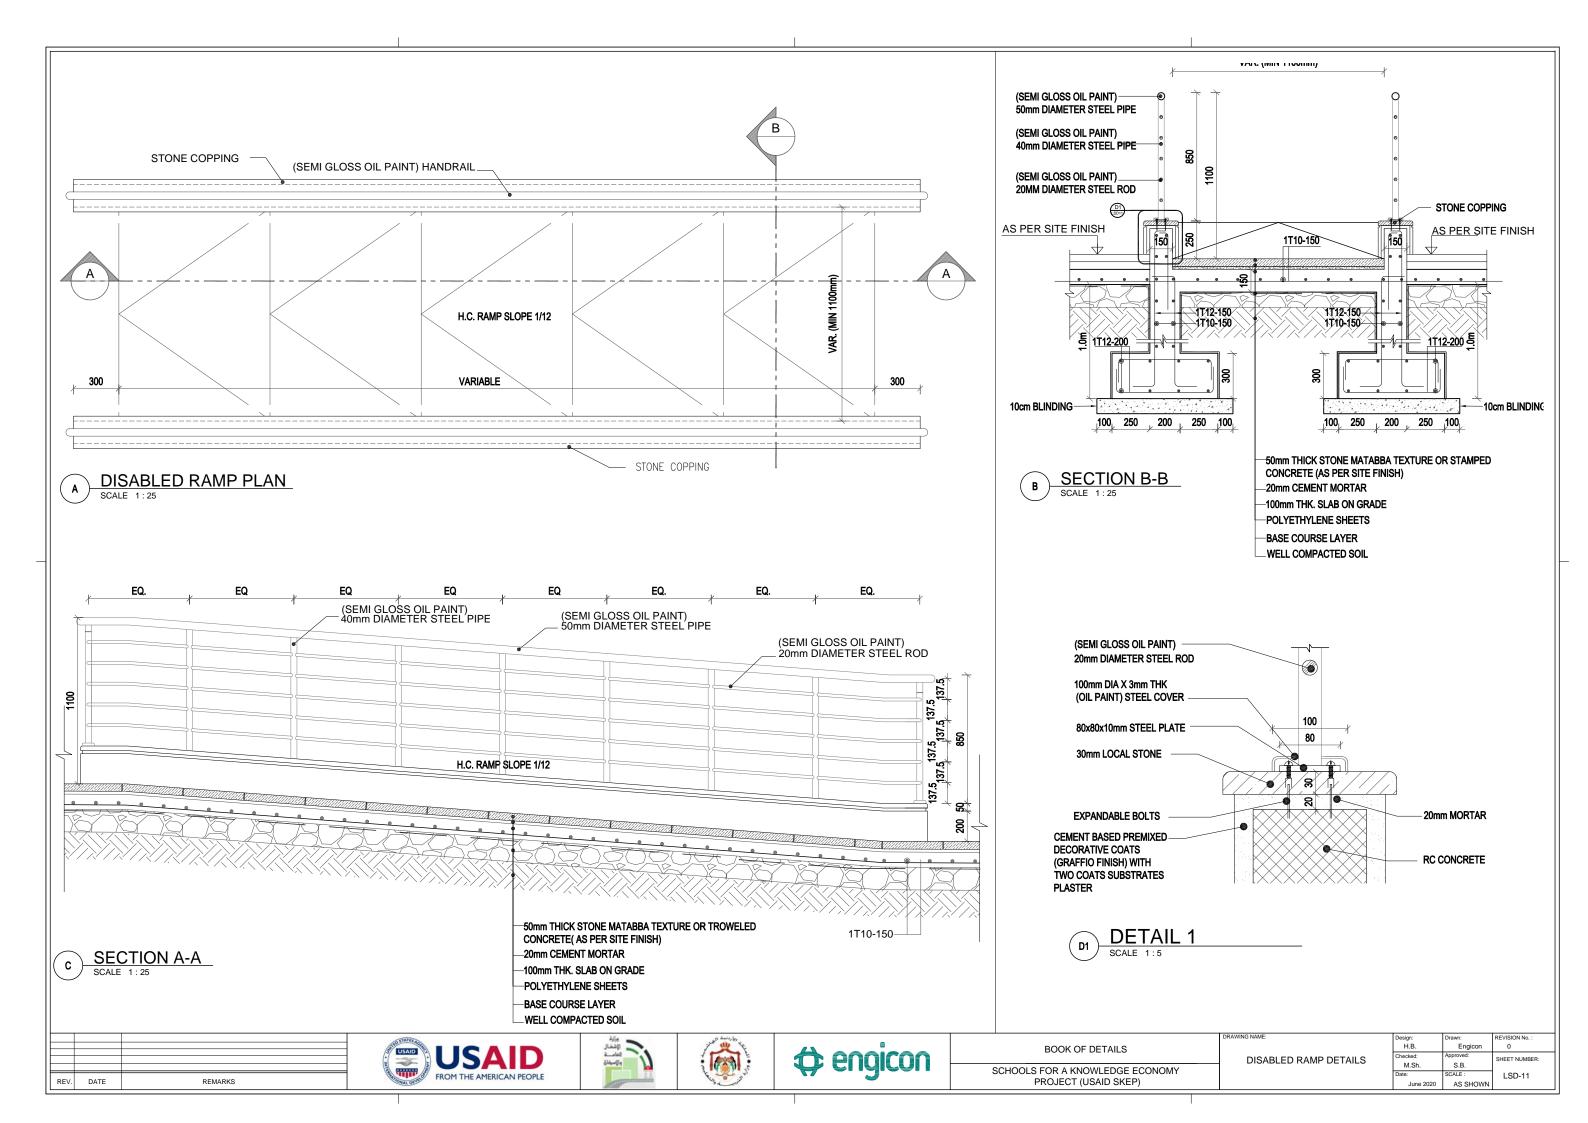


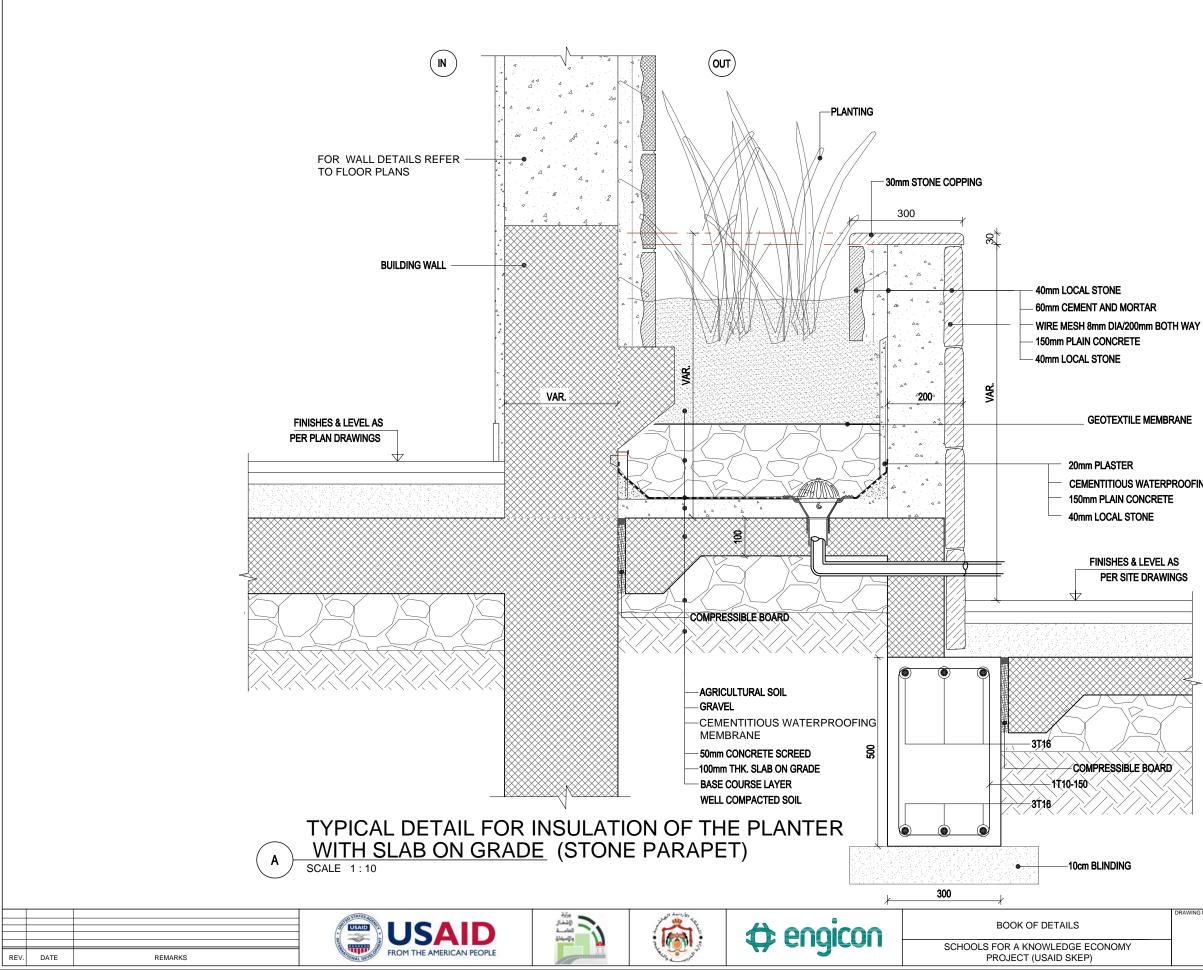


CEMENTITIOUS WATERPROOFING MEMBRANE




DRAWING NAME:	Design:	Drawn:	REVISION No. :
	H.B.	Engicon	0
TYPICAL SITE DETAILS	Checked:	Approved:	SHEET NUMBER:
TIFICAL SITE DETAILS	M.Sh.	S.B.	
	Date:	SCALE :	LSD-12
	June 2020	1:10	

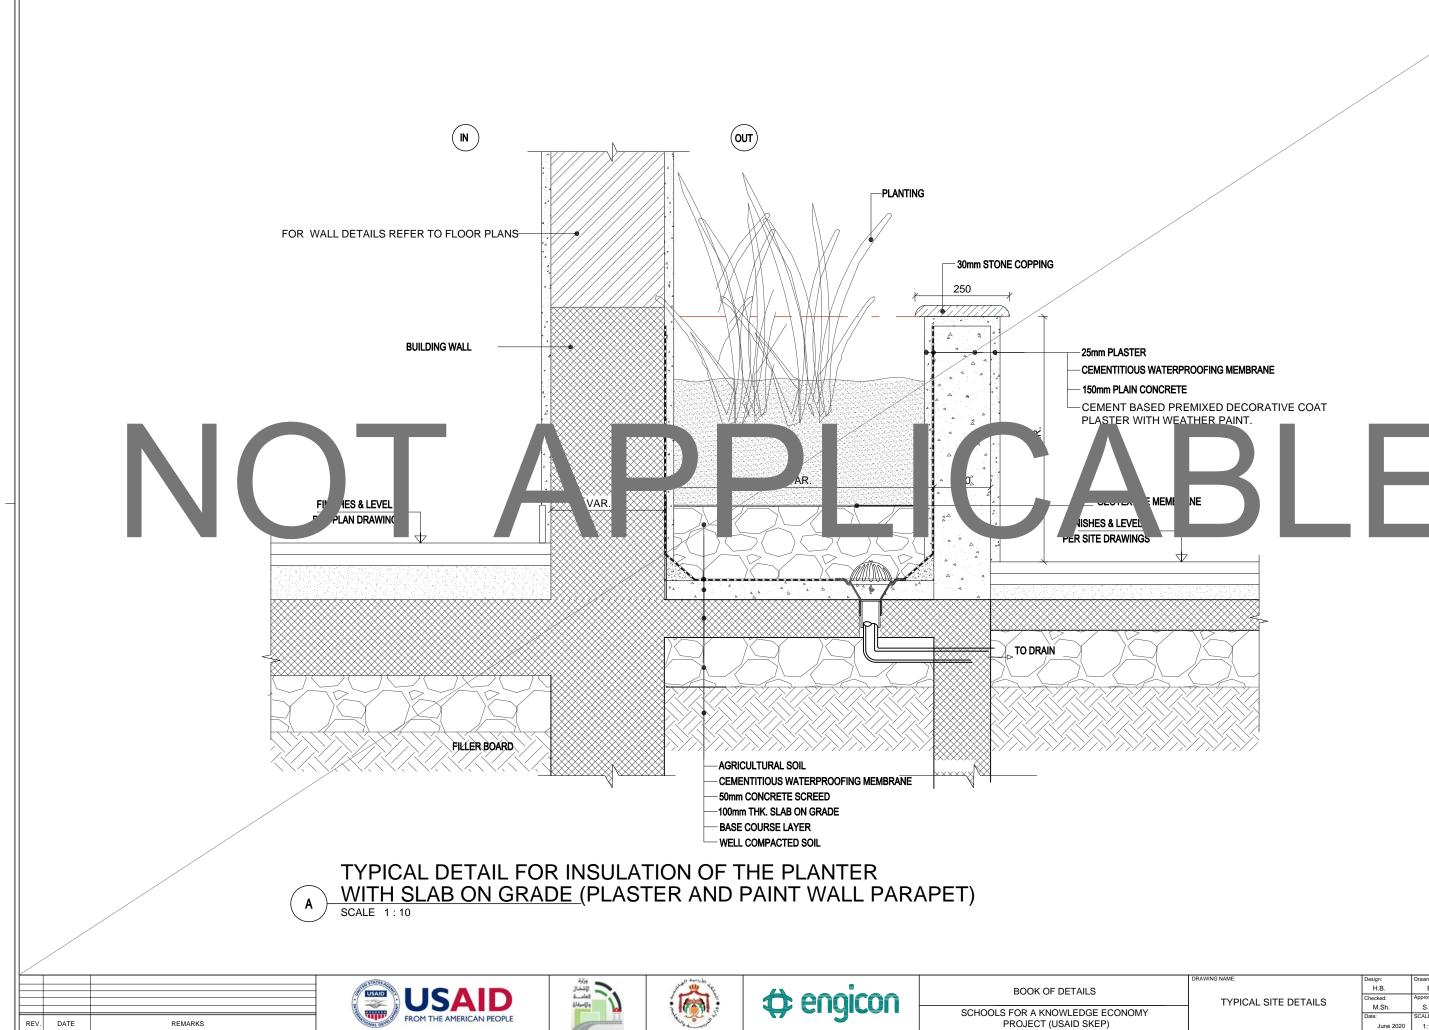

DRAWING NAME:	Design:	Drawn:	REVISION No. :
	H.B.	Engicon	0
TYPICAL SITE DETAILS	Checked:	Approved:	SHEET NUMBER:
TIFICAL SITE DETAILS	M.Sh.	S.B.	
	Date:	SCALE :	LSD-13
	June 2020	1:10	

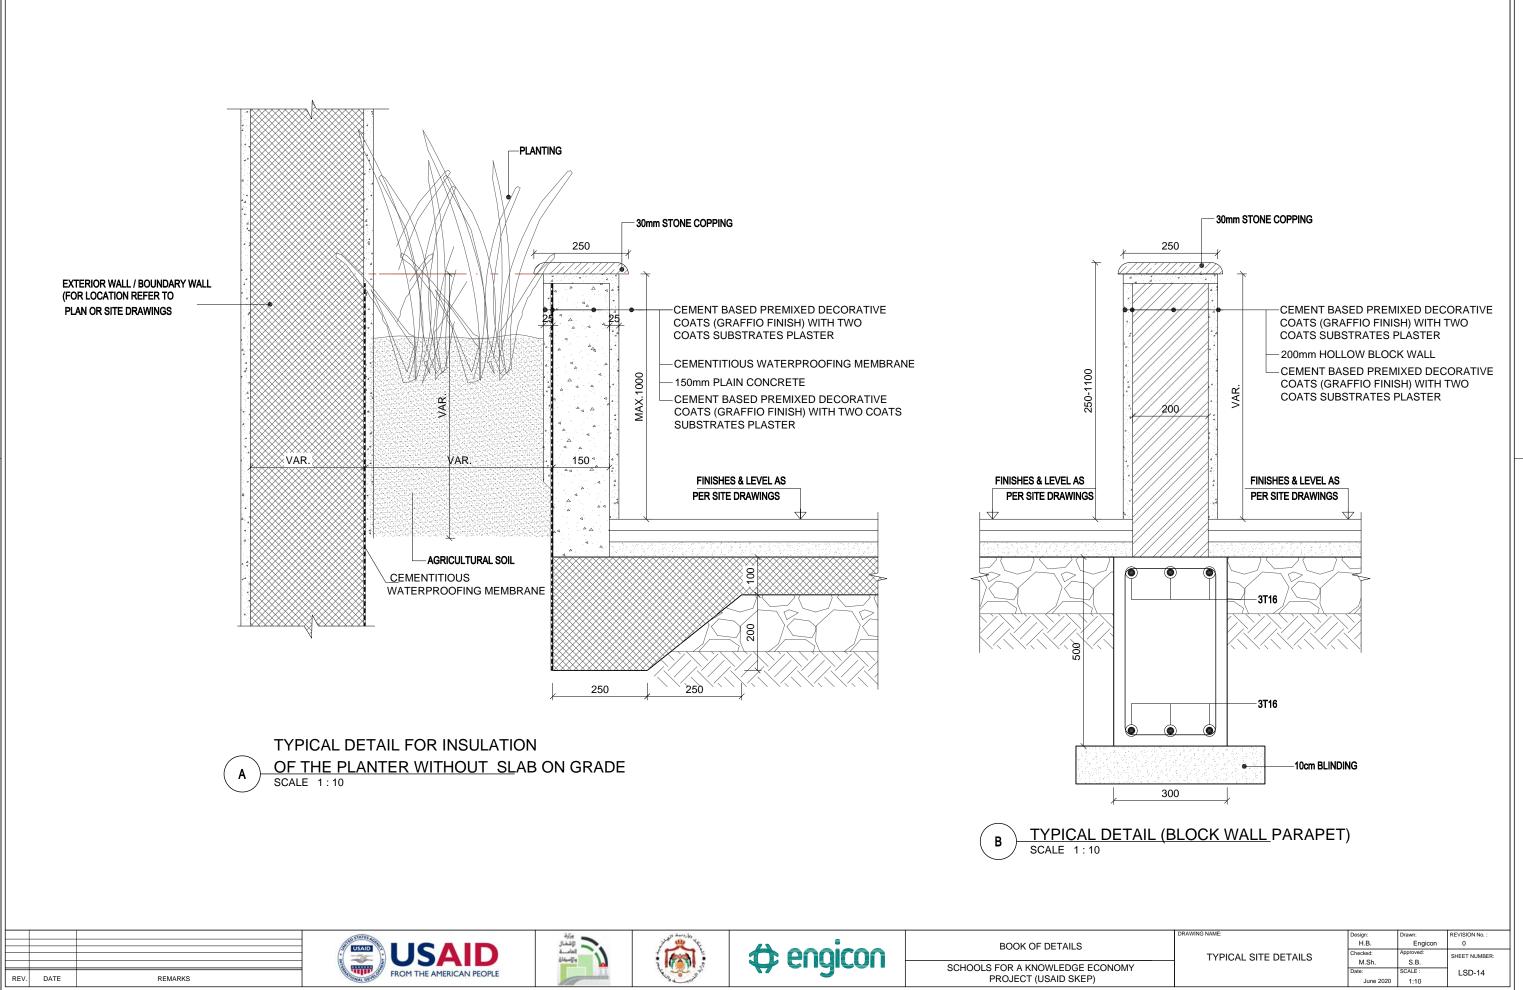


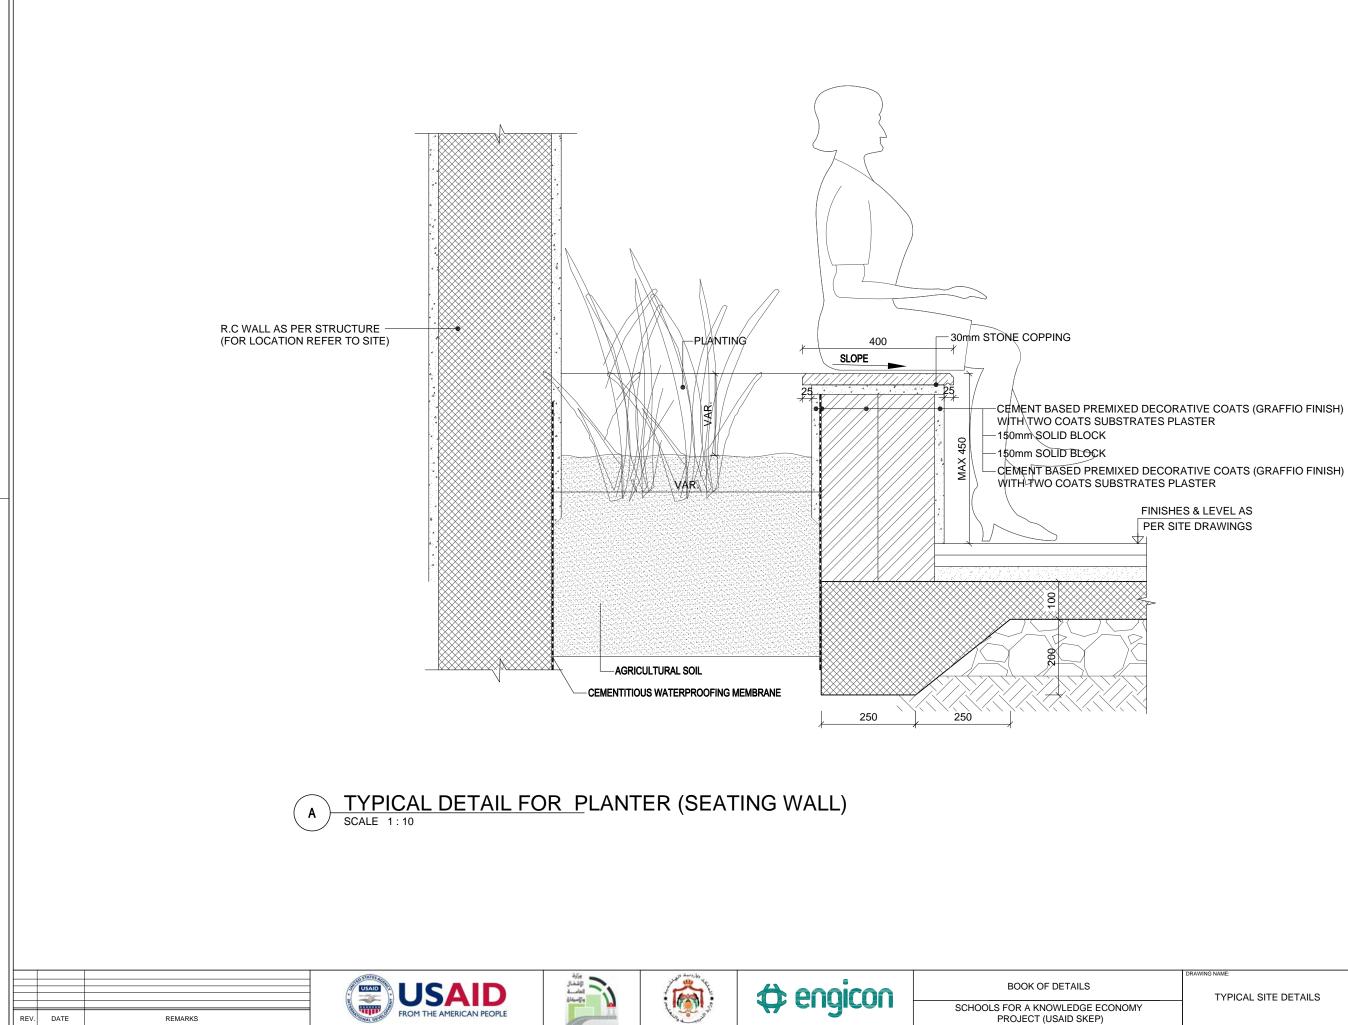


CEMENT BASED PREMIXED DECORATIVE COATS (GRAFFIO FINISH)


FINISHES & LEVEL AS PER SITE DRAWINGS


DRAWING NAME:	Design:	Drawn:	REVISION No. :	
	H.B.	Engicon	0	
TYPICAL SITE DETAILS	Checked:	Approved:	SHEET NUMBER:	
	M.Sh.	S.B.		
	Date:	SCALE :	LSD-15	
	June 2020	1:10		1

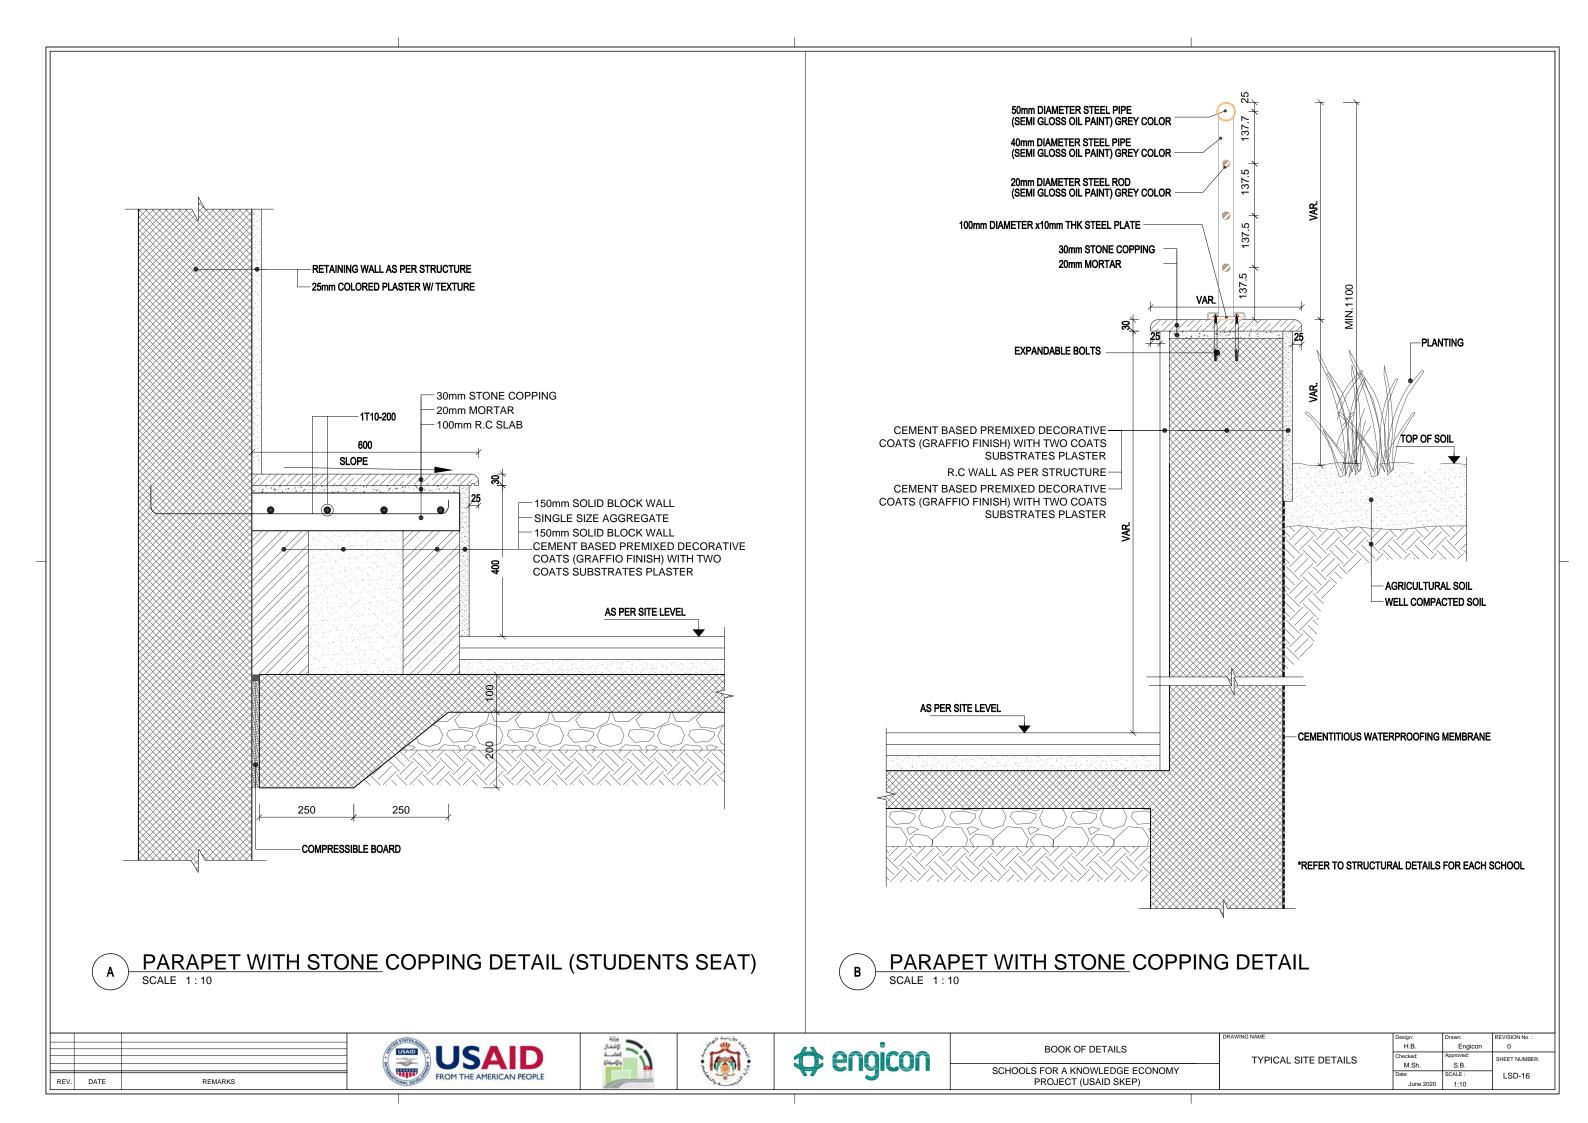


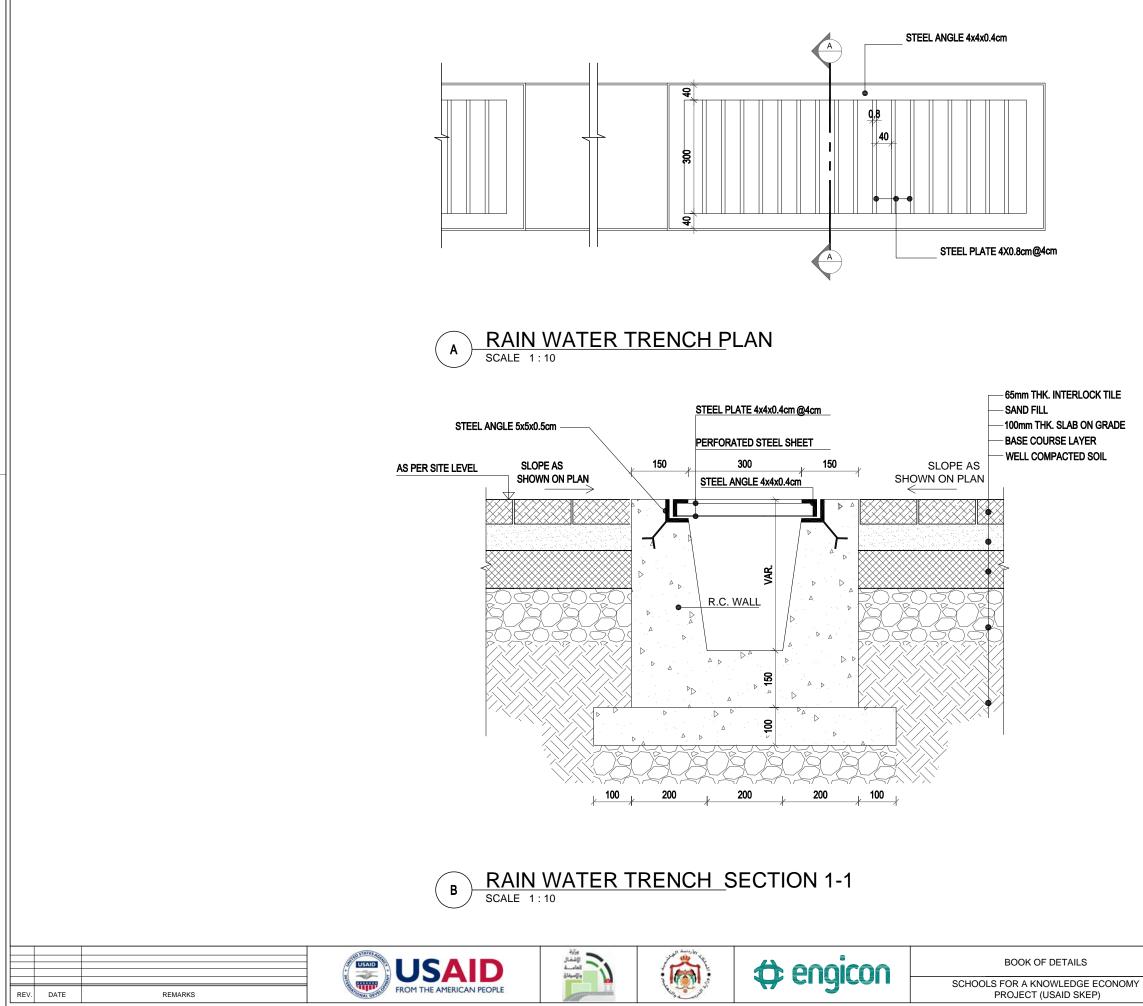


 DRAWING NAME:	a 1		DEL COLONIAL
DRAWING NAME.	Design:	Drawn:	REVISION No. :
	H.B.	Engicon	0
RAIN WATER TRENCH	Checked:	Approved:	SHEET NUMBER:
NAIN WATER TRENGT	M.Sh.	S.B.	
	Date:	SCALE :	LSD-17
	June 2020	ASI05HOWN	

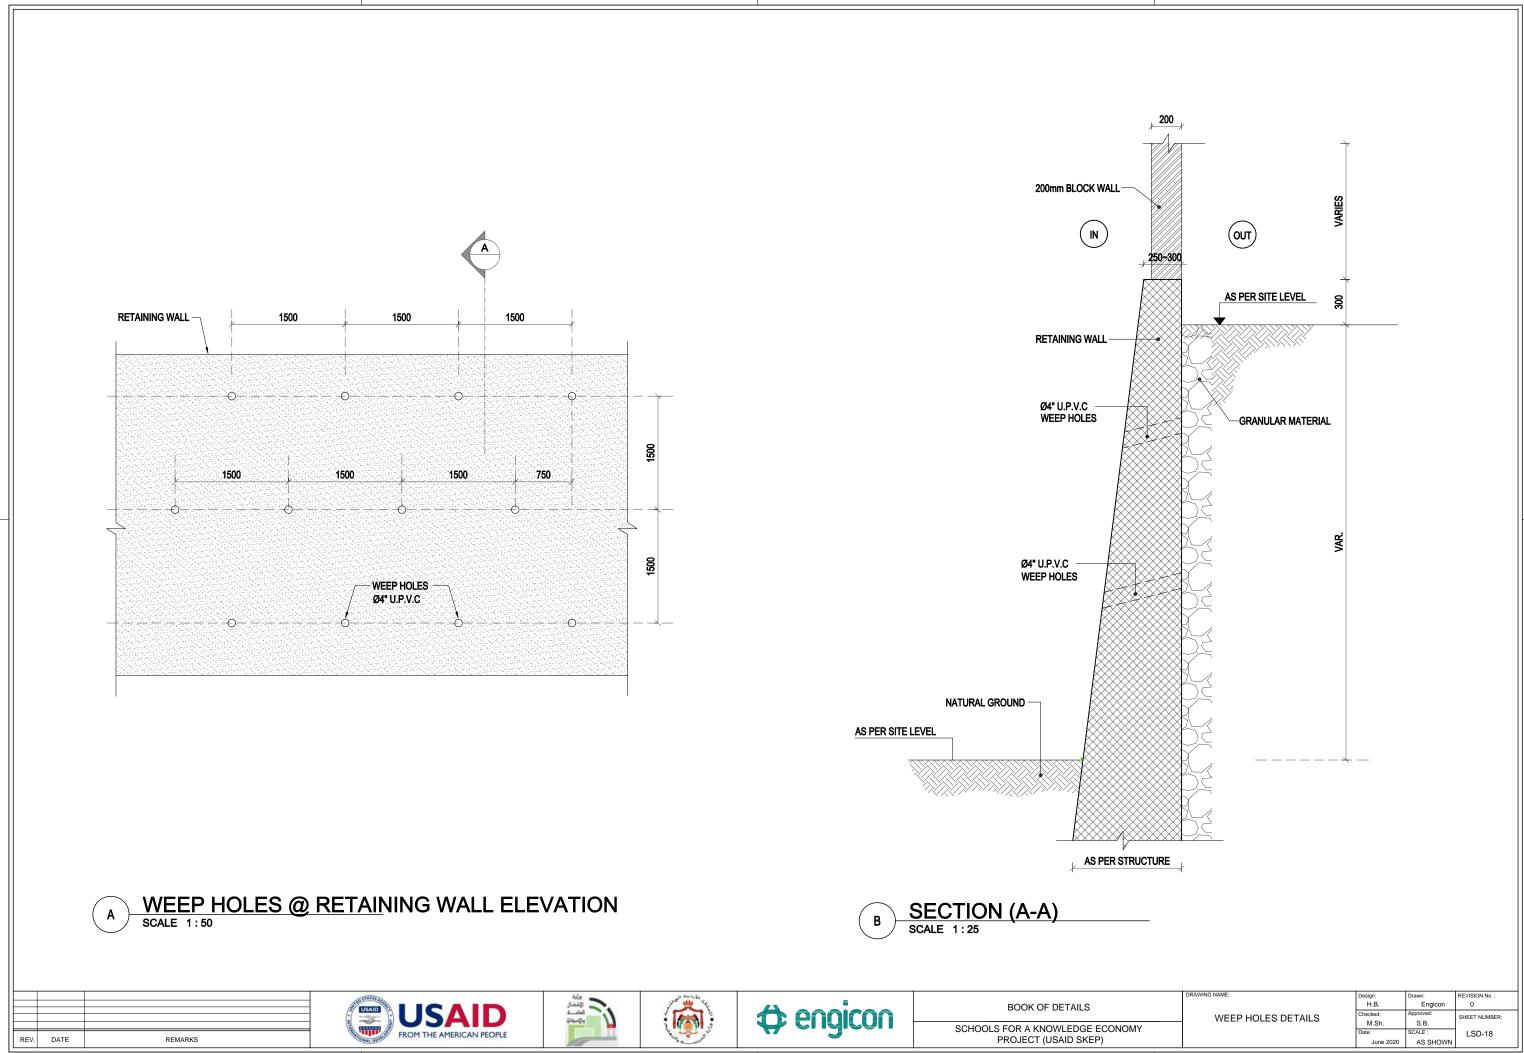

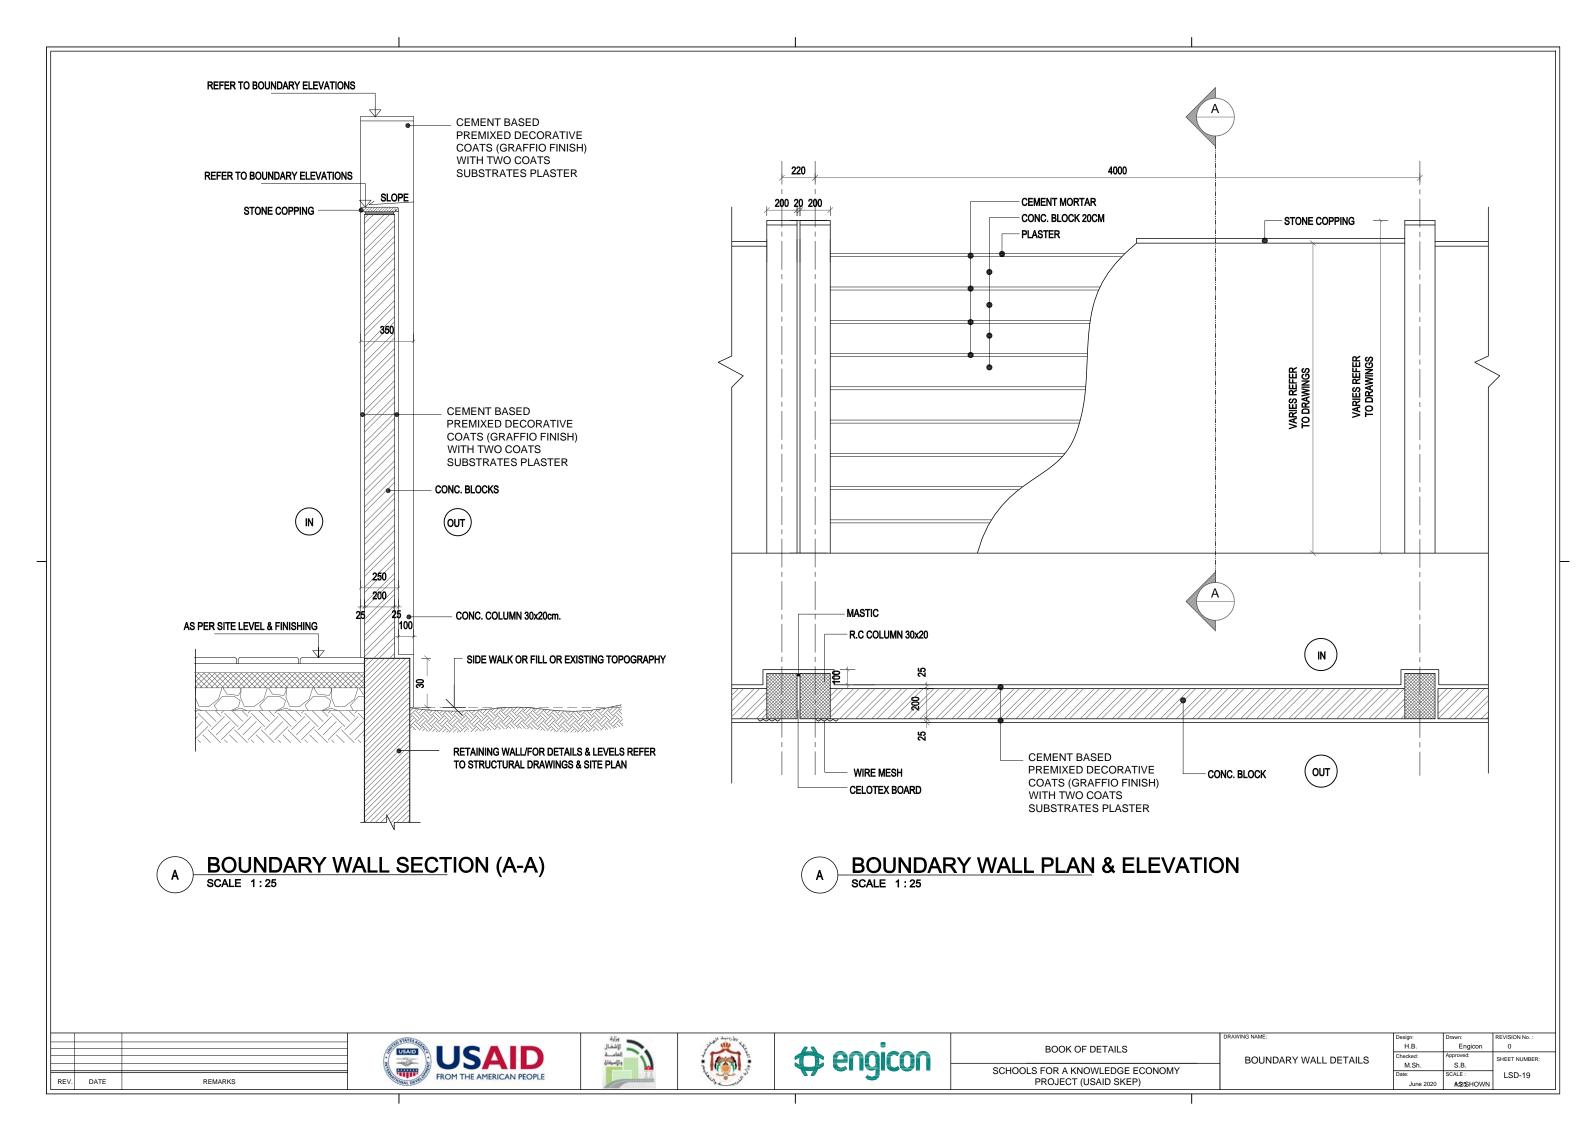


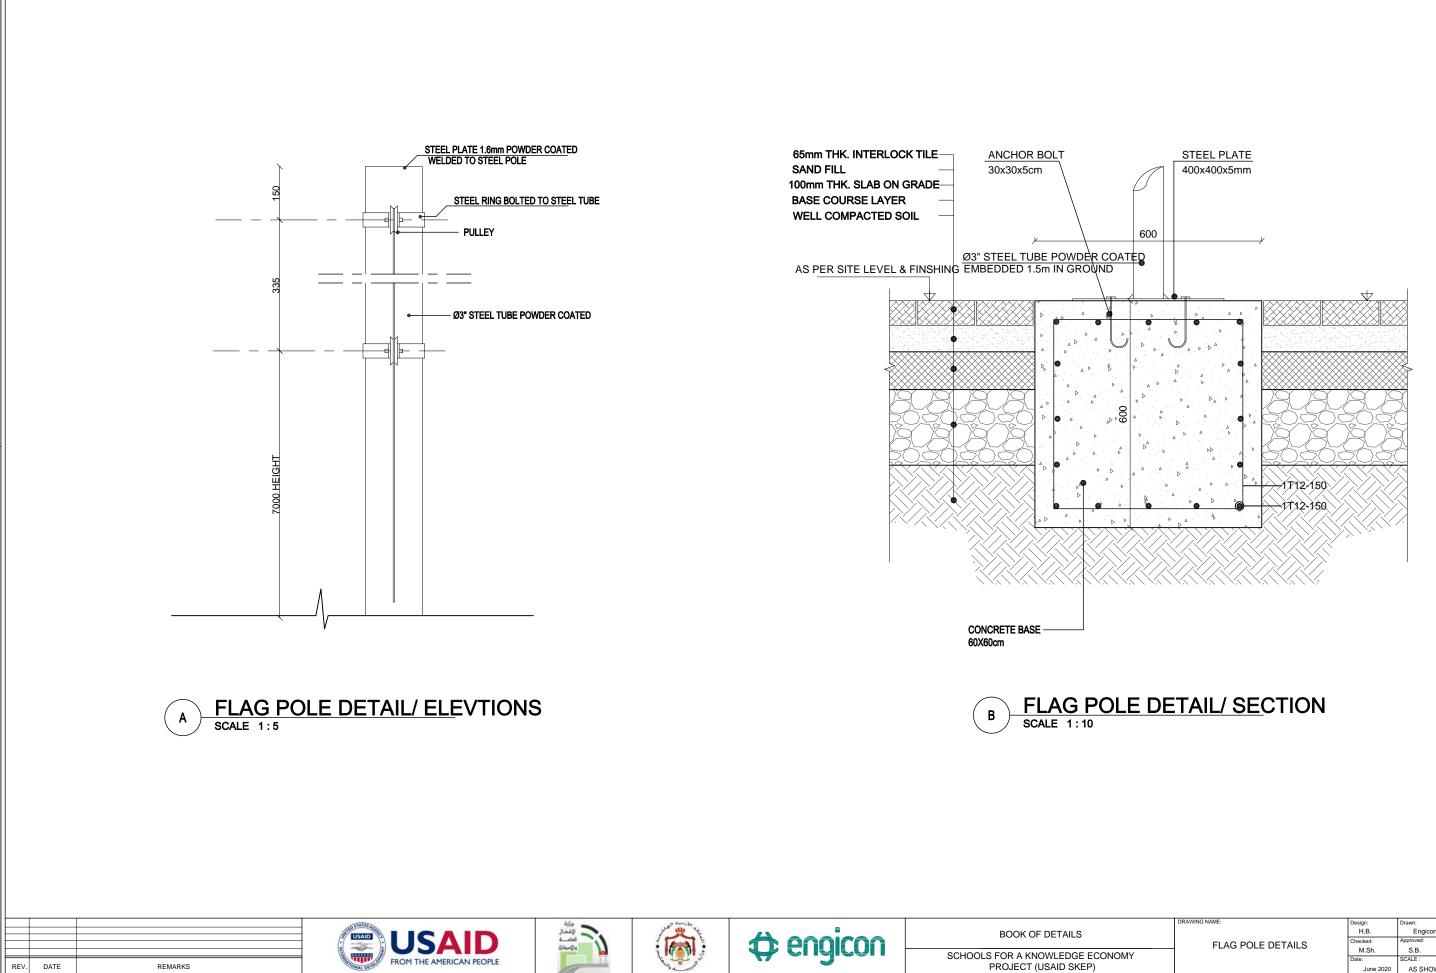


DRAWING NAME:	Design:	Drawn:	REVISION No. :
	H.B.	Engicon	0
FLAG POLE DETAILS	Checked:	Approved:	SHEET NUMBER:
	M.Sh.	S.B.	
	Date:	SCALE :	LSD-20
	June 2020	AS SHOWN	

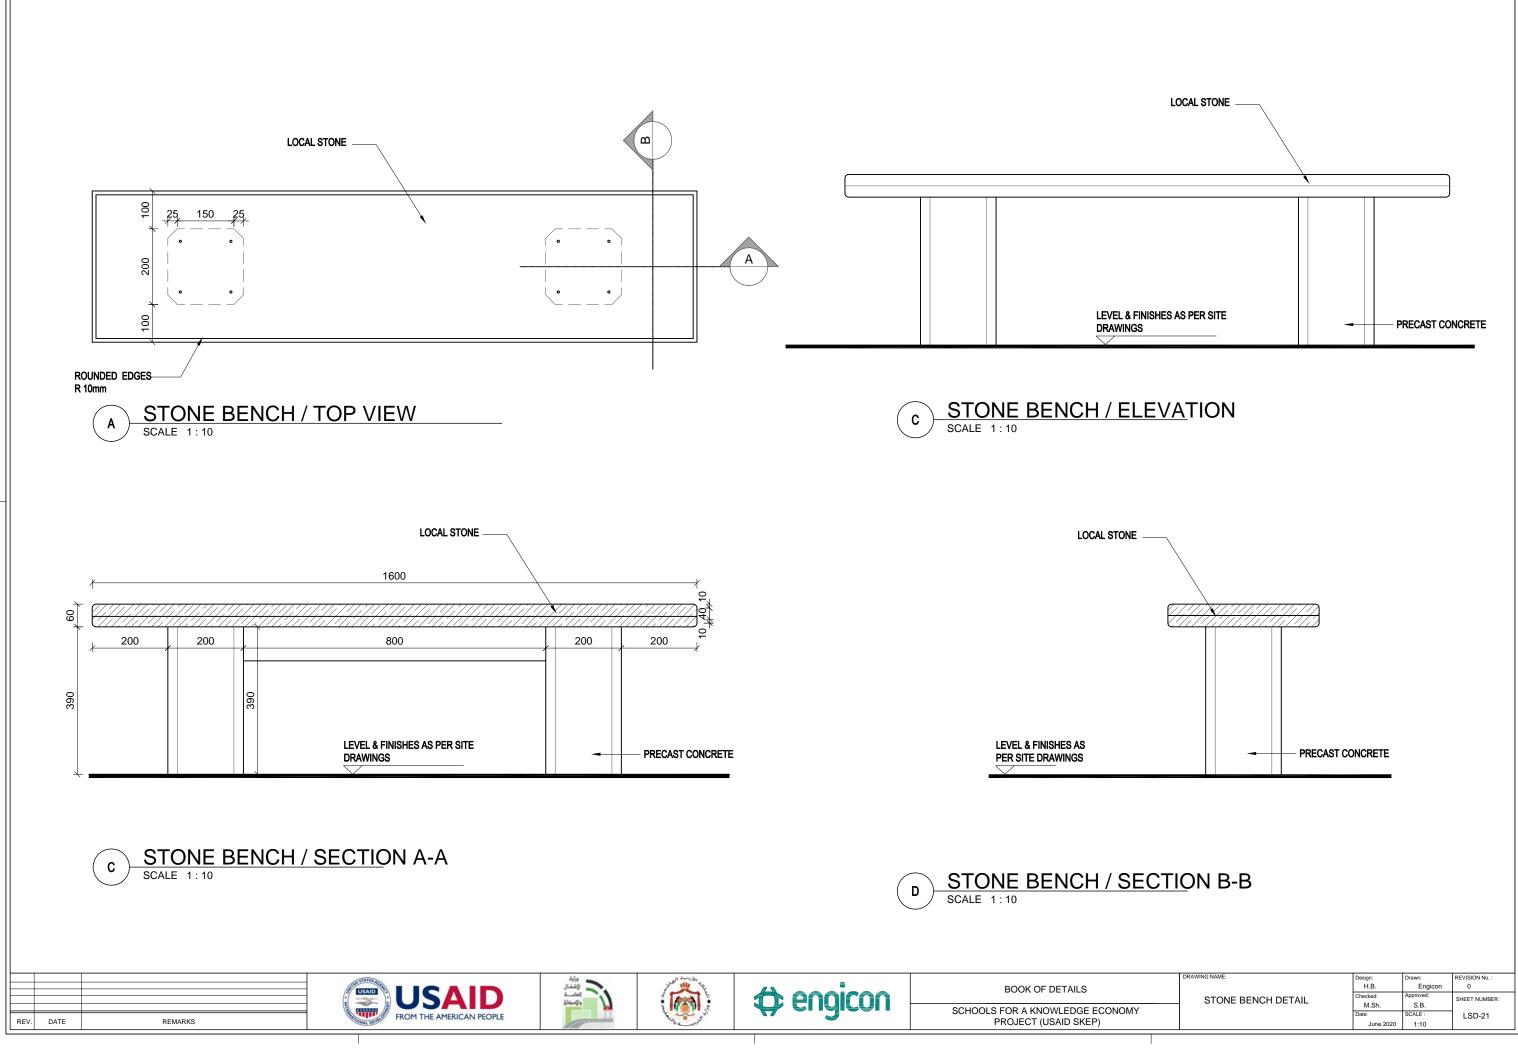



DRAWING NAME:	Design:	Drawn:	REVISION No. :
	H.B.	Engicon	0
STONE BENCH DETAIL	Checked:	Approved:	SHEET NUMBER:
STONE BENGTI DETAIL	M.Sh.	S.B.	
	Date:	SCALE :	LSD-21
	June 2020	1:10	

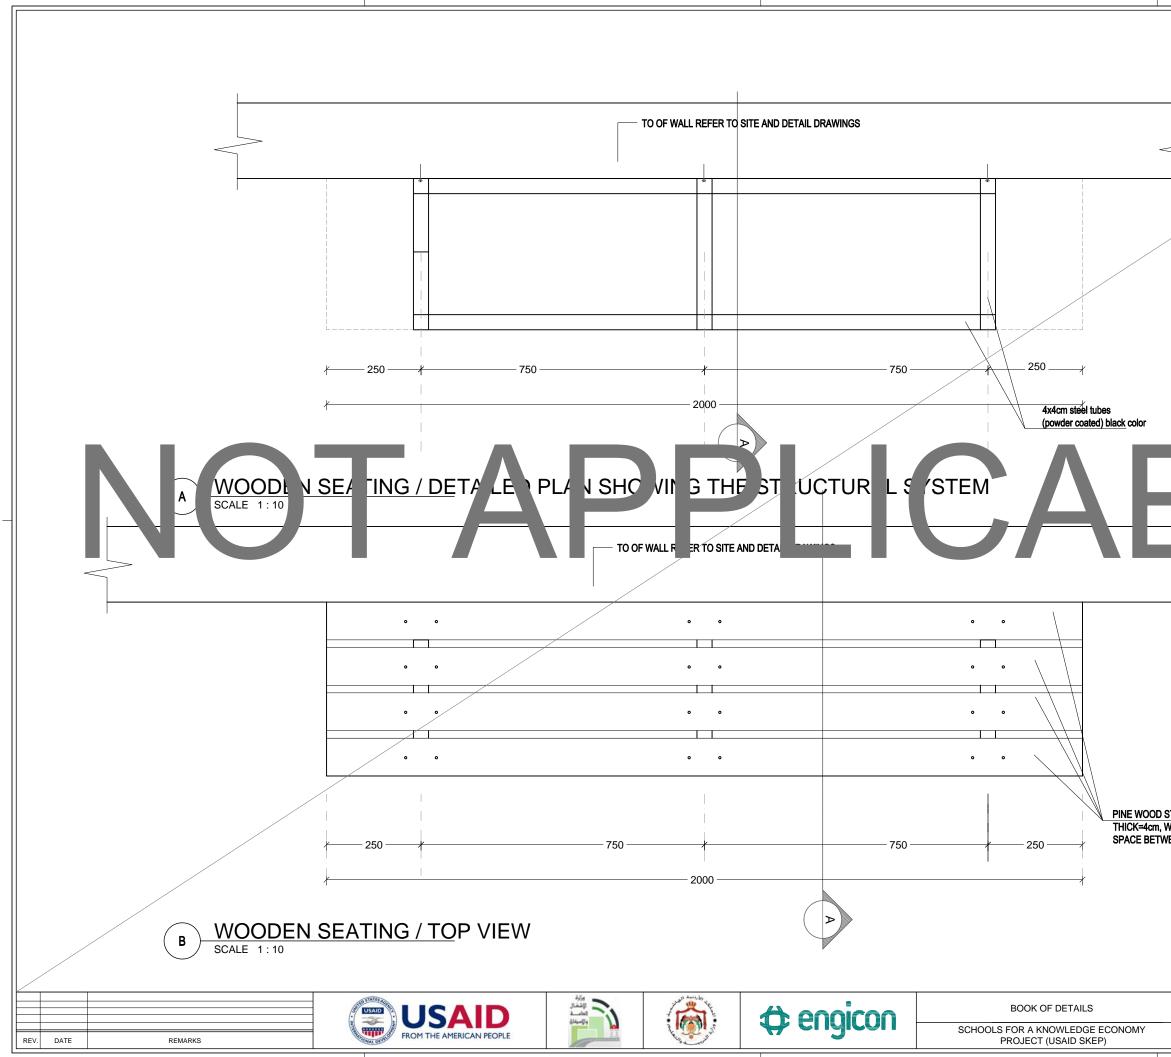


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STRIPS WATER BASE PAINT			
WIDTH=10cm,			
WEEN STRIPS = 2cm			
DRAWING NAME:	Design:	Drawn:	REVISION No. :
WOODEN BENCH TYPE (1) DETAIL	H.B. Checked: M Sh	Engicon Approved: S.B.	0 SHEET NUMBER:
	M.Sh. Date: June 2020	S.B. SCALE : 1:10	LSD-22
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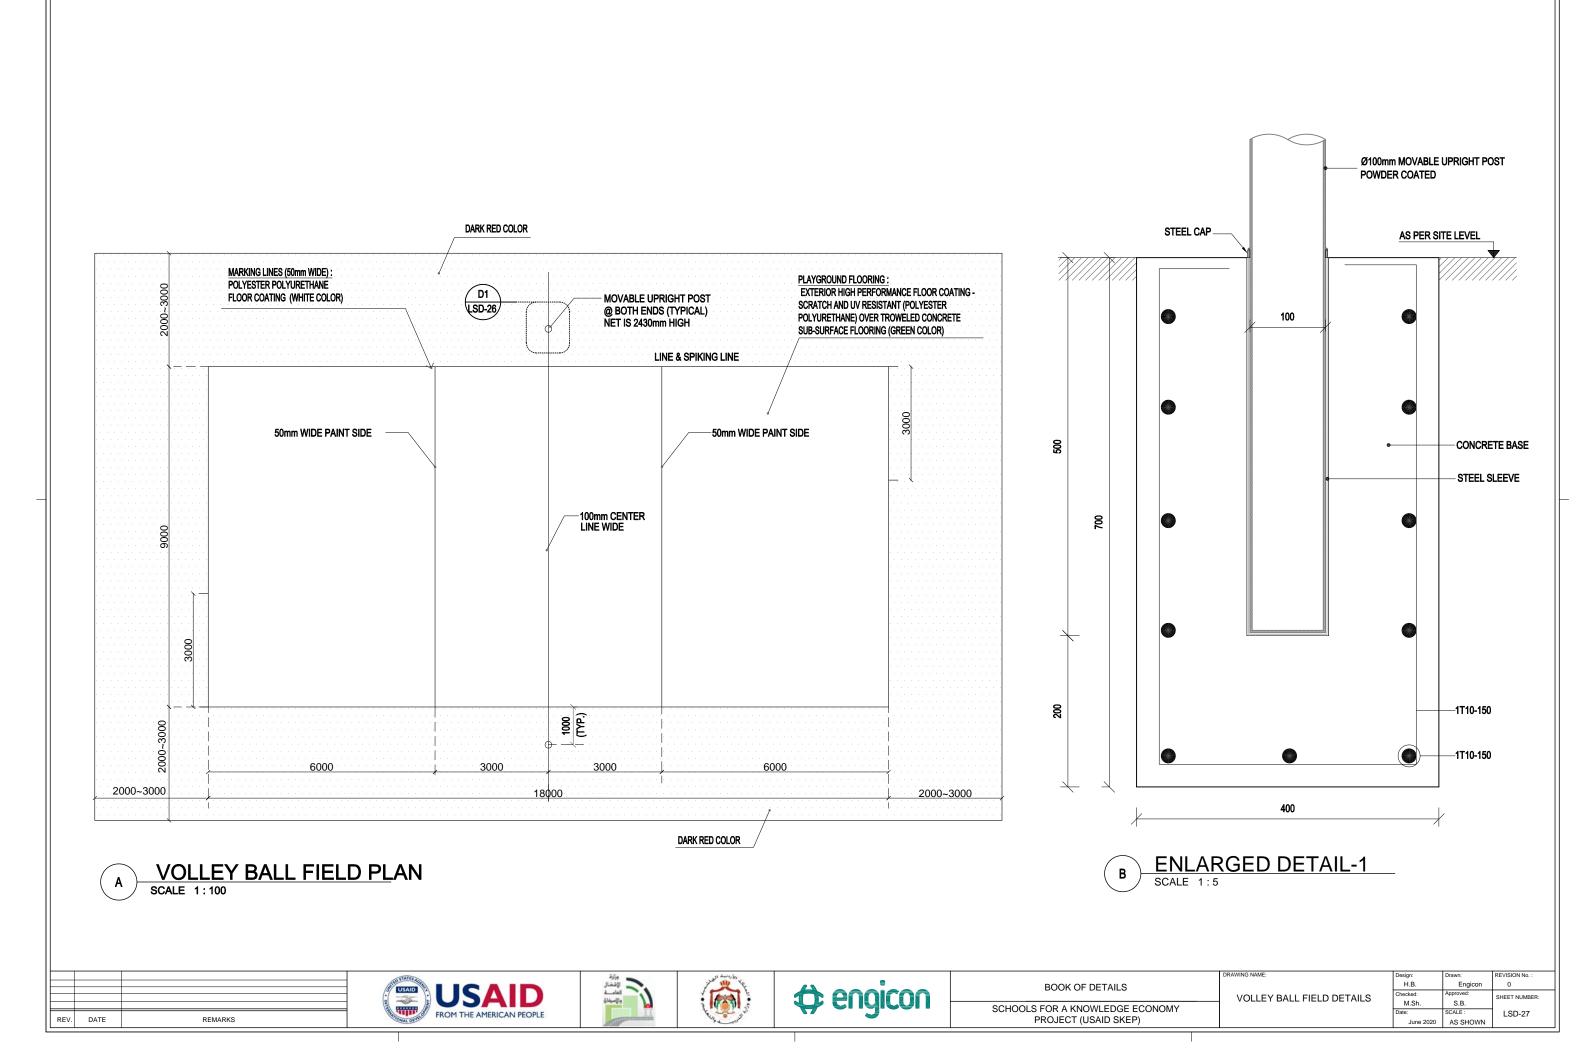


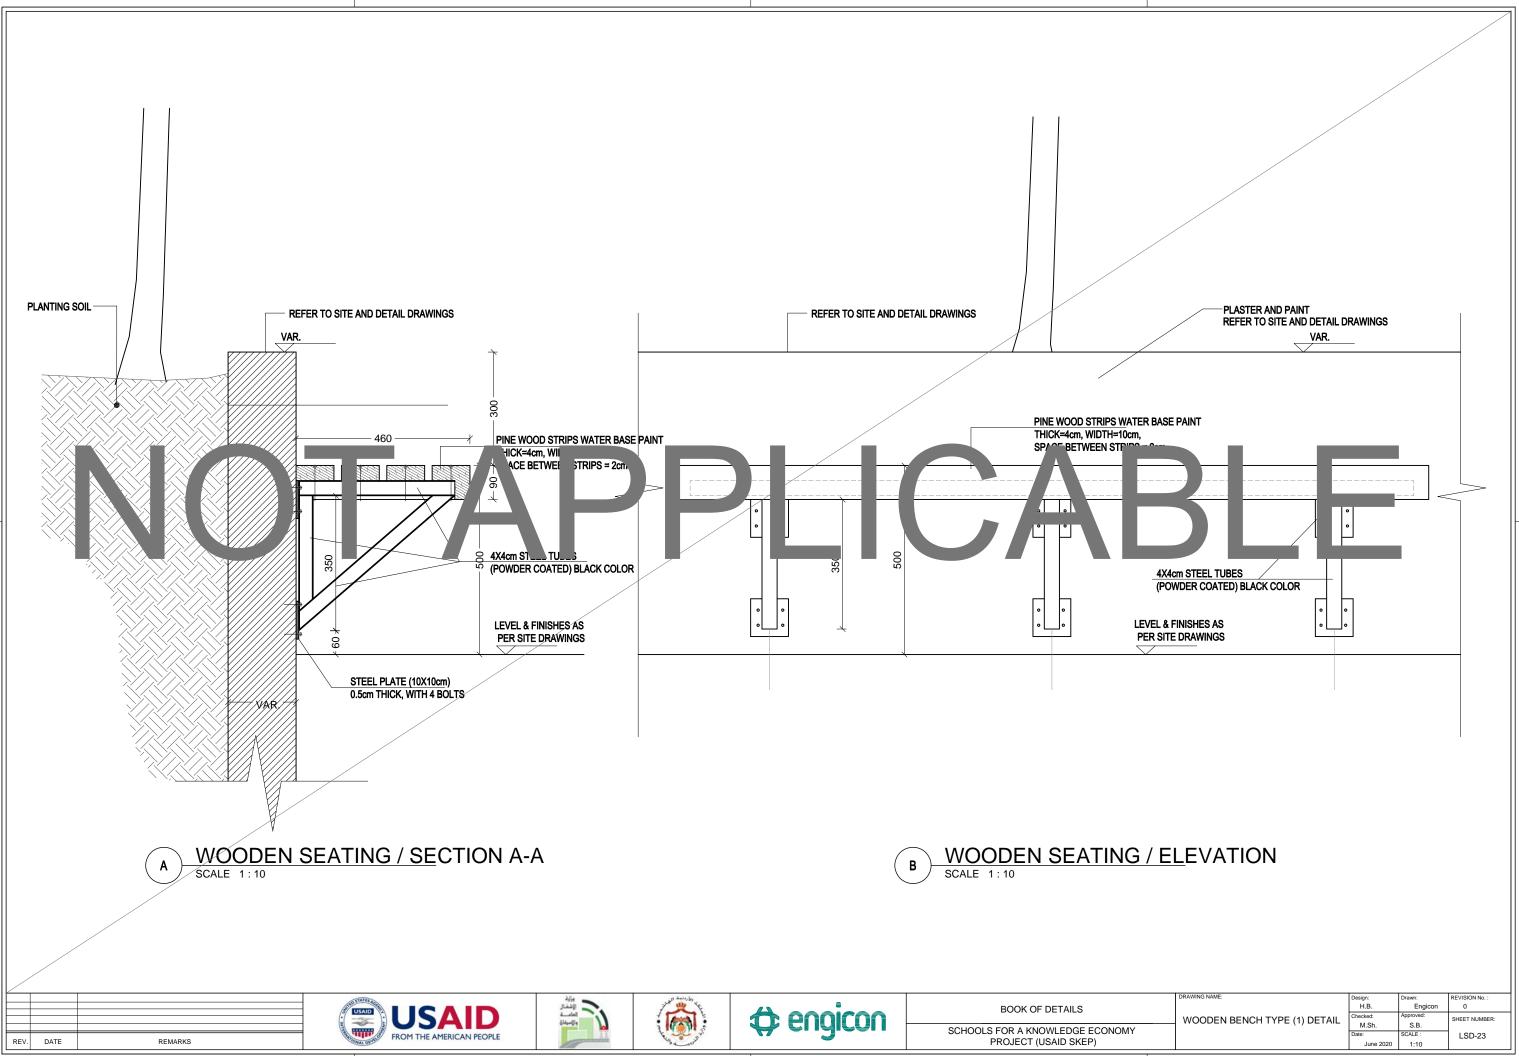


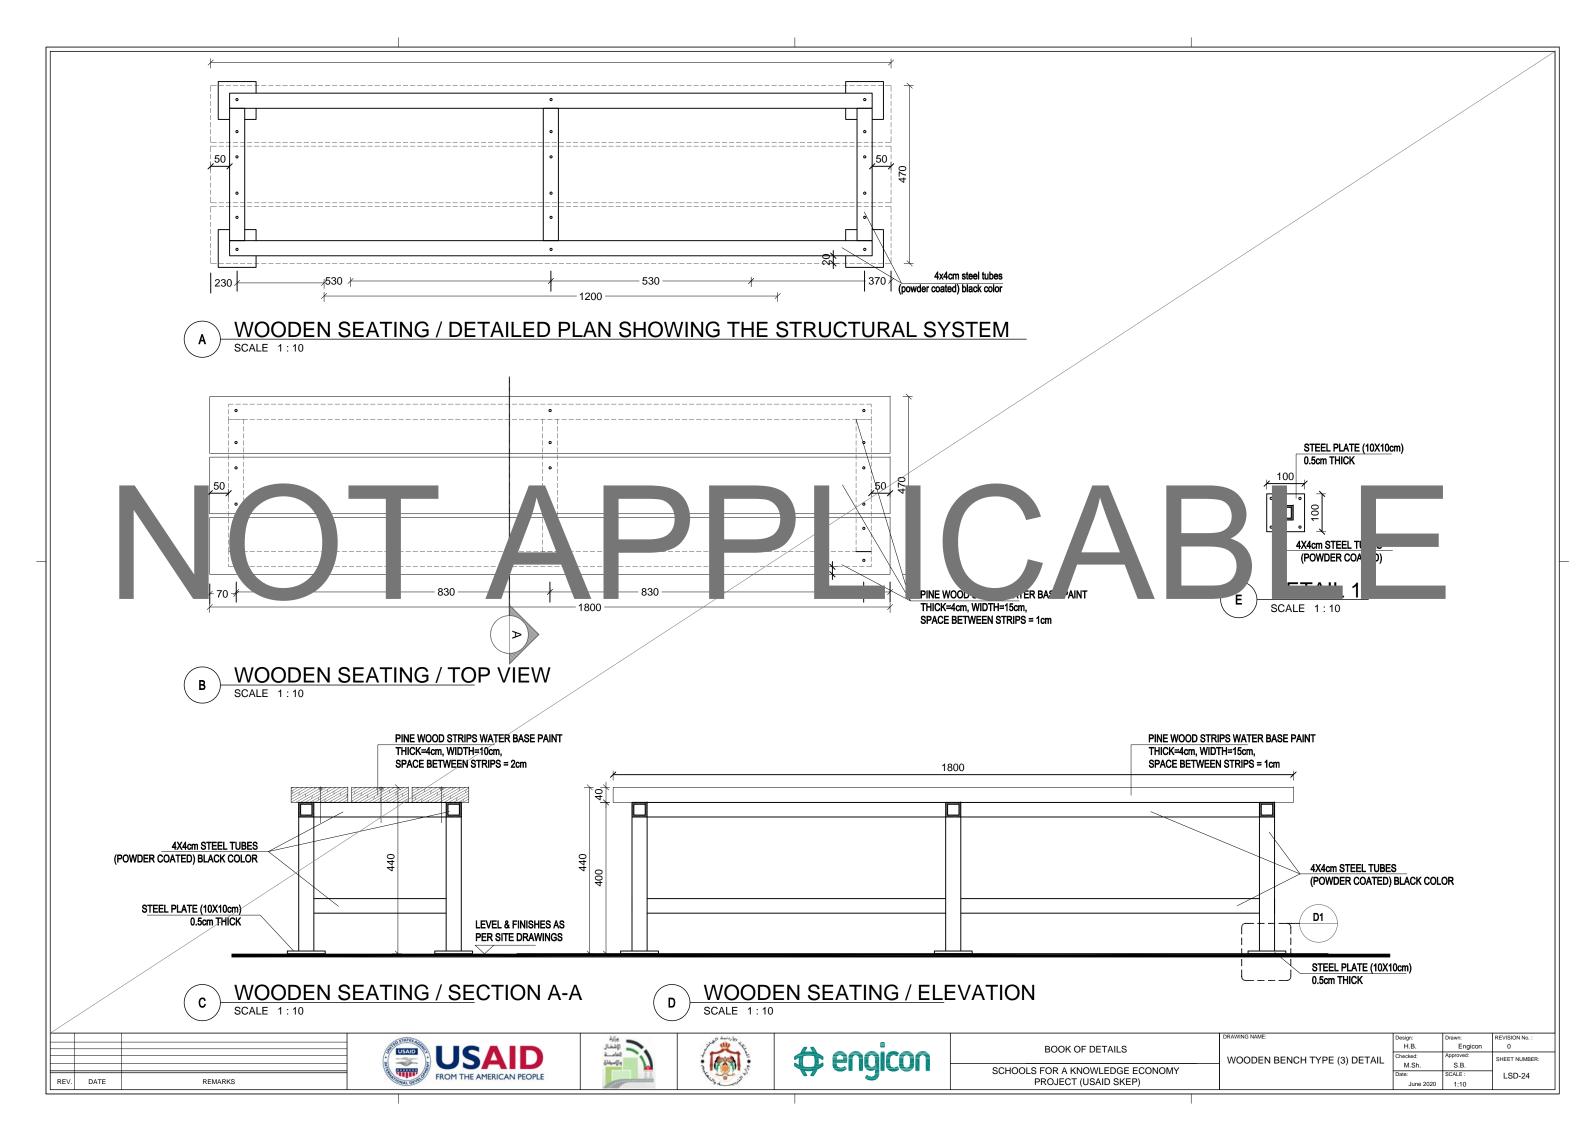


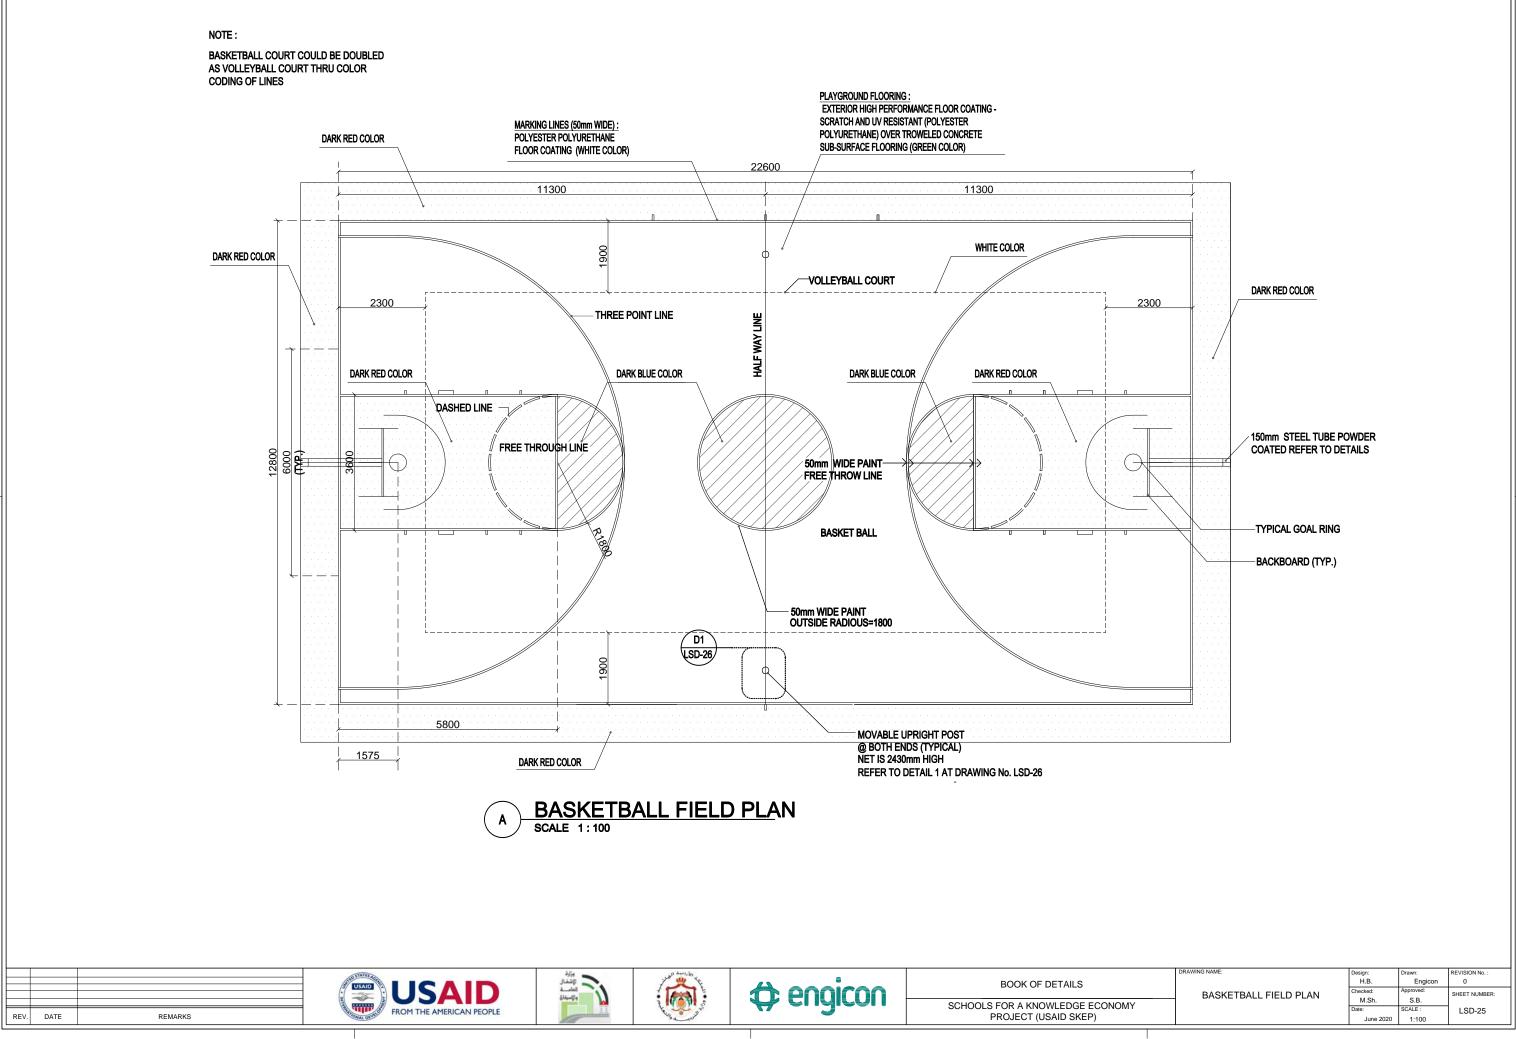


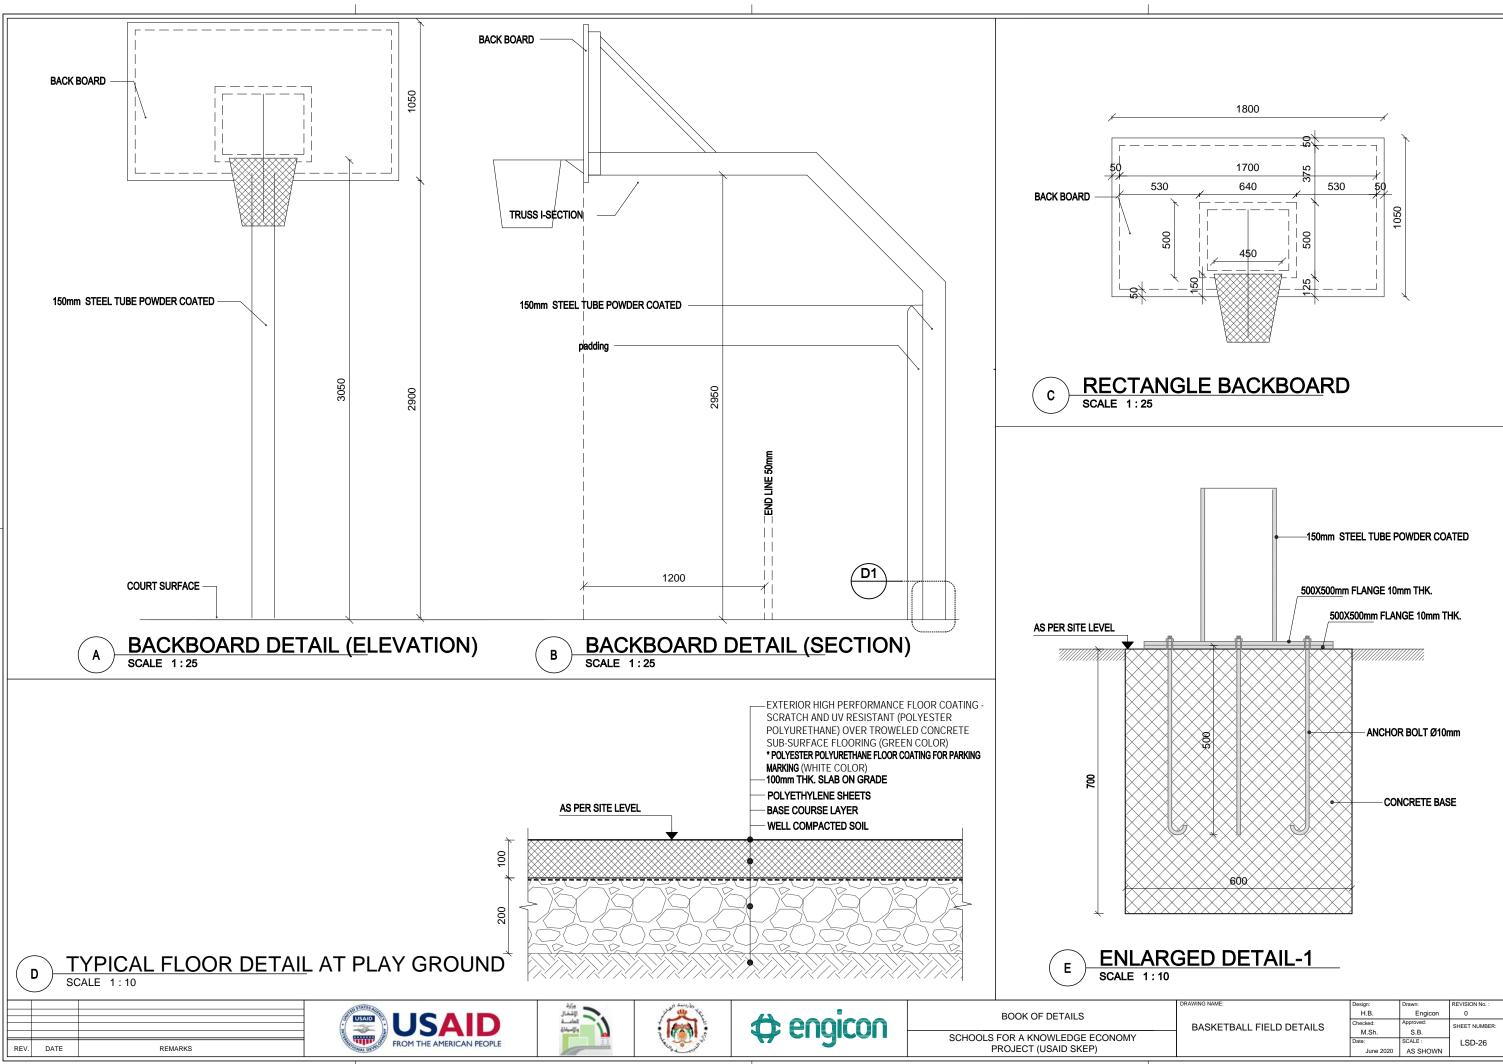
DRAWING NAME:	Design:	Drawn:	REVISION No. :
	H.B.	Engicon	0
BASKETBALL FIELD DETAILS	Checked:	Approved:	SHEET NUMBER:
DAGRETBALL FIELD DETAILS	M.Sh.	S.B.	UNEET NOMBER
	Date:	SCALE :	LSD-26
	June 2020	AS SHOWN	



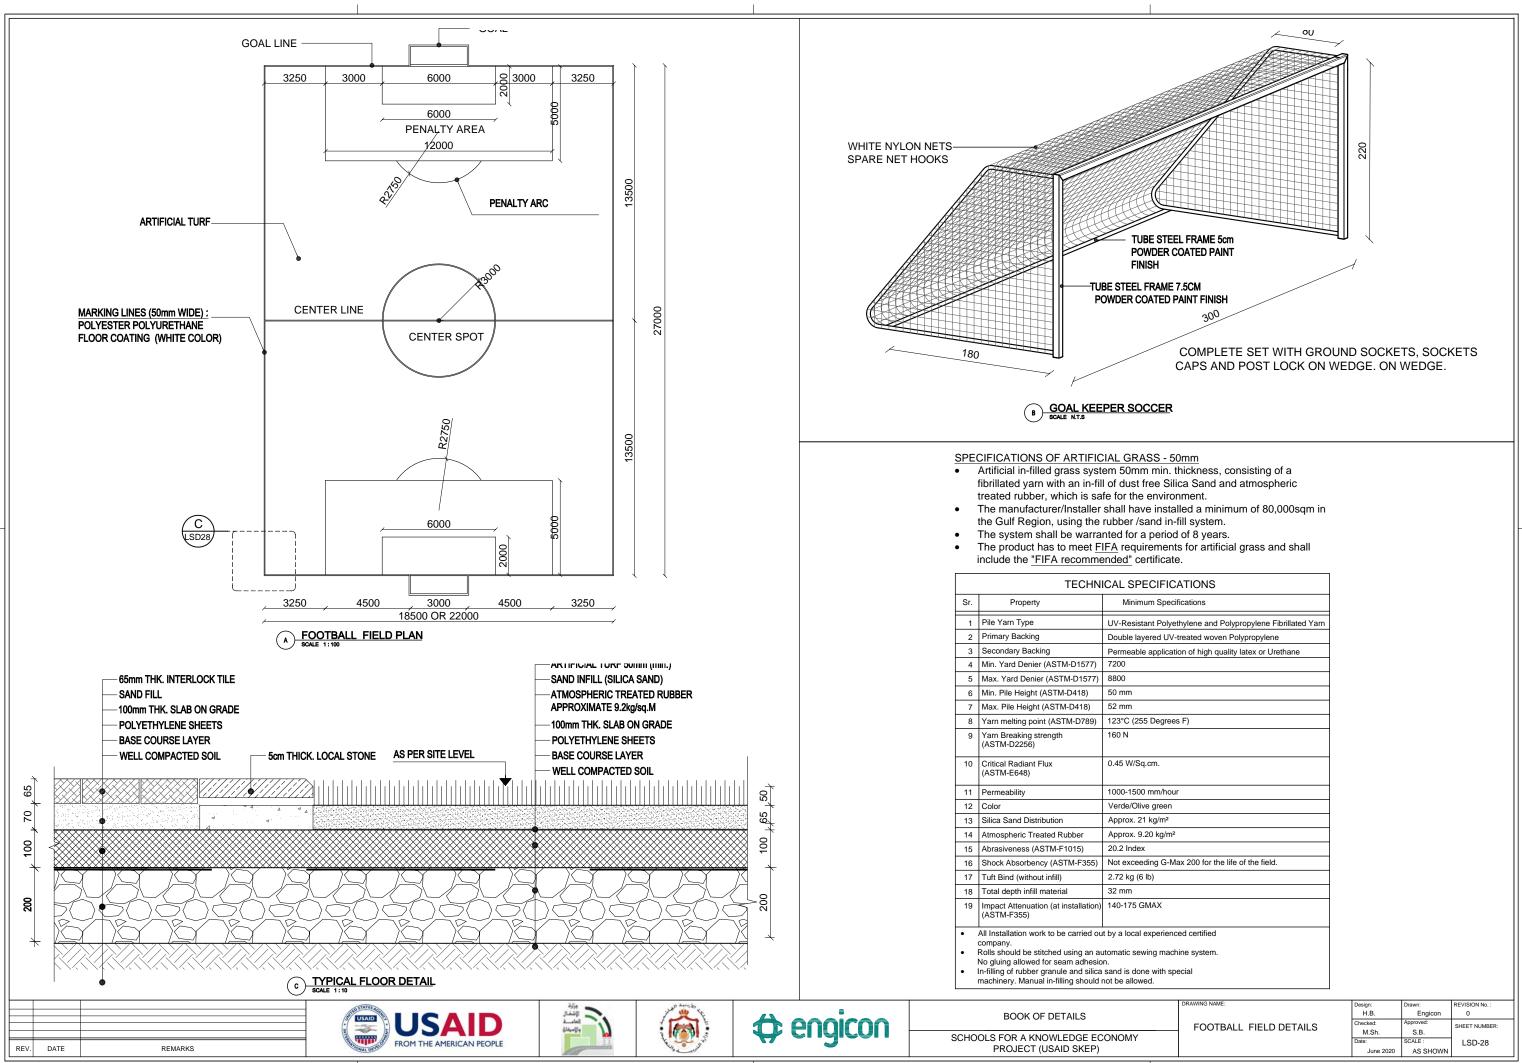

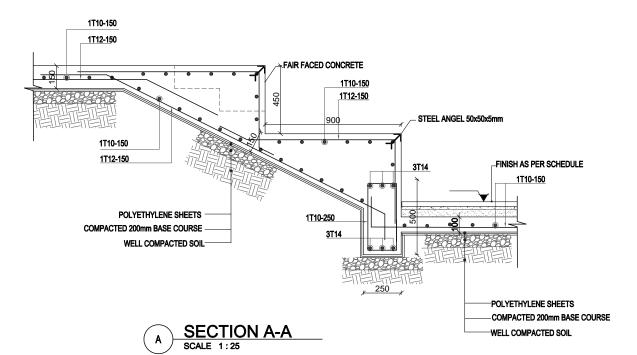

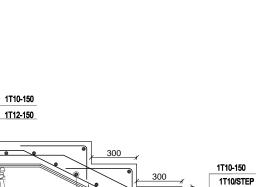

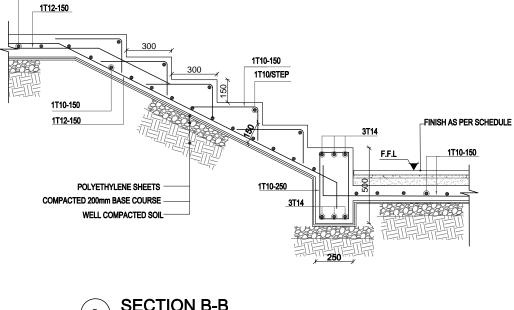





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EXTERNAL STEPS(AMPHITHEATER) / PLAN SCALE 1:25

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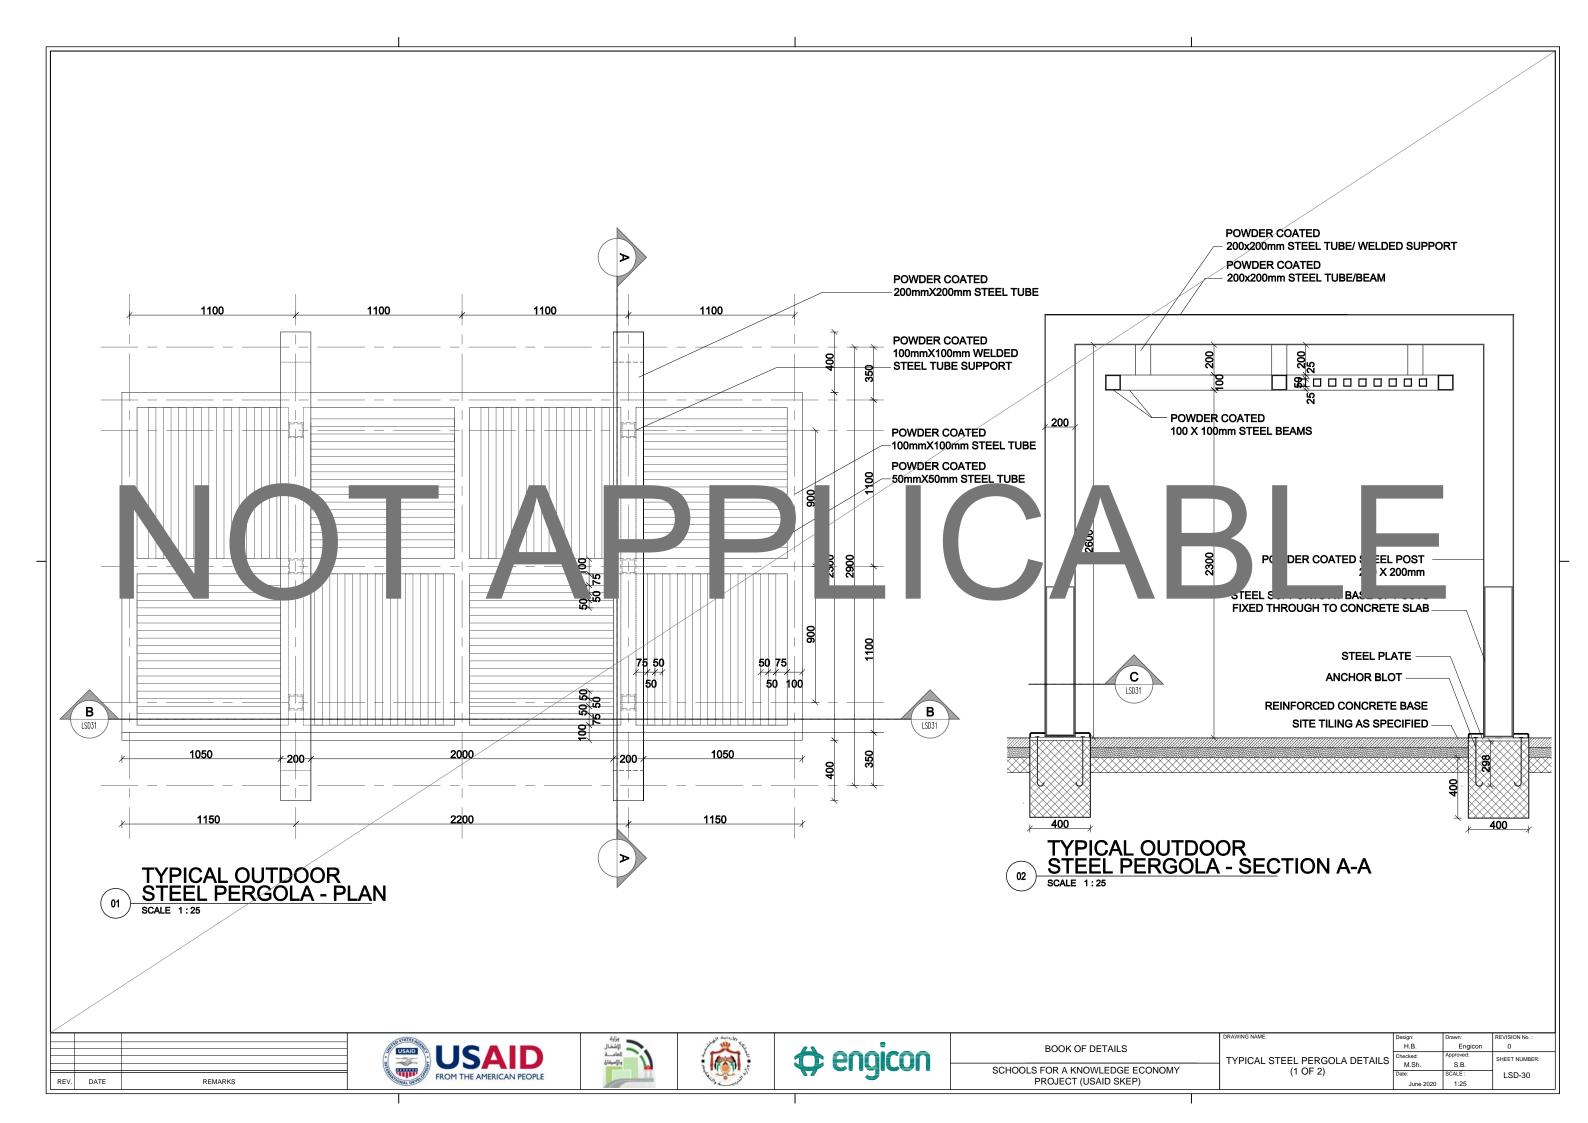






BOOK OF DETAILS


SCHOOLS FOR A KNOWLEDGE ECONOMY PROJECT (USAID SKEP)

EXTERNAL STEPS (AMPHITHEATER)	Design: H.B.	Drawn: Engicon	REVISION No. : 0	
	Checked: M.Sh.	Approved: S.B.	SHEET NUMBER:	
(AMPHITHEATER)	Date:	SCALE :	LSD-29	
	June 2020	1:25		L



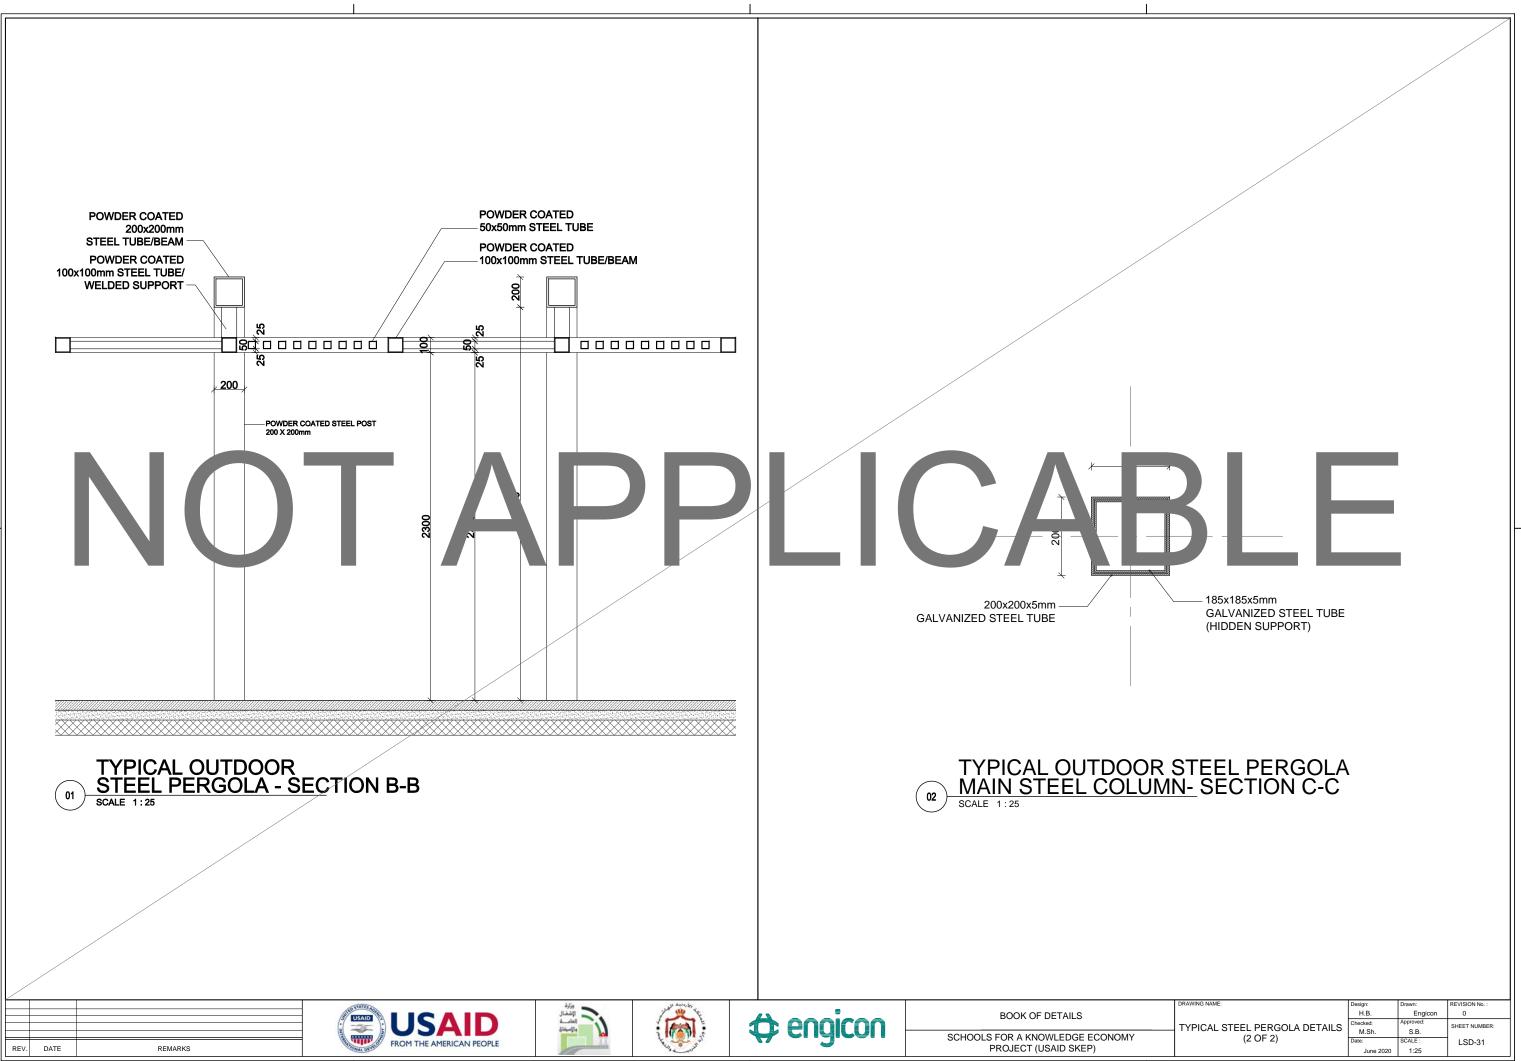

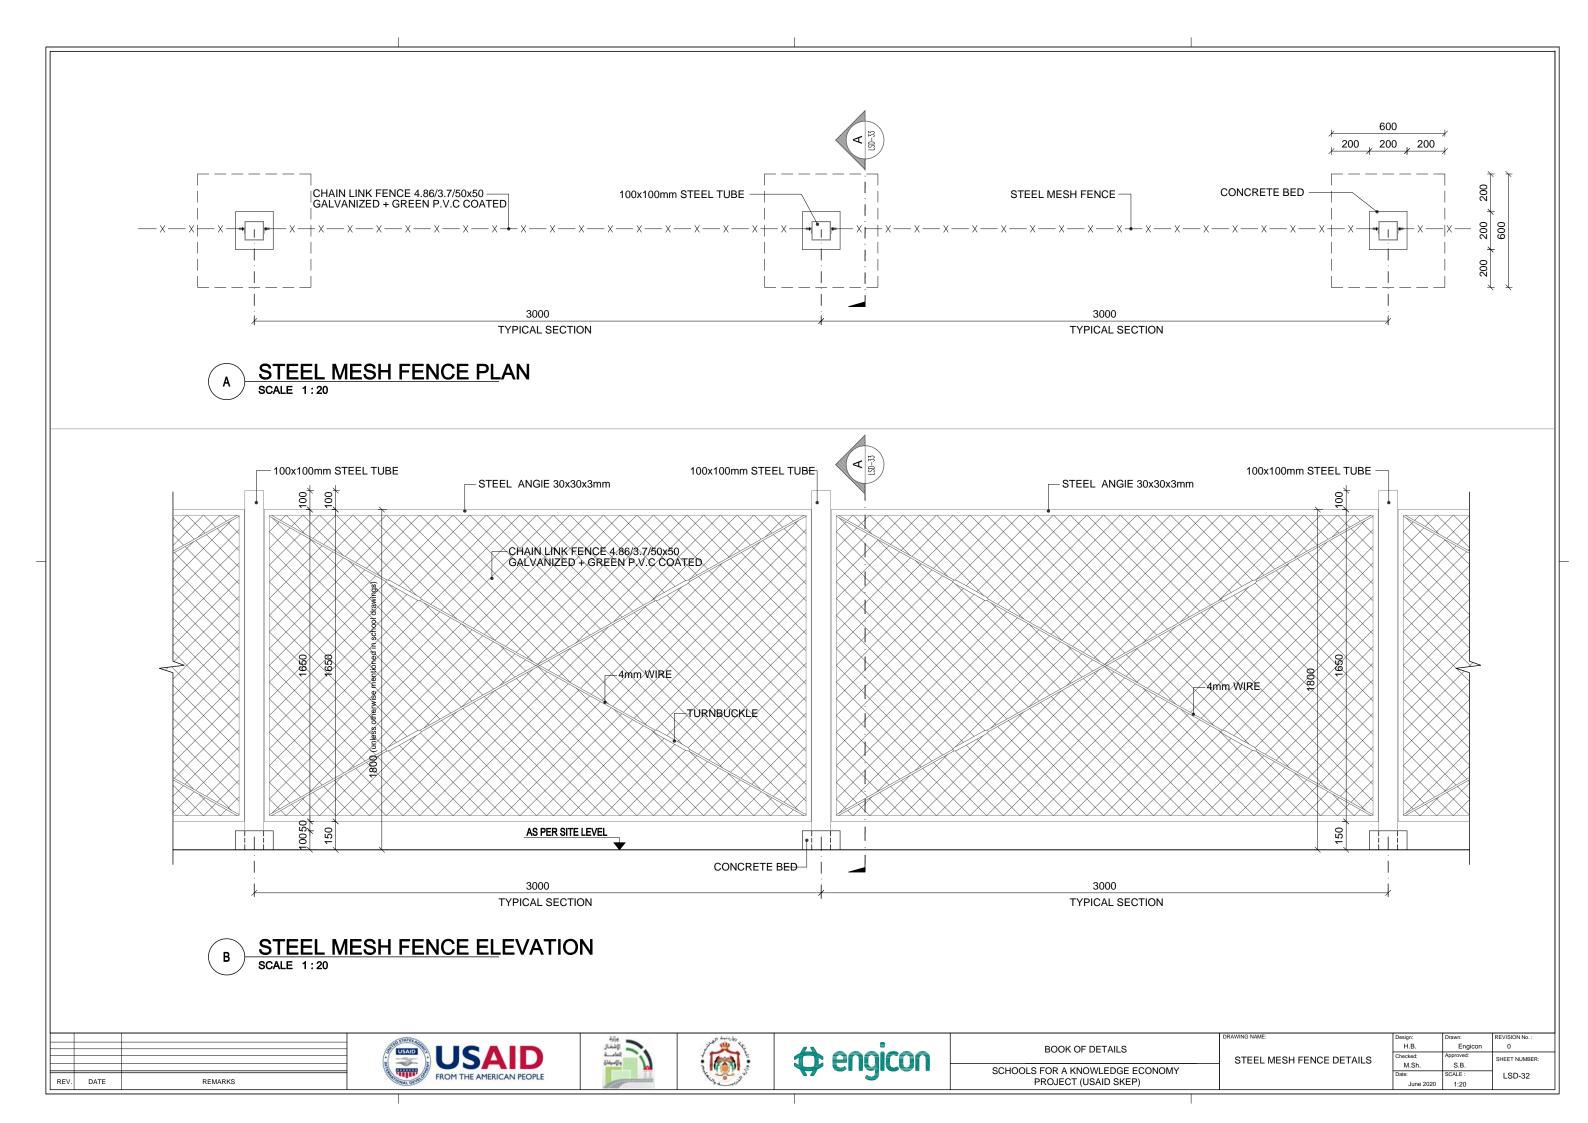

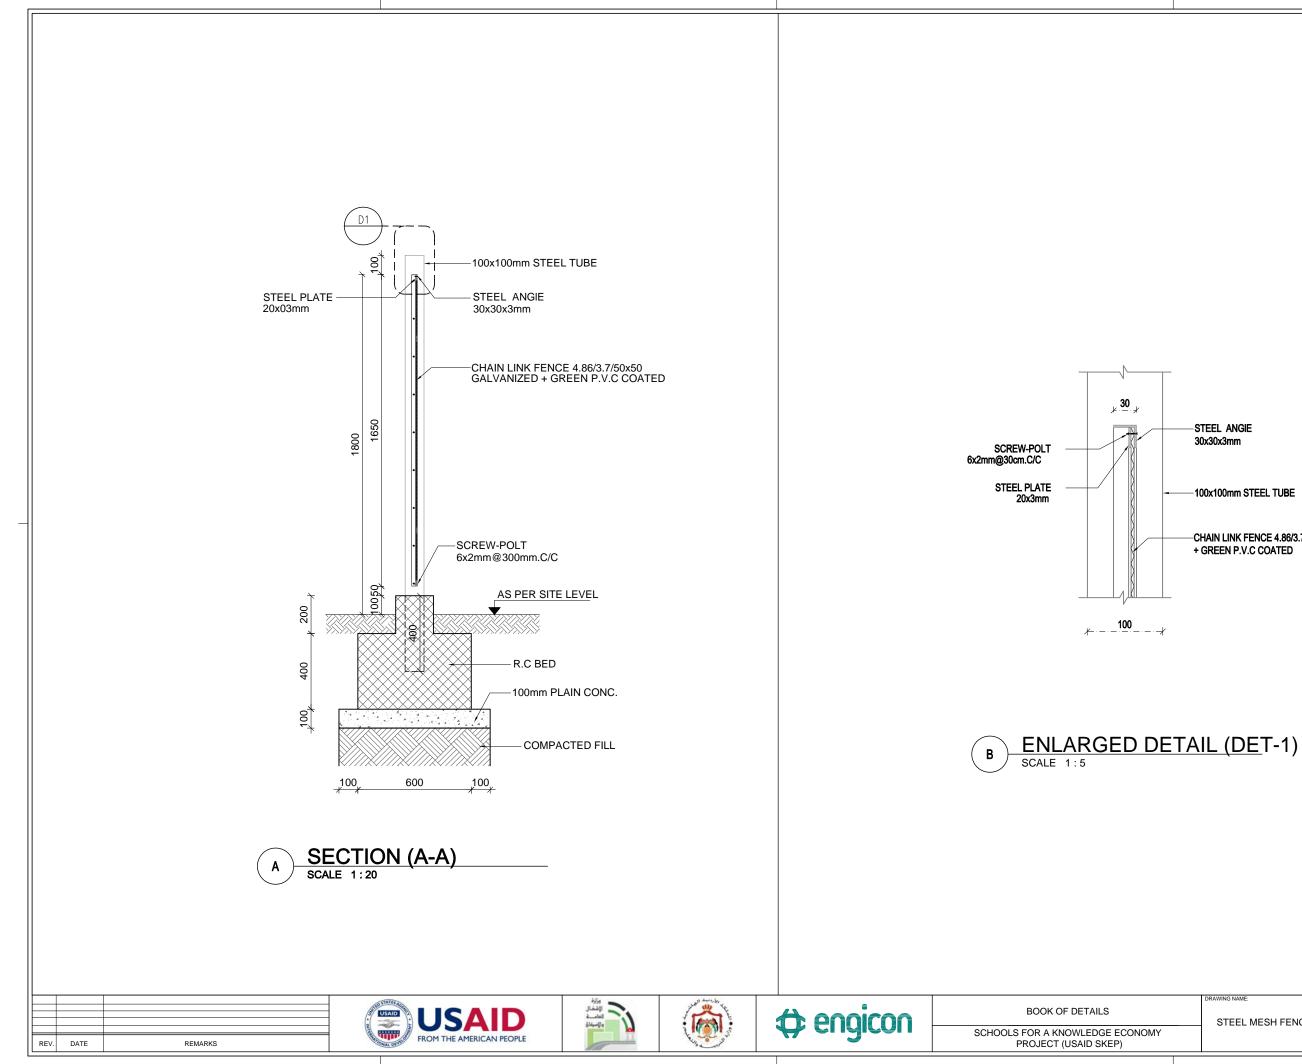


STEEL ANGIE 30x30x3mm

-100x100mm STEEL TUBE

-CHAIN LINK FENCE 4.86/3.7/50x50 GALVANIZED + GREEN P.V.C COATED

DRAWING NAME:	Design:	Drawn:	REVISION No. :
	H.B.	Engicon	0
STEEL MESH FENCE DETAILS	Checked:	Approved:	SHEET NUMBER:
STELL MESTTENCE DETAILS	M.Sh.	S.B.	
	Date:	SCALE :	LSD-33
	June 2020	AS SHOWN	

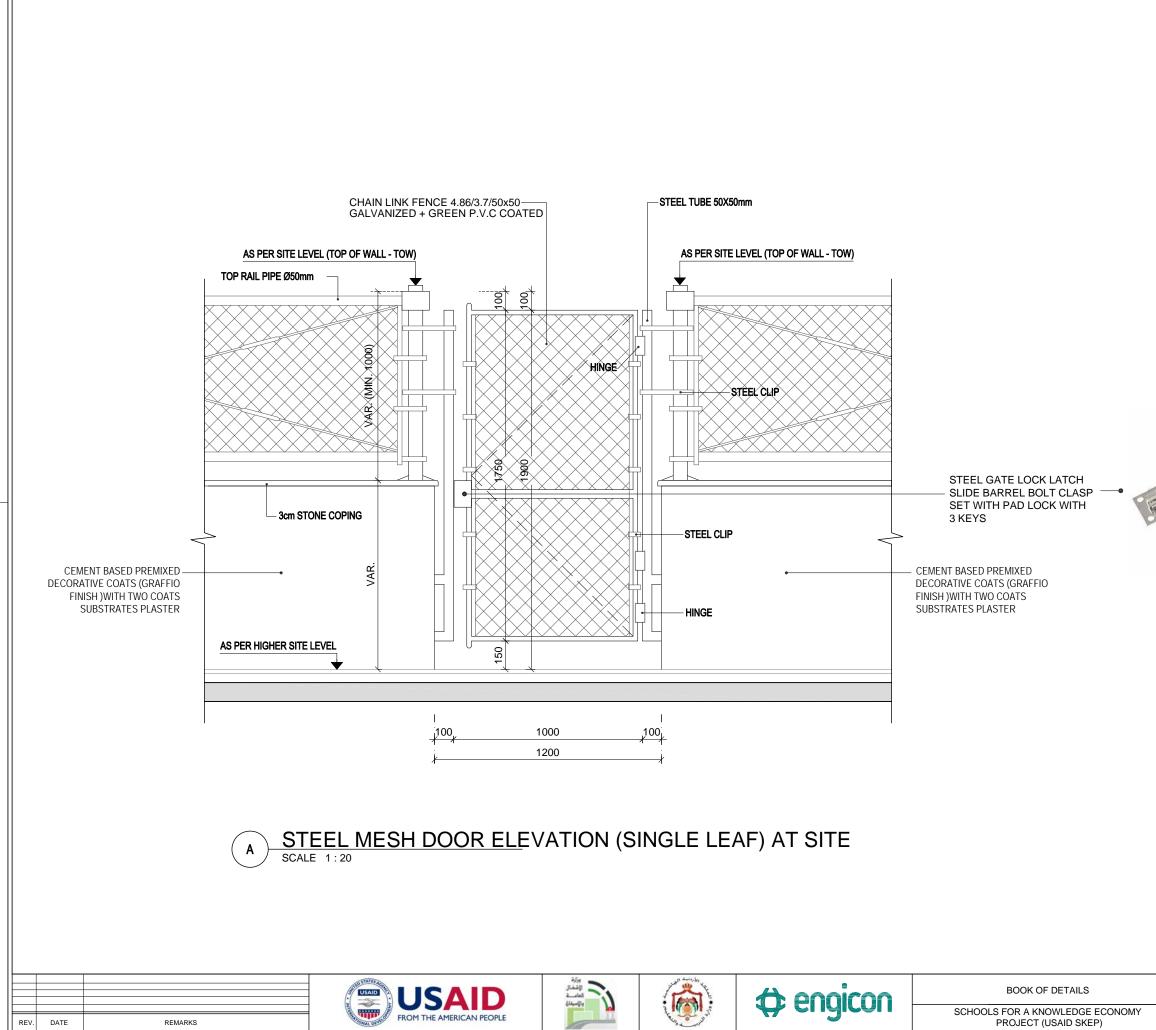









Pad lock with 3 Keys

DRAWING NAME:	Design:	Drawn:	REVISION No. :	
	H.B.	Engicon	0	
STEEL MESH DOOR DETAIL	Checked:	Approved:	SHEET NUMBER:	
STEEL WESH DOOR DETAIL	M.Sh.	S.B.	GHEET HOMBER	
	Date:	SCALE :	LSD-34	
	June 2020	1:20		

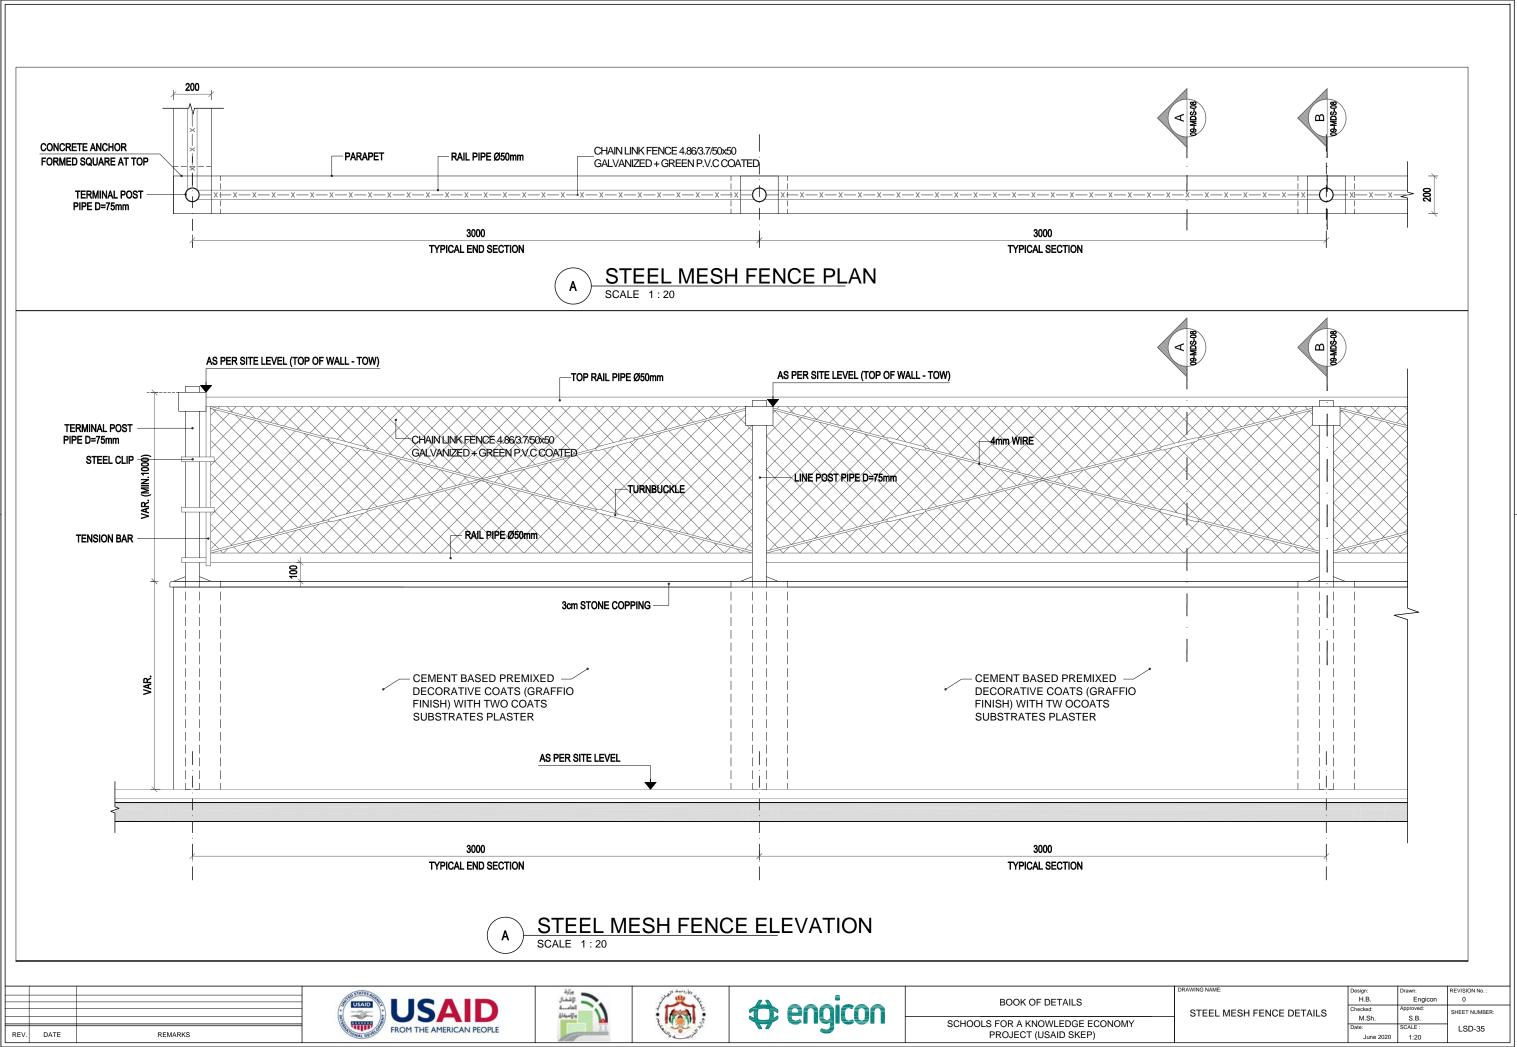

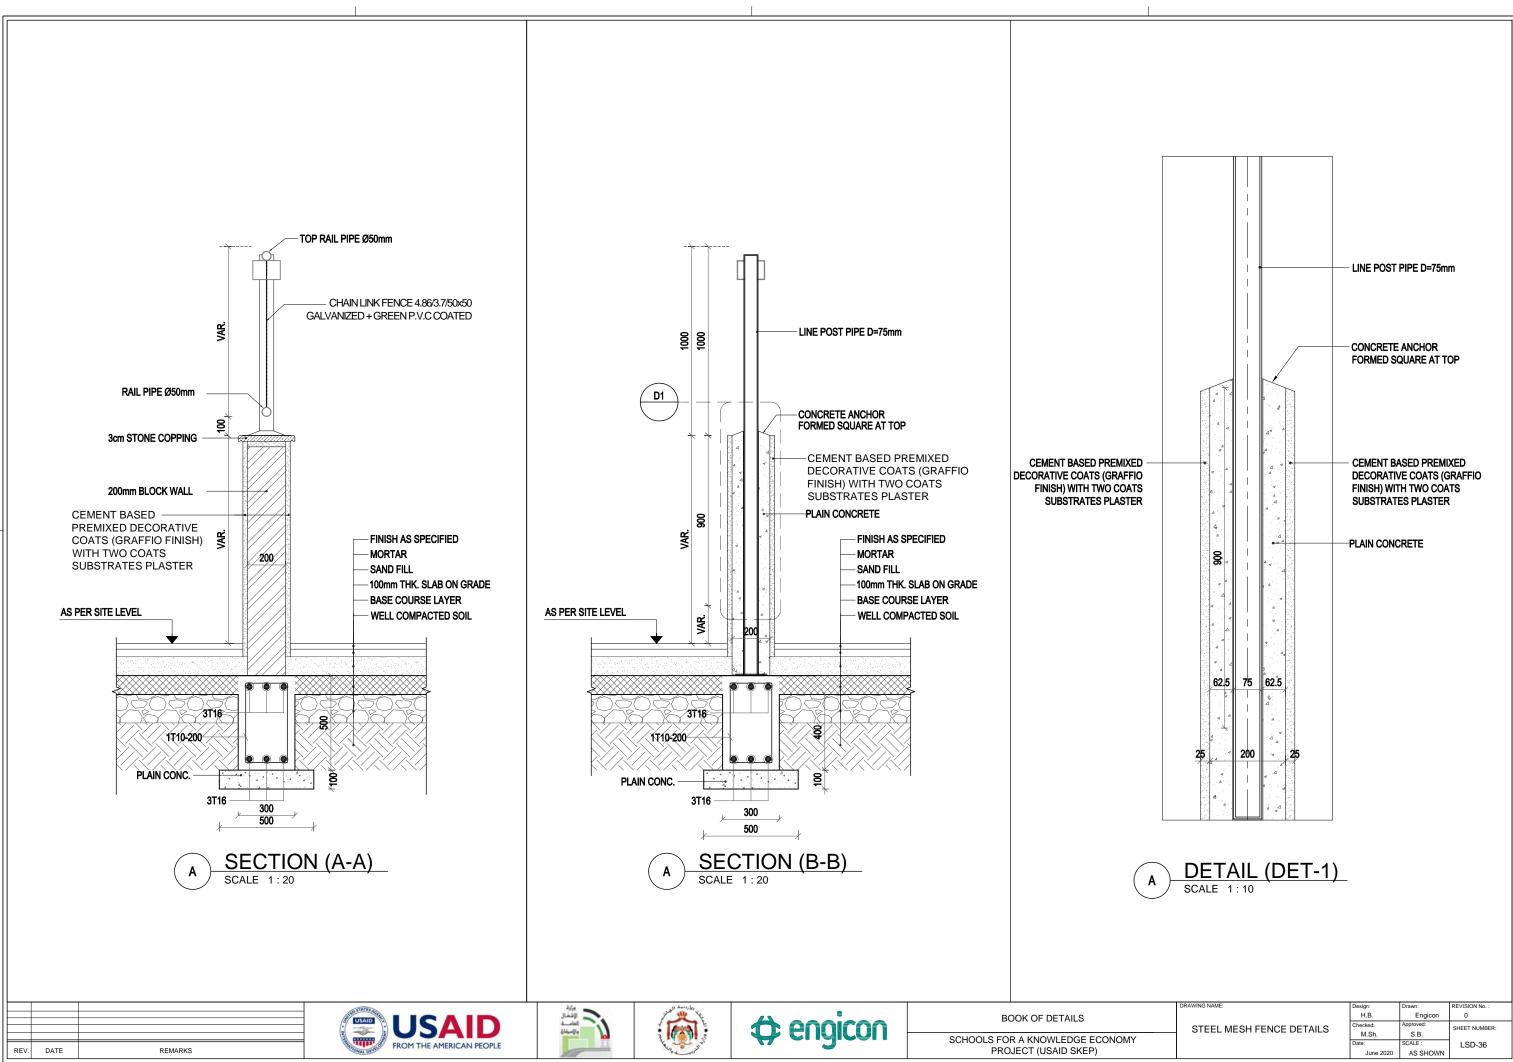


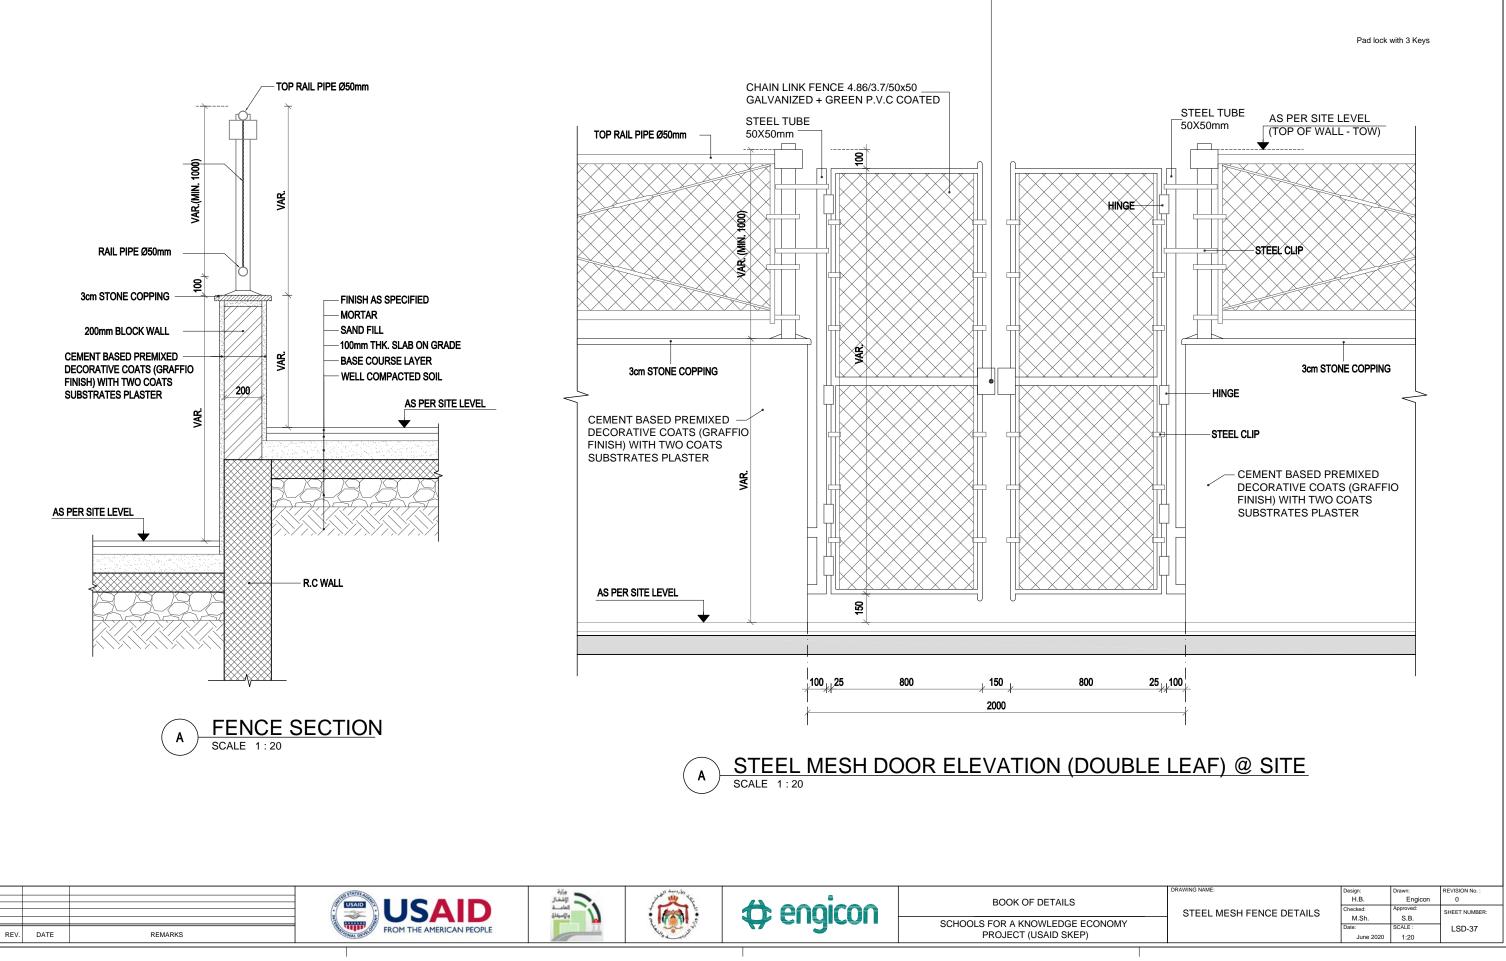


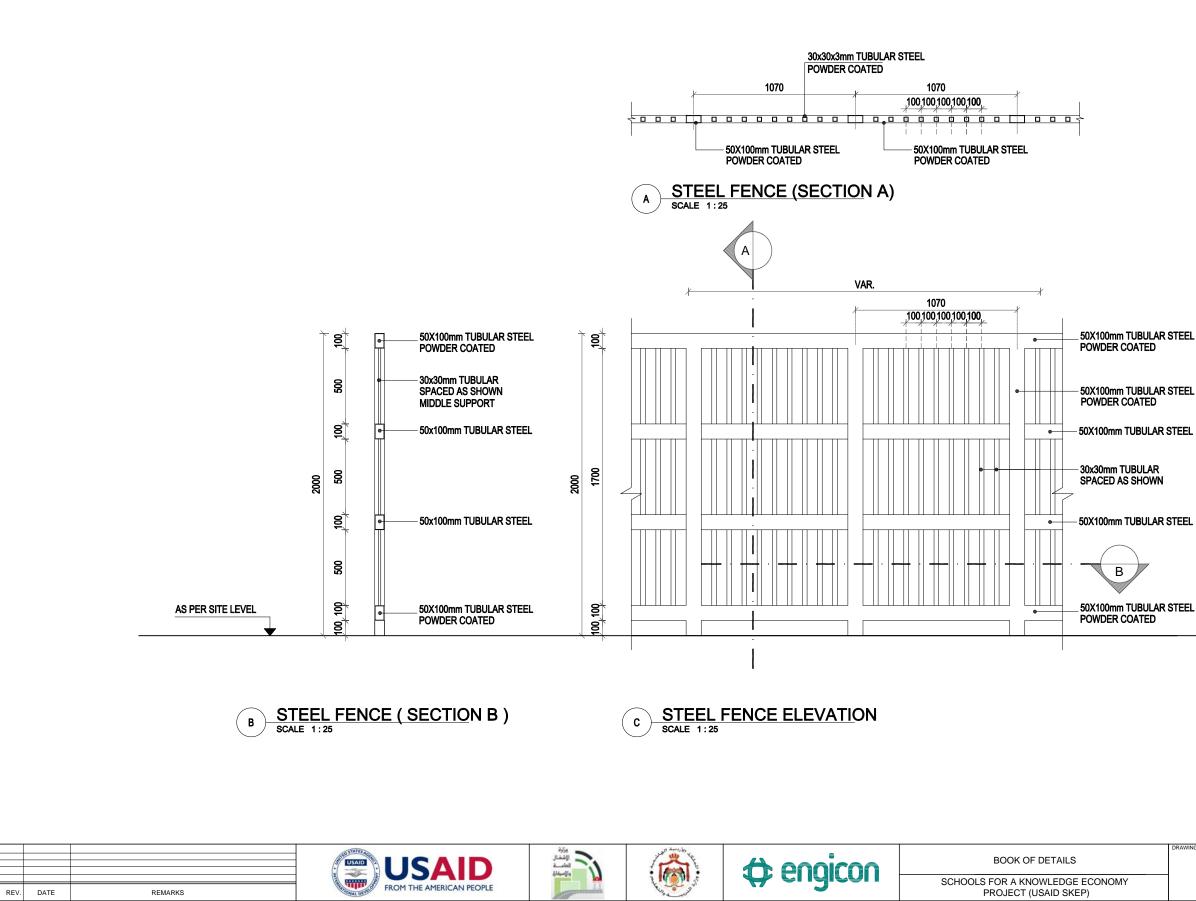

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DRAWING NAME:	Design:		REVISION No. :
	H.B.	Engicon	0
STEEL FENCE	Checked:	Approved:	SHEET NUMBER:
STELLTENCE	M.Sh.	S.B.	
	Date:	SCALE :	LSD-38
	June 2020	1:25	




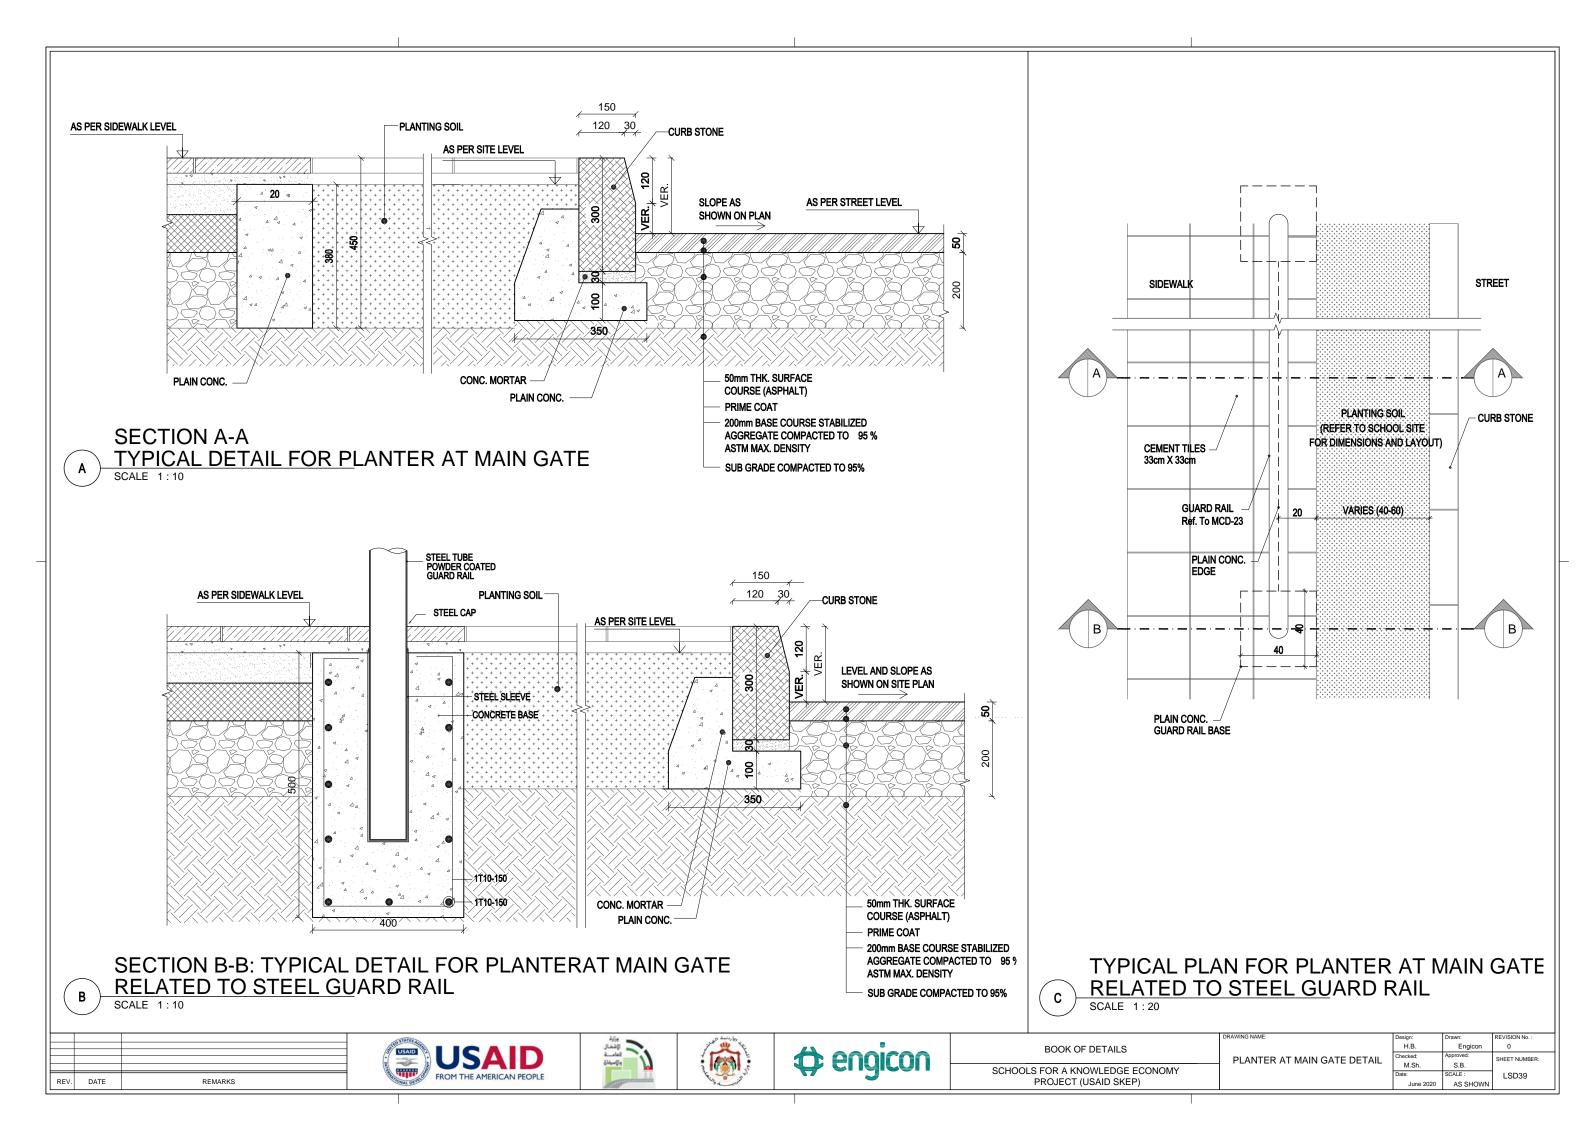

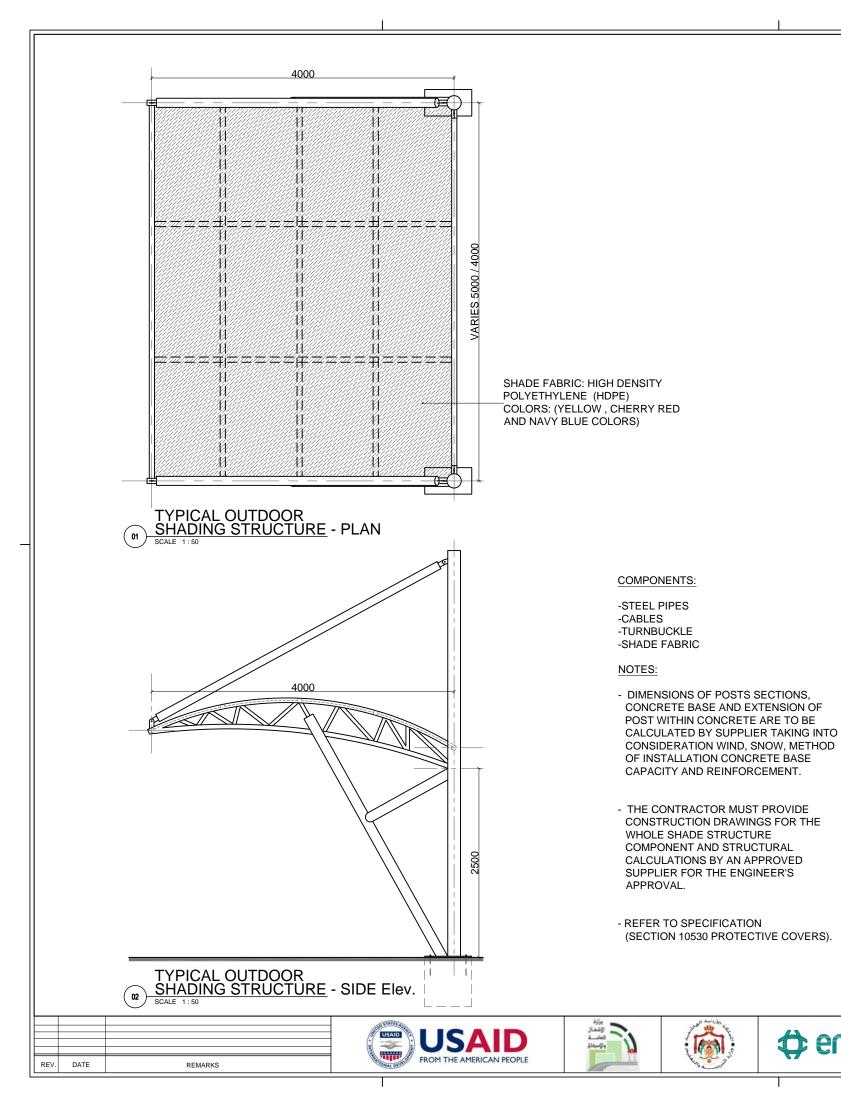

characteristics

DOORS DETAILS

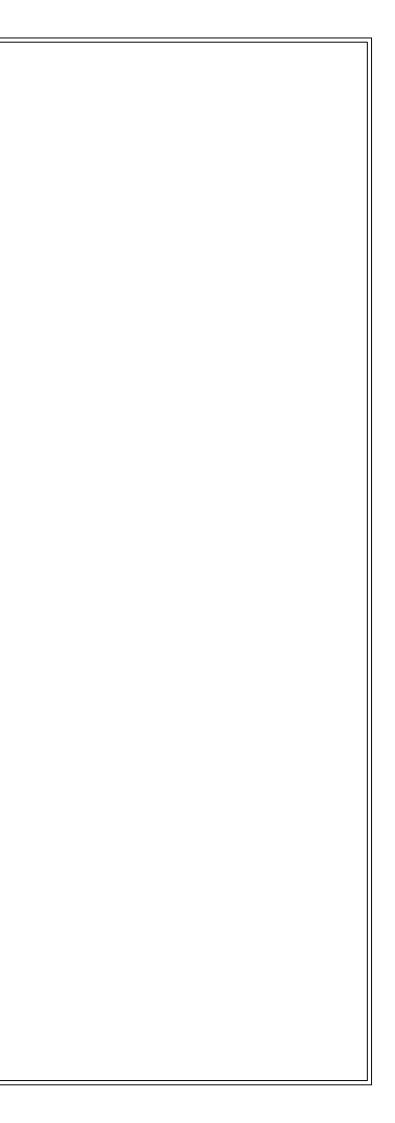

GENERAL NOTES

- 1- CONTRACTOR SHALL VERIFY ALL DIMENSIONS IN FIELD & SUBMIT SHOP DWGS. TO THE ENG. SHOWING ALL SUCH VERIFICATION FOR APPROVAL.
- 2- ALL HANDLES AND PLATES TO BE POLISHED CHROME OR STAINLESS STEEL SATIN FINISH ASSA ABLOY OR APPROVED EQUAL.
- 3- ALL IRONMONGARY AND HARDWARE OF WOODWORKS TO BE STAINLESS STEEL FINISH & OF HIGH QUALITY
- 4- DOORS:
- THE DIMENSIONS SHOWING THE HEIGHT OF THE DOOR IS TAKEN FROM FINISHED FLOOR LEVEL TO THE TOP OF FRAME AT HEAD.
- DIMENSIONS OF WORKING DWGS INDICATE DIMENSIONS OF MASONARY OPENINGS

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	REV.	DATE	REMARKS









BOOK OF DETAILS

SCHOOLS FOR A KNOWLEDGE ECONOMY PROJECT (USAID SKEP)


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DOORS DETAILS NOTES	Checked:	Approved:	SHEET NUMBER:
	Date:	SCALE :	DRD-01
	June 2020	AS SHOWN	

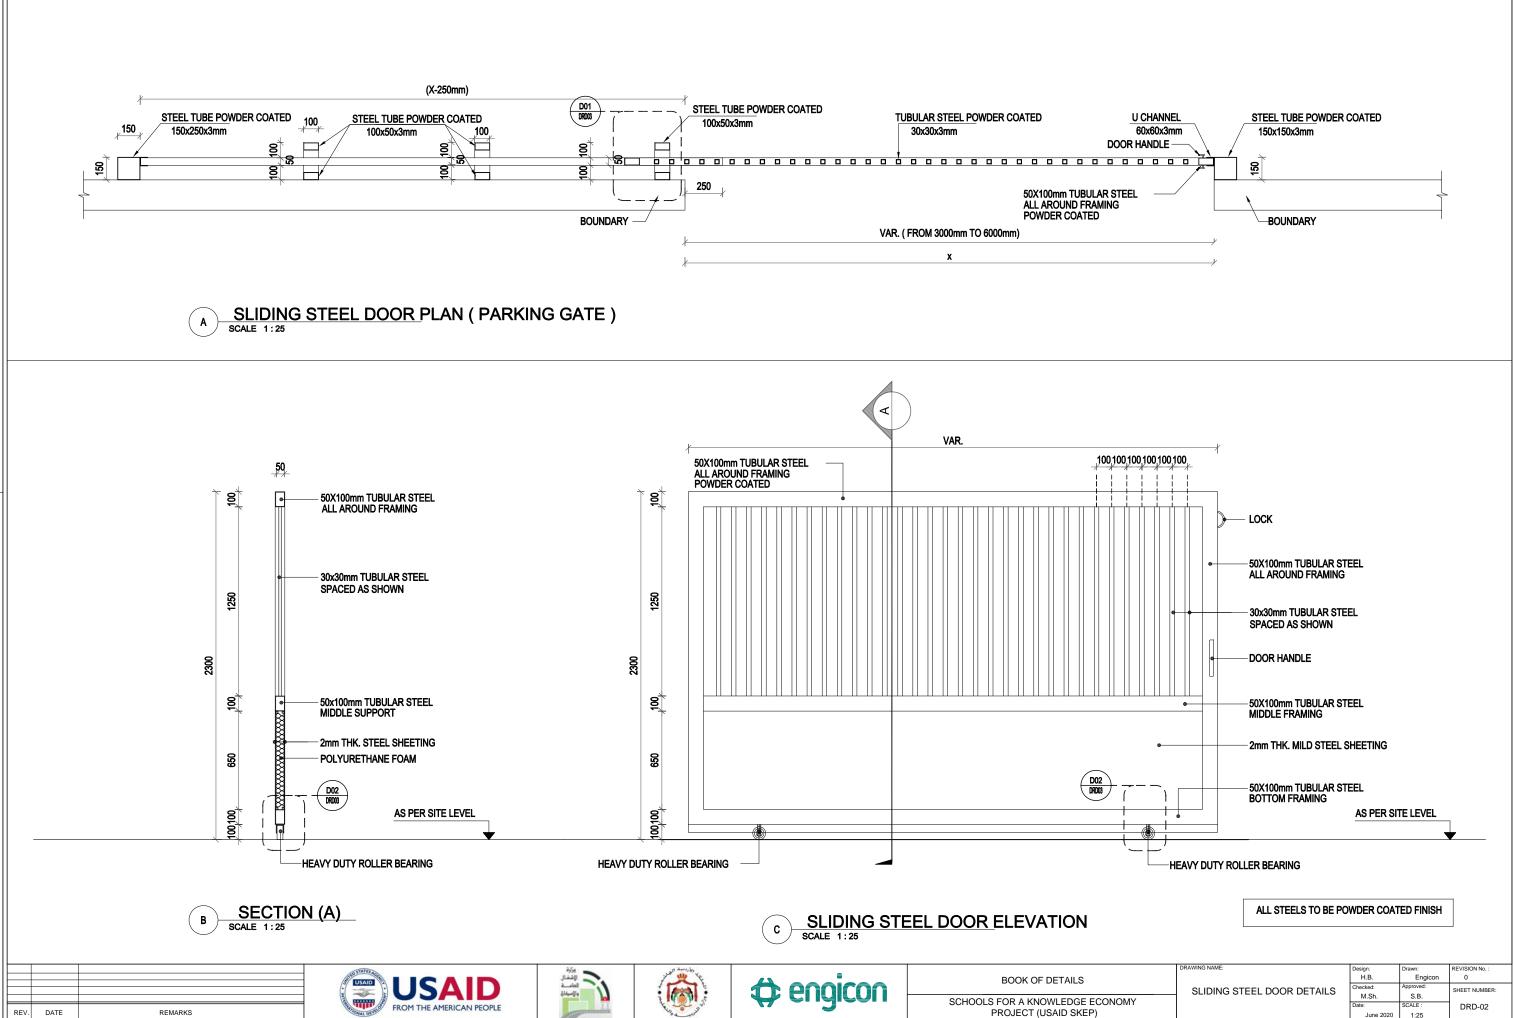



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		H.B.	Engicon	0
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		M.Sh.	S.B.	GHEET HOMBER.
		Date:	SCALE :	DRD-02
		June 2020	1:25	

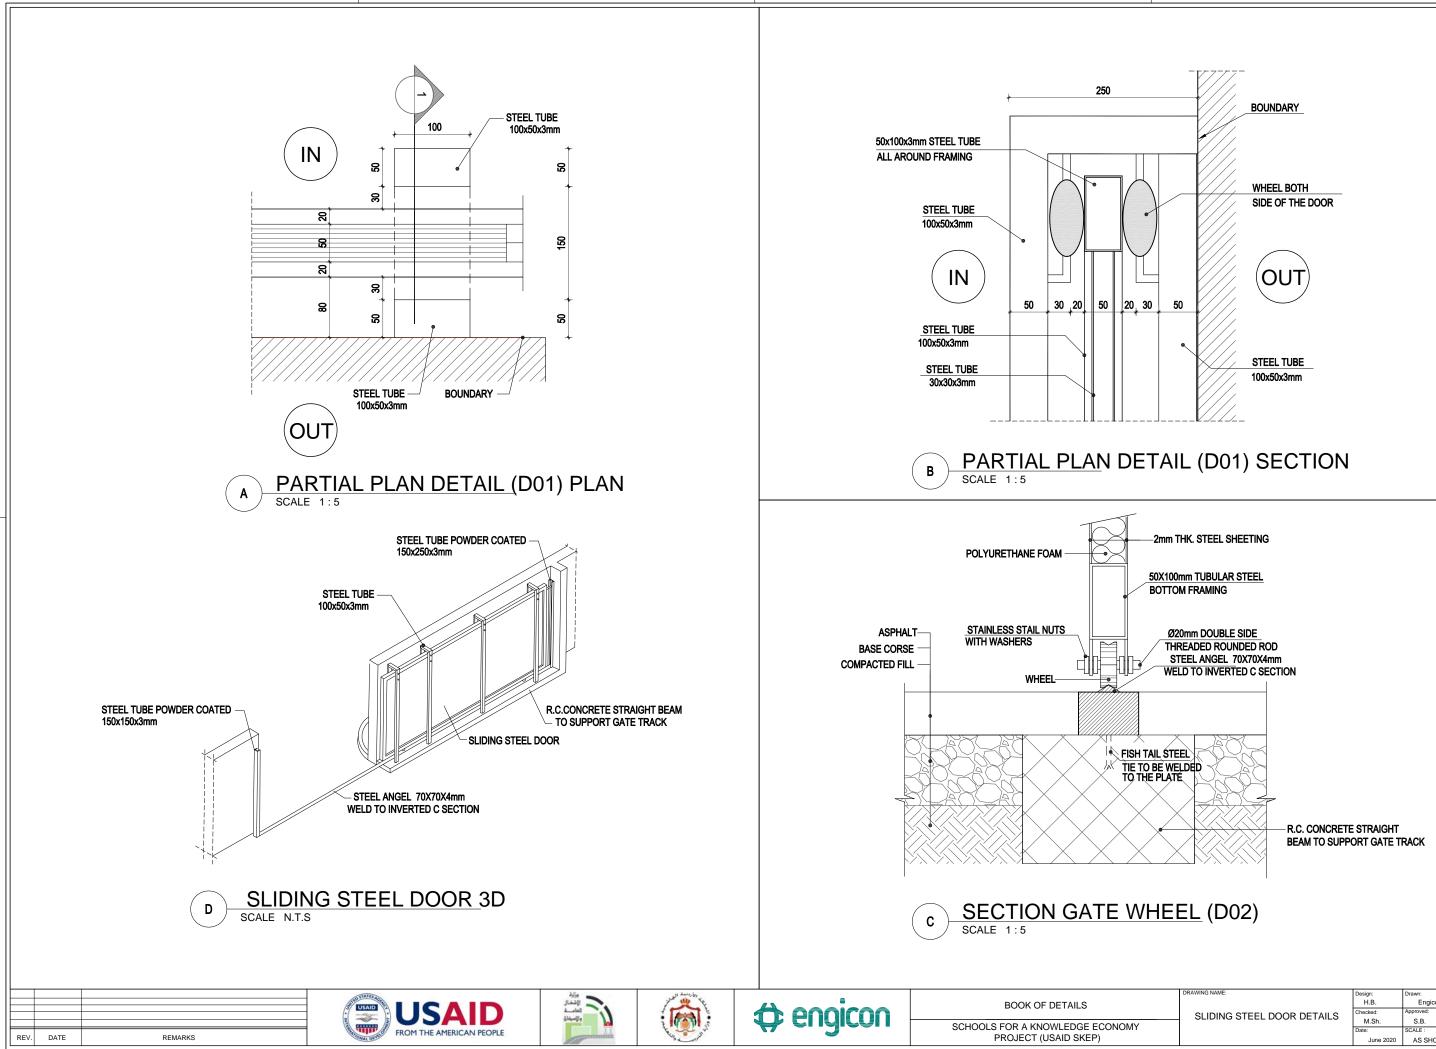


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	SLIDING STEEL DOOR DETAILS	Checked:	Approved:	SHEET NUMBER:
		M.Sh.	S.B.	SHEET NOMBER.
		Date:	SCALE :	DRD-03
		June 2020	AS SHOWN	~~~~

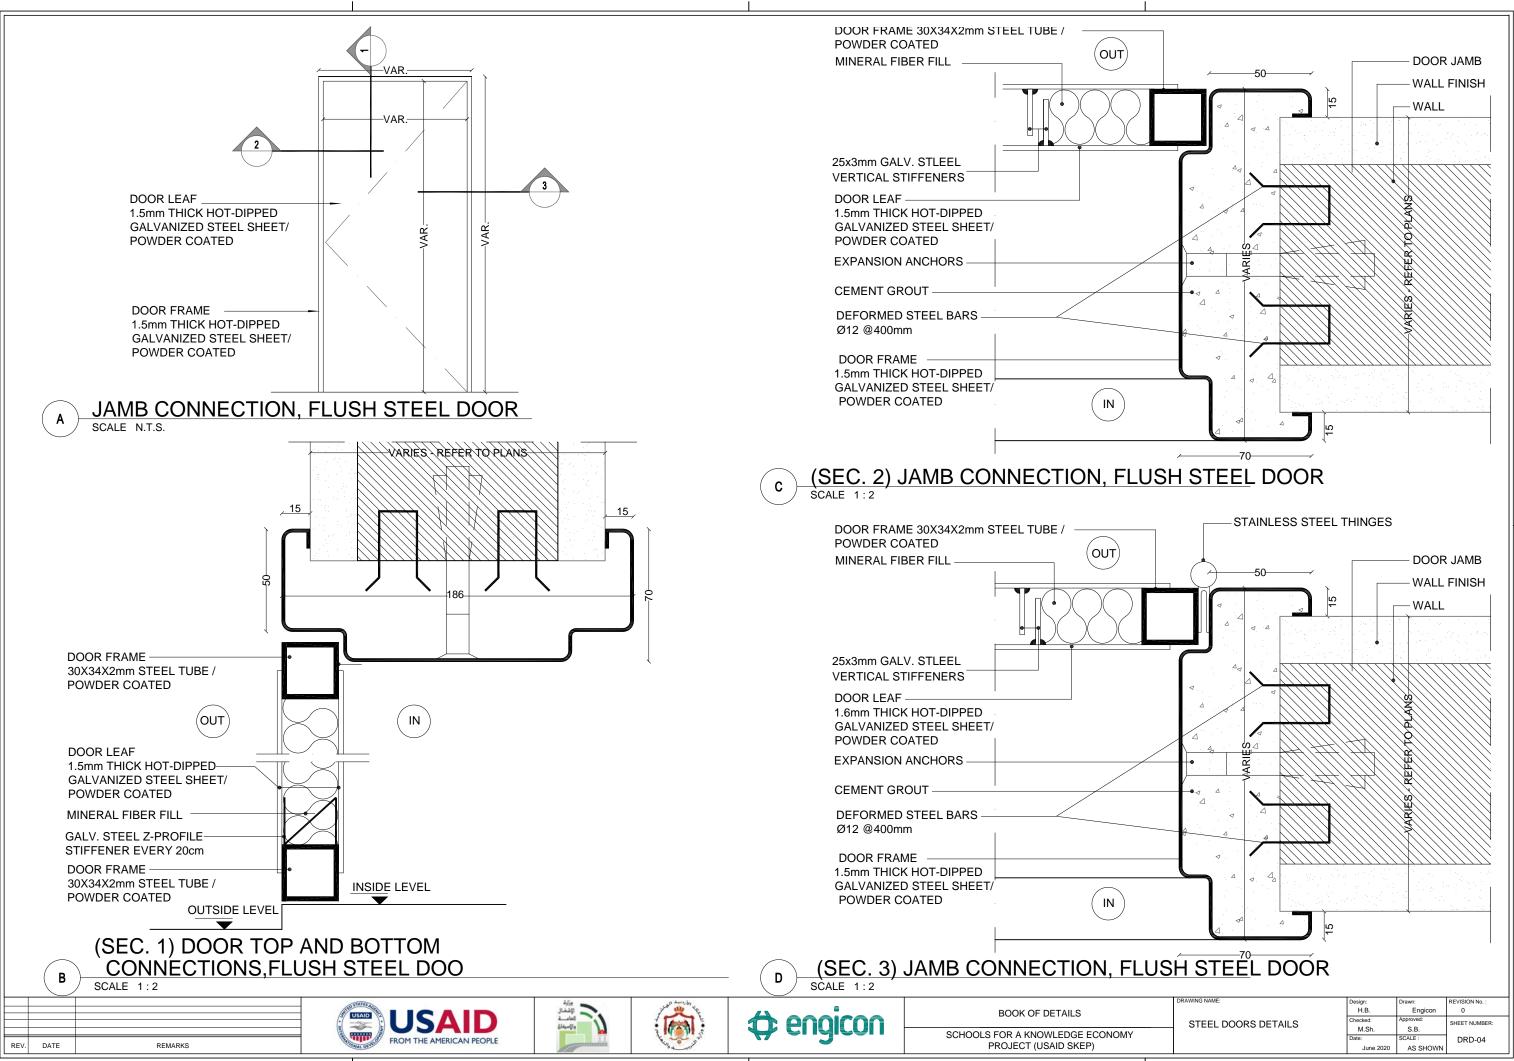


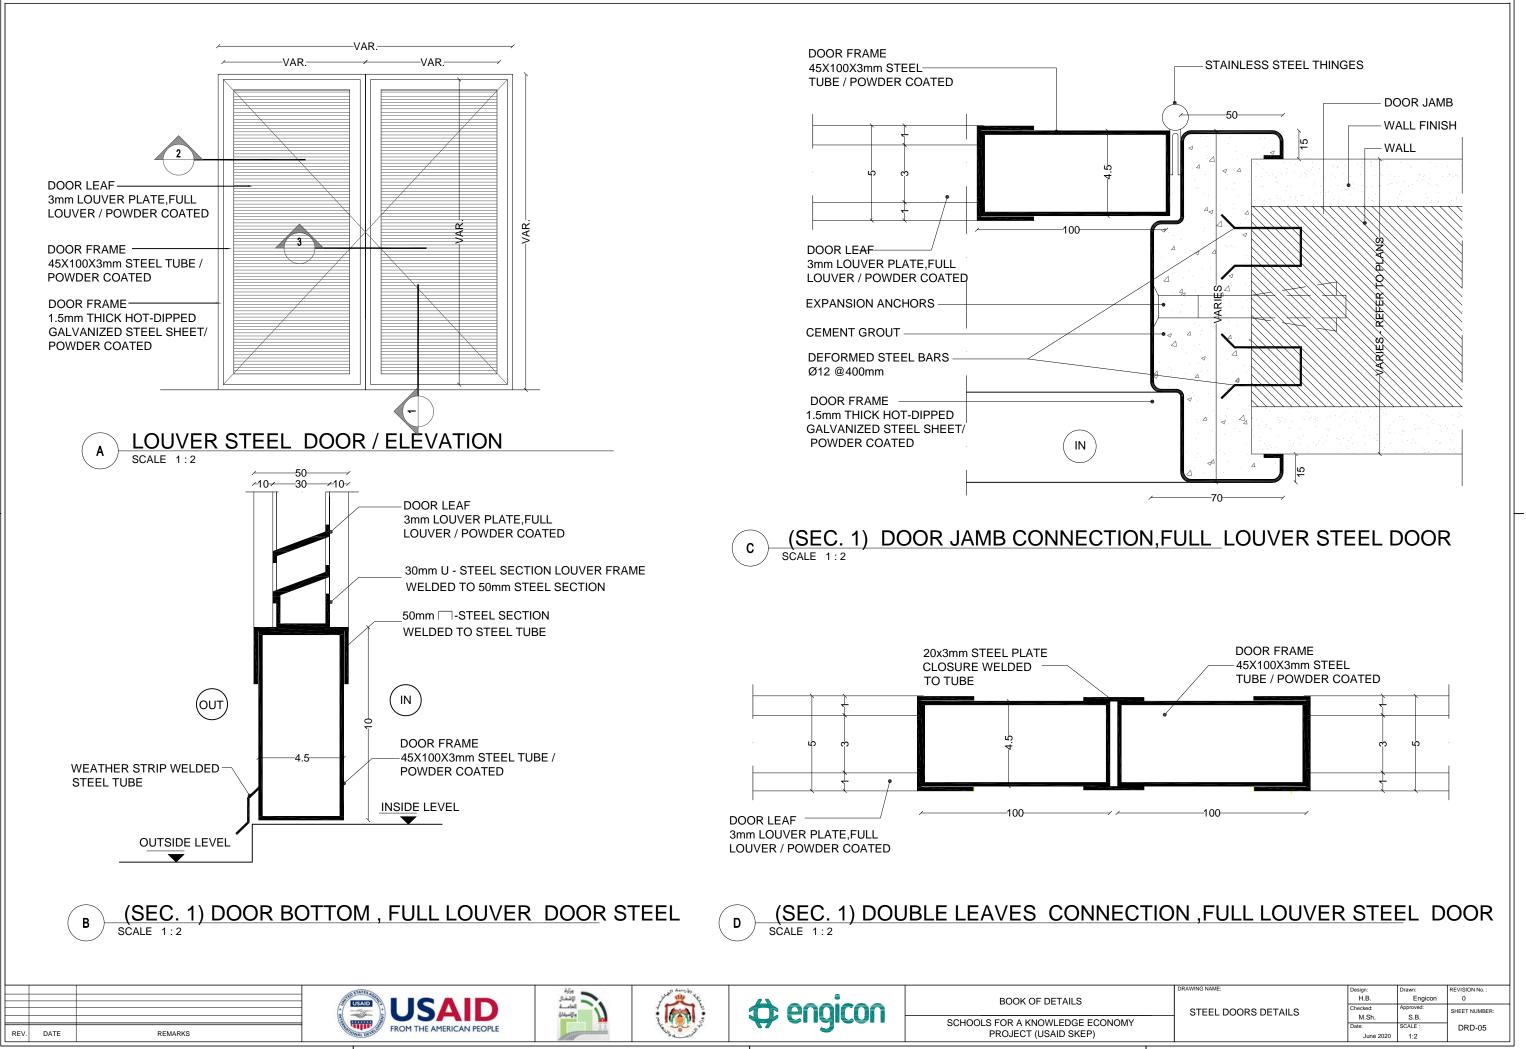

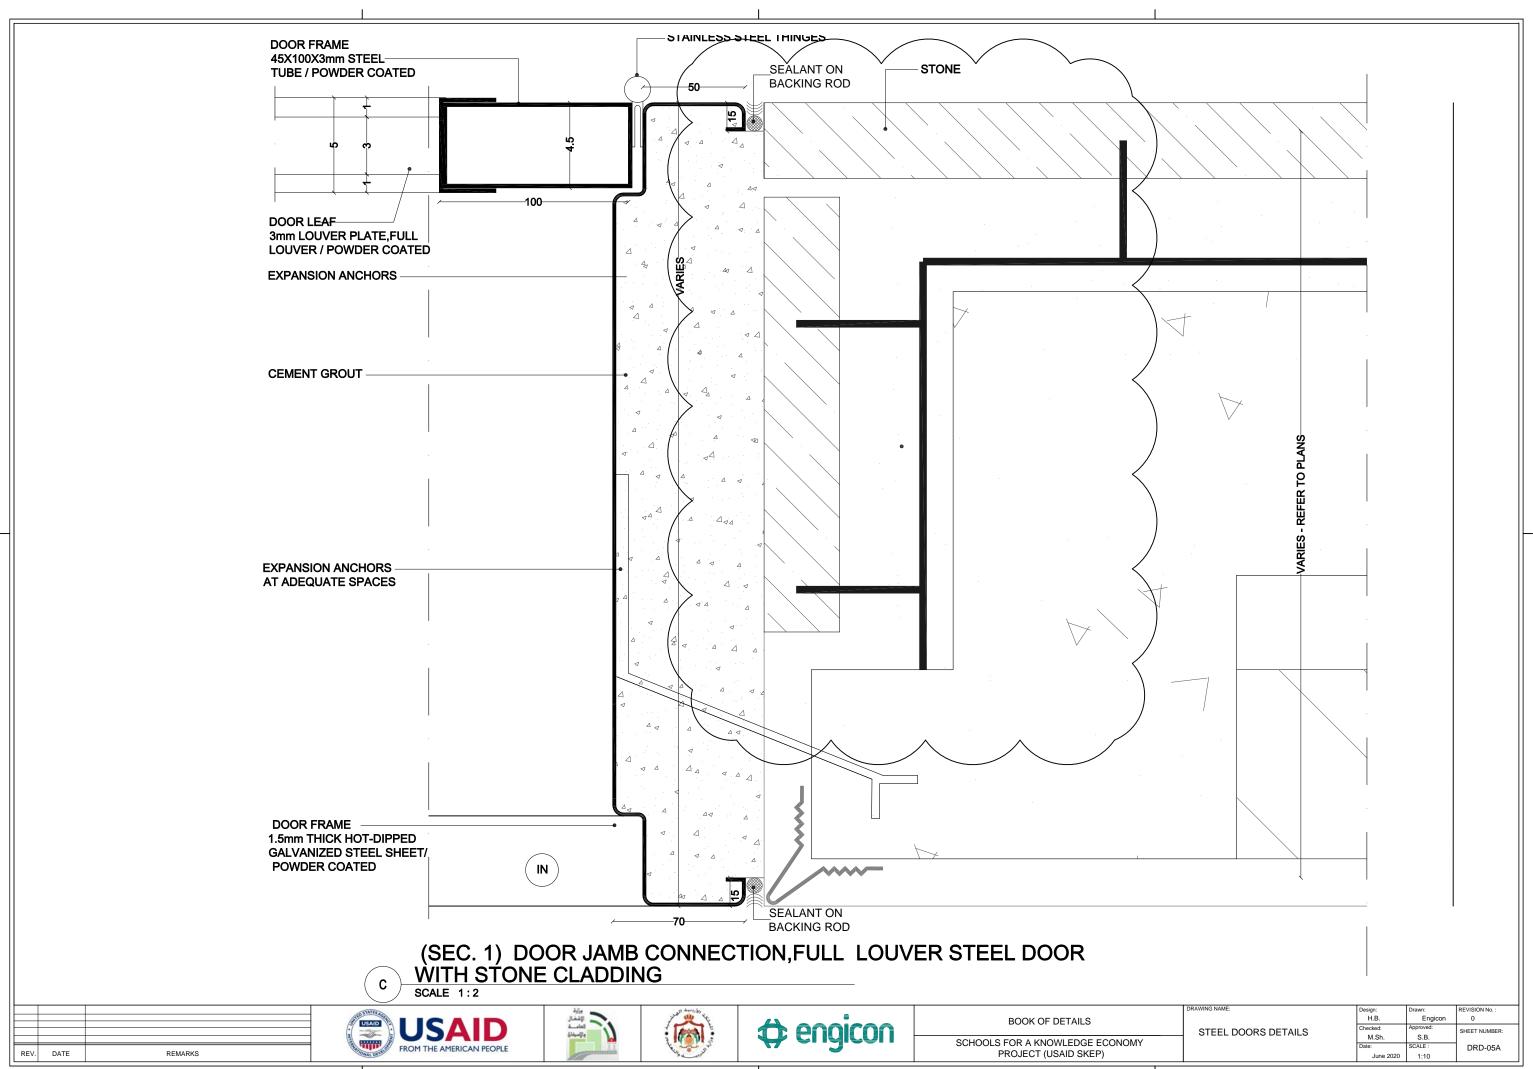

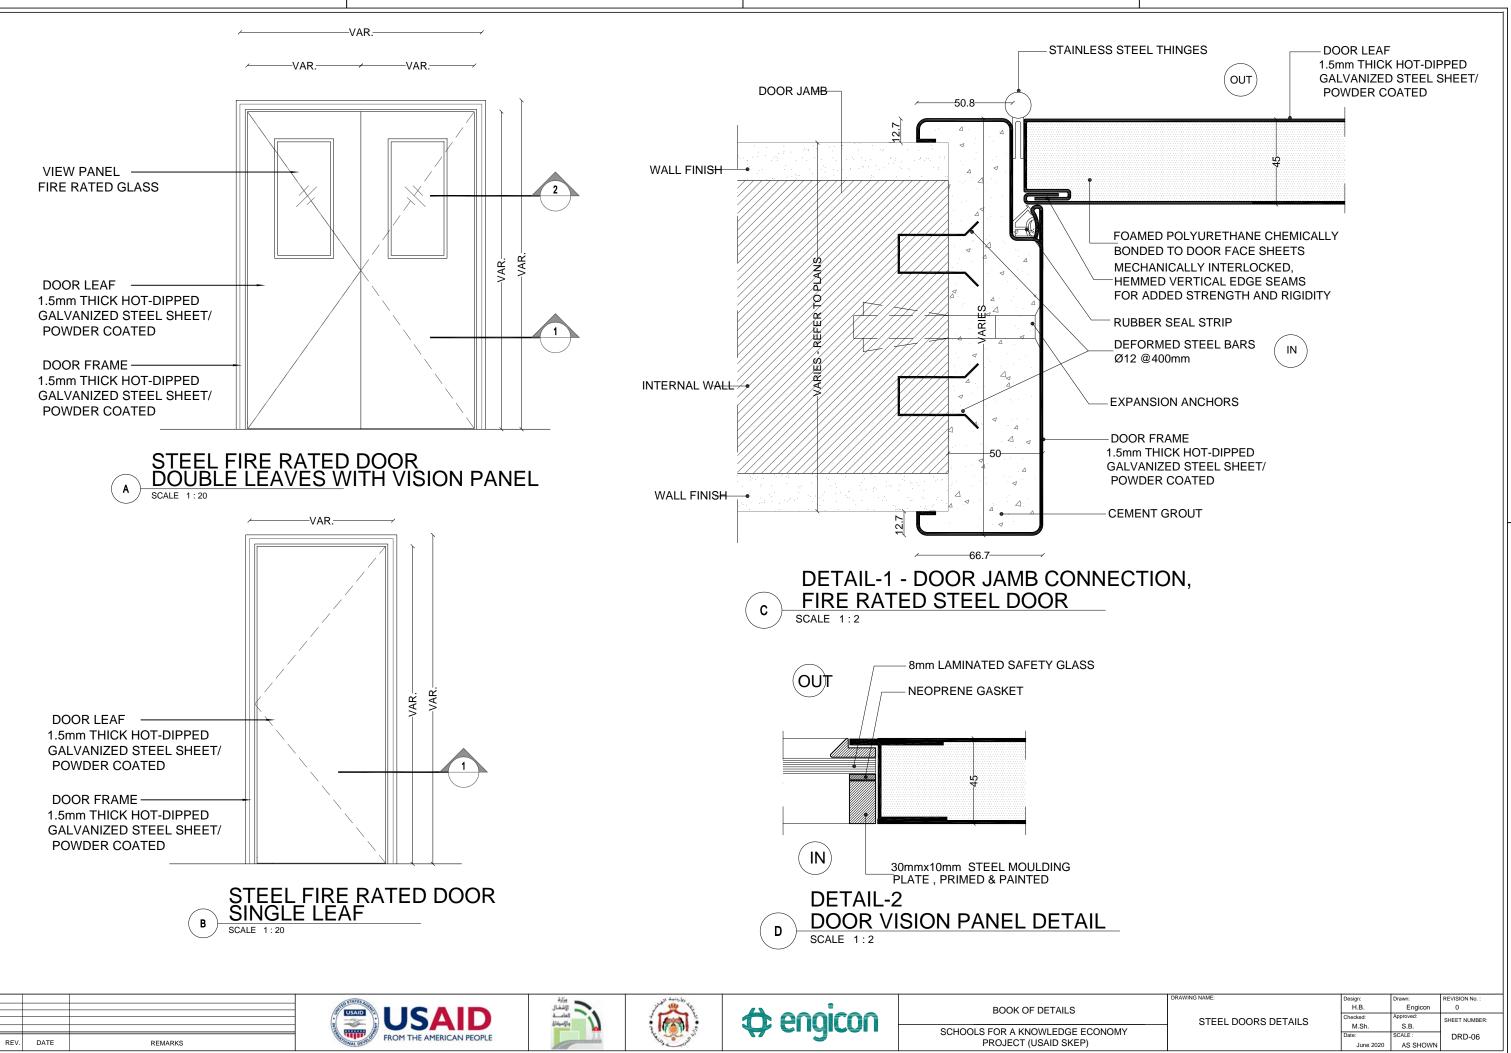

	DRAWING NAME:	Design:	Drawn:	REVISION No. :
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		M.Sh.	S.B.	ONEET HOMBER.
		Date:	SCALE :	DRD-06
		June 2020	AS SHOWN	

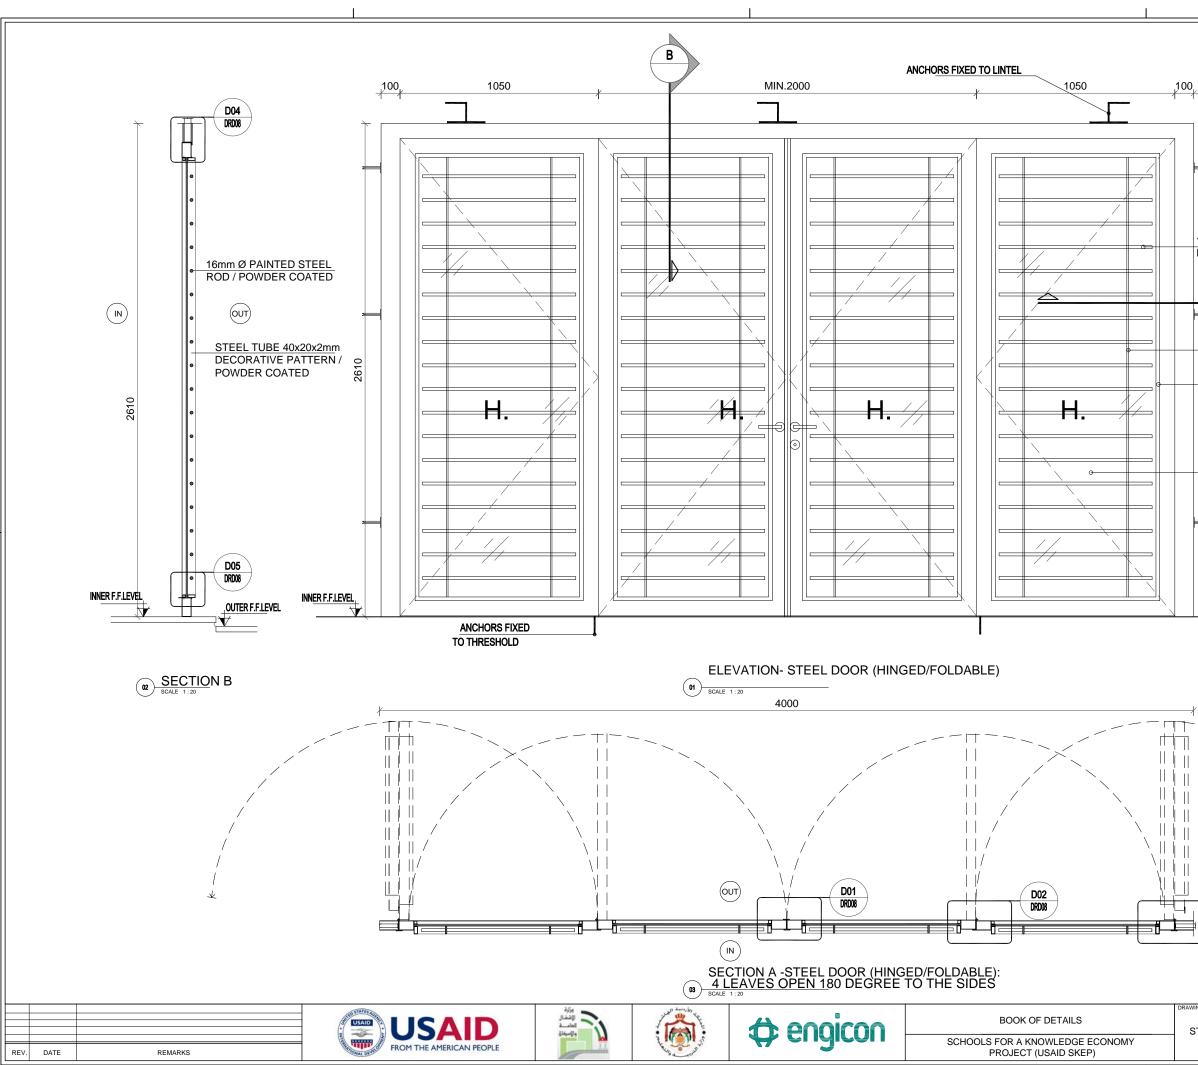


D03


DRD08


100	<u>k</u>
	16mm Ø PAINTED STEEL ROD / POWDER COATED 400mm wide x 8mm THICK STEEL PLATE / POWDER COATED 200mm x 400mm STEEL TUBE / POWDER COATED WELDED TO 1000mm x 350mm STEEL TUBE/FRAME
	<u>10mm TEMP</u> ERED GLASS


	DRAWING NAME:	Design:	Drawn:	REVISION No. :
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STEEL DOORS DETAILS		Checked:	Approved:	SHEET NUMBER:
	STELE DOORS DETAILS	M.Sh.	S.B.	
		Date:	SCALE :	DRD-07
		June 2020	1:20	

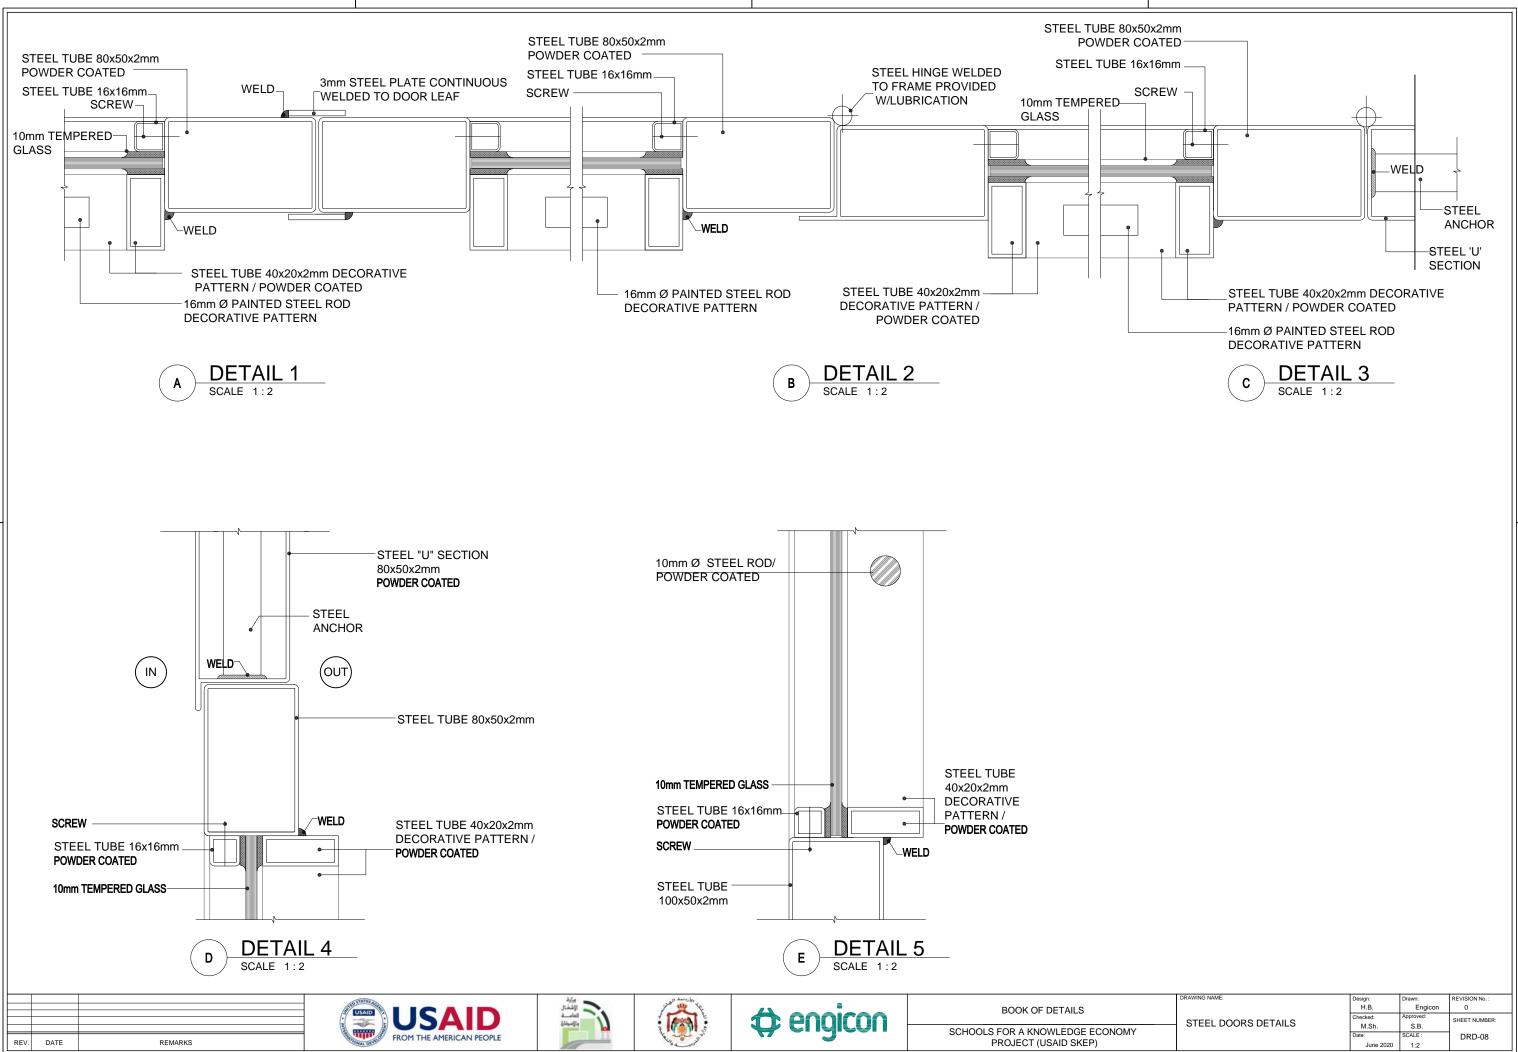


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		Date:	SCALE :	DRD-08
		June 2020	1:2	

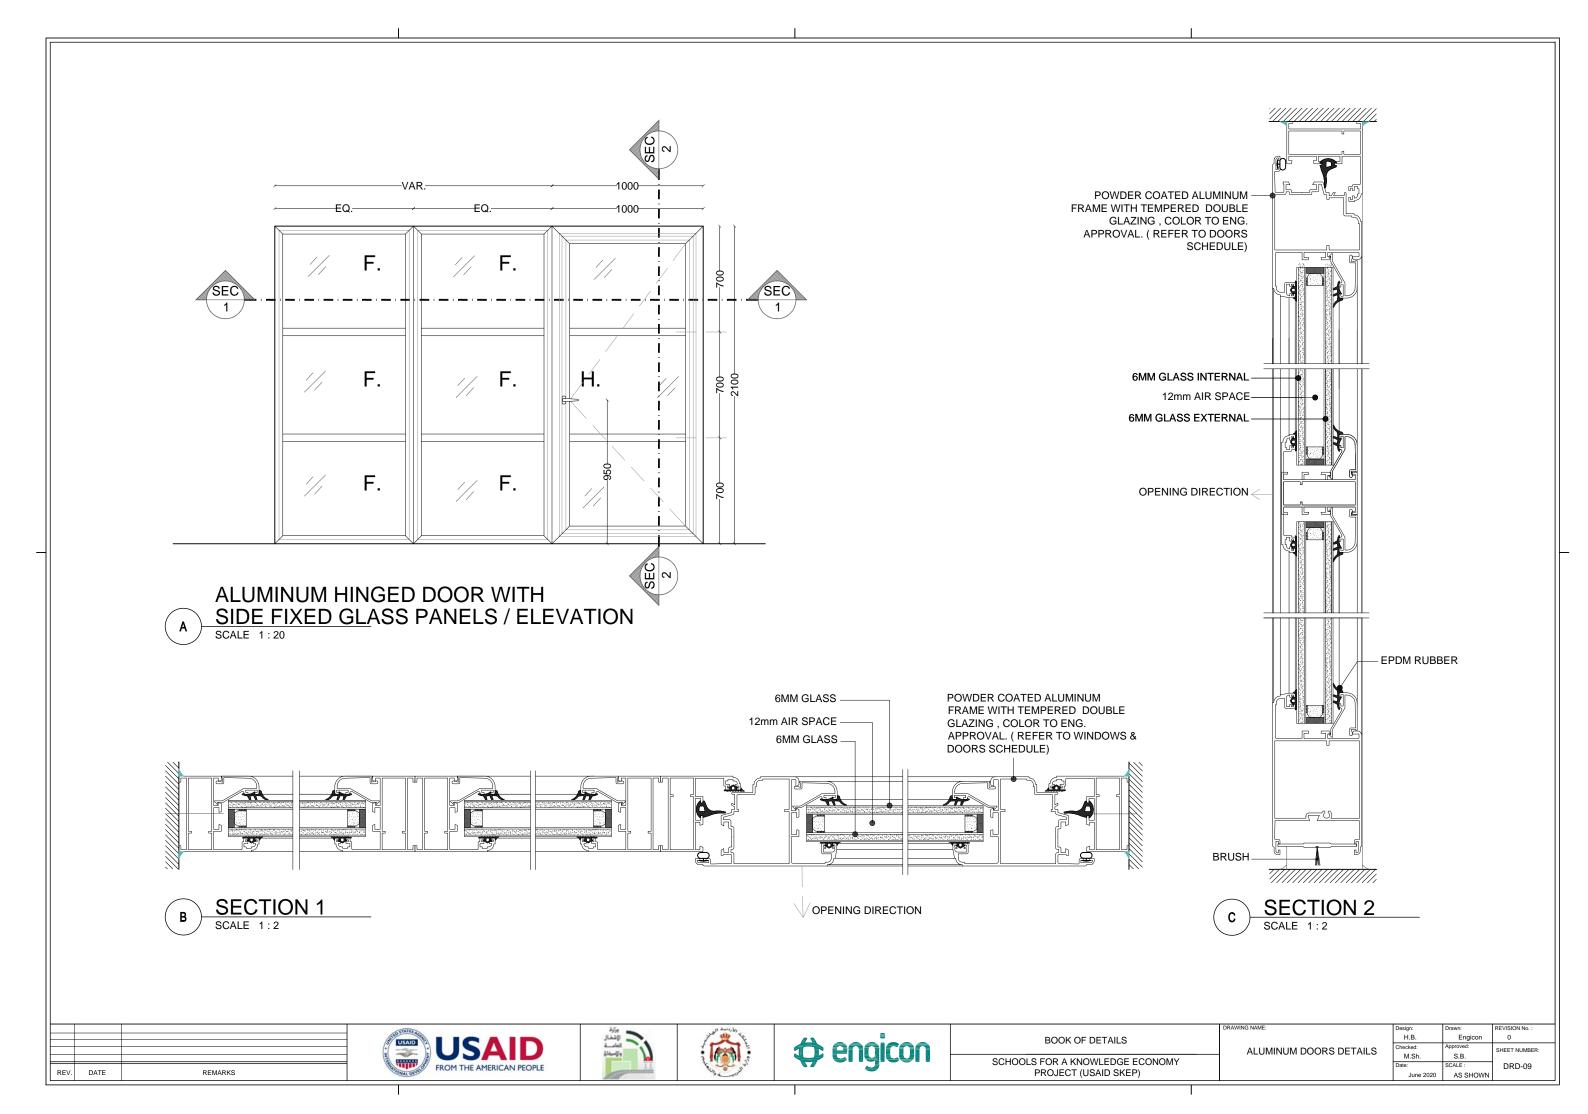

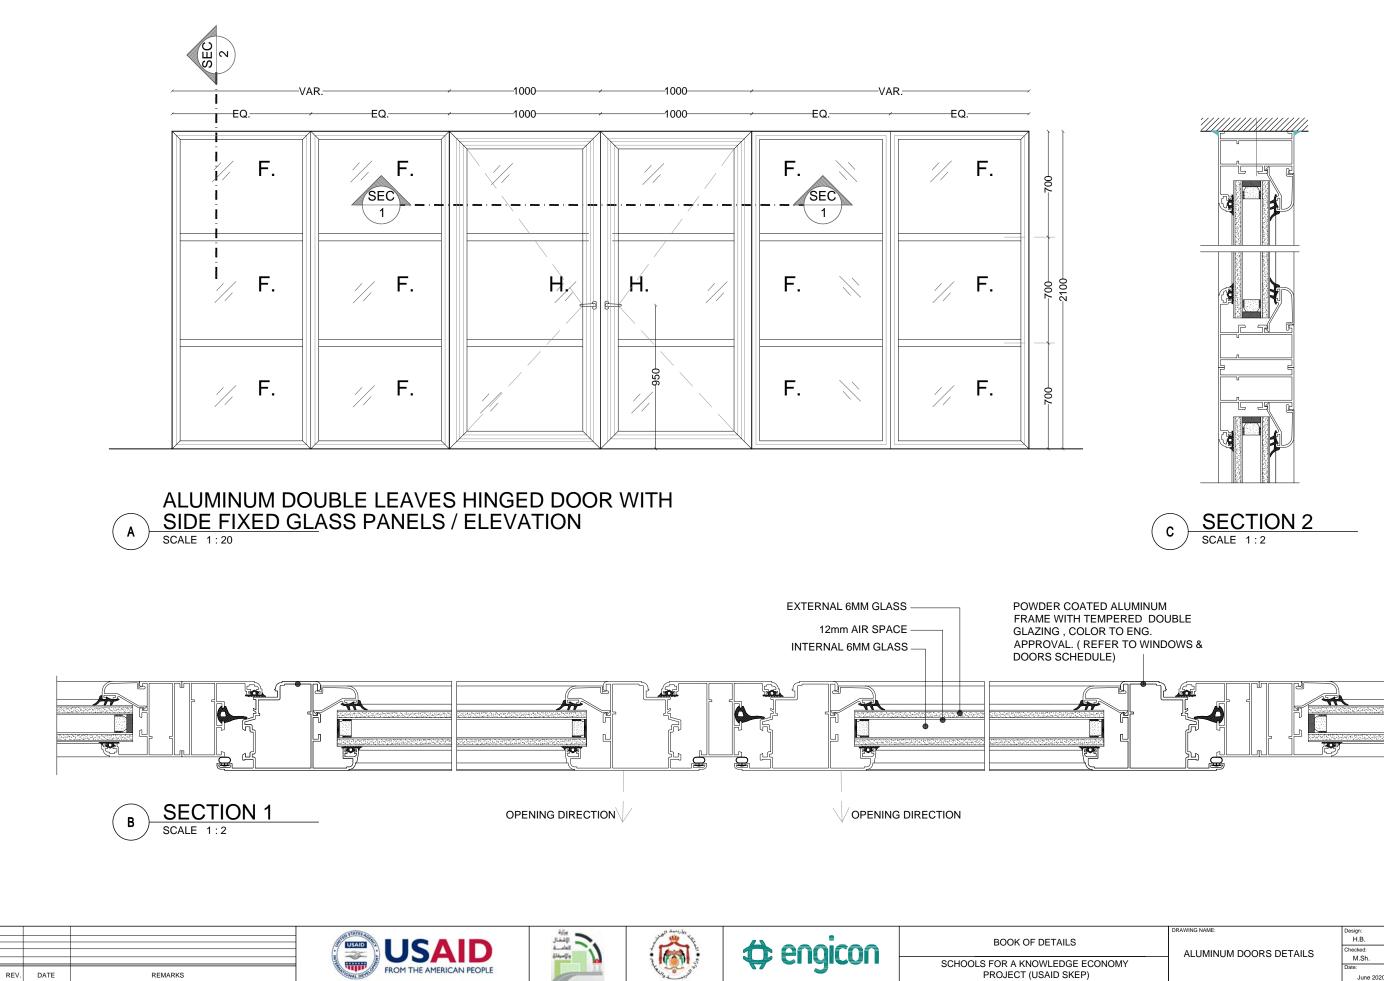


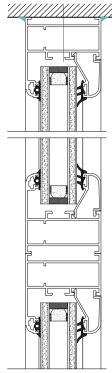


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	DRAWING NAME:	Design:	Drawn:	REVISION No. :	L
	H.B.	Engicon	0	l	
	ALUMINUM DOORS DETAILS	Checked:	Approved:	SHEET NUMBER:	L
		M.Sh.	S.B.	CHEET HOMBER	L
		Date:	SCALE :	DRD-10	L
		June 2020	AS SHOWN		

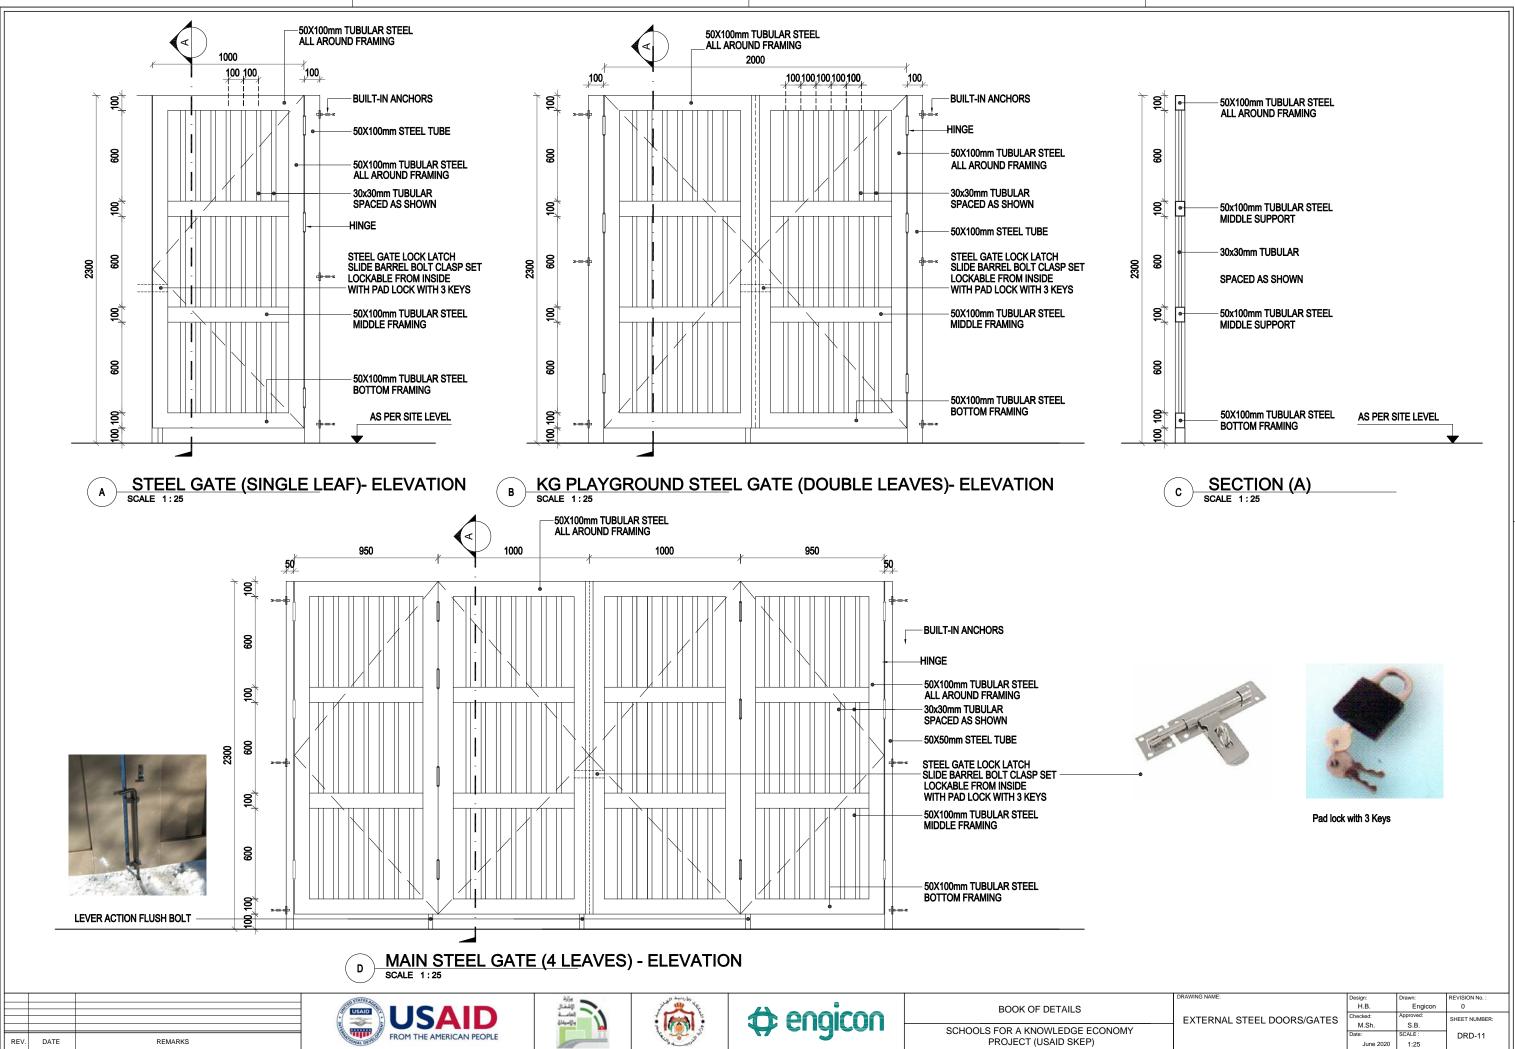


	H.B.	Engicon	0
EXTERNAL STEEL DOORS/GATES	Checked:	Approved:	SHEET NUMBER:
EXTERINAL STEEL DOORS/GATES	M.Sh.	S.B.	oneen nombert.
	Date:	SCALE :	DRD-11
	June 2020	1.25	

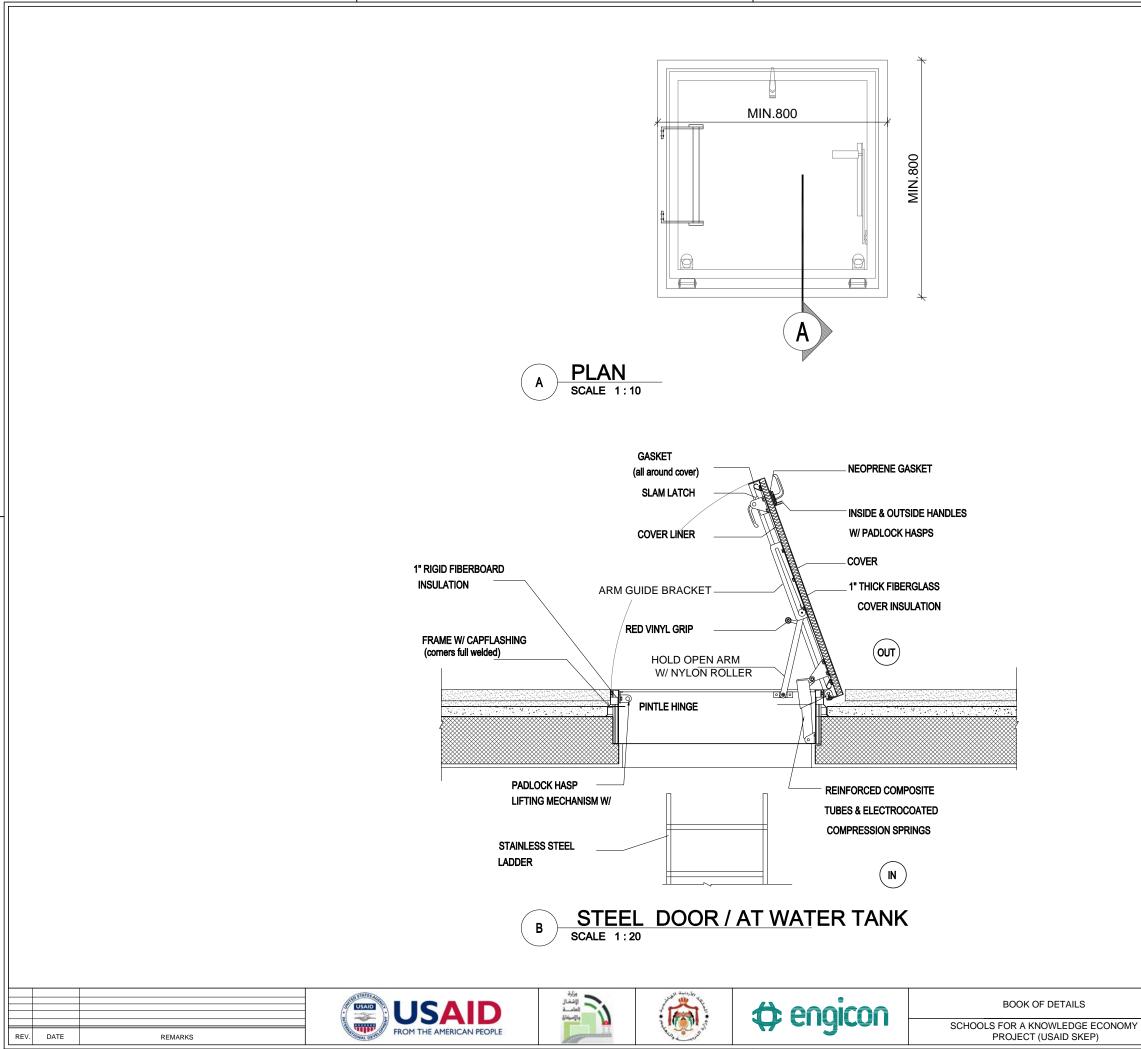


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	H.B.	Engicon	0
STEEL DOOR AT WATER TANK	Checked:	Approved:	SHEET NUMBER:
STEEL DOOR AT WATER TANK	M.Sh.	S.B.	
	Date:	SCALE :	DRD-12
	June 2020	AS SHOWN	

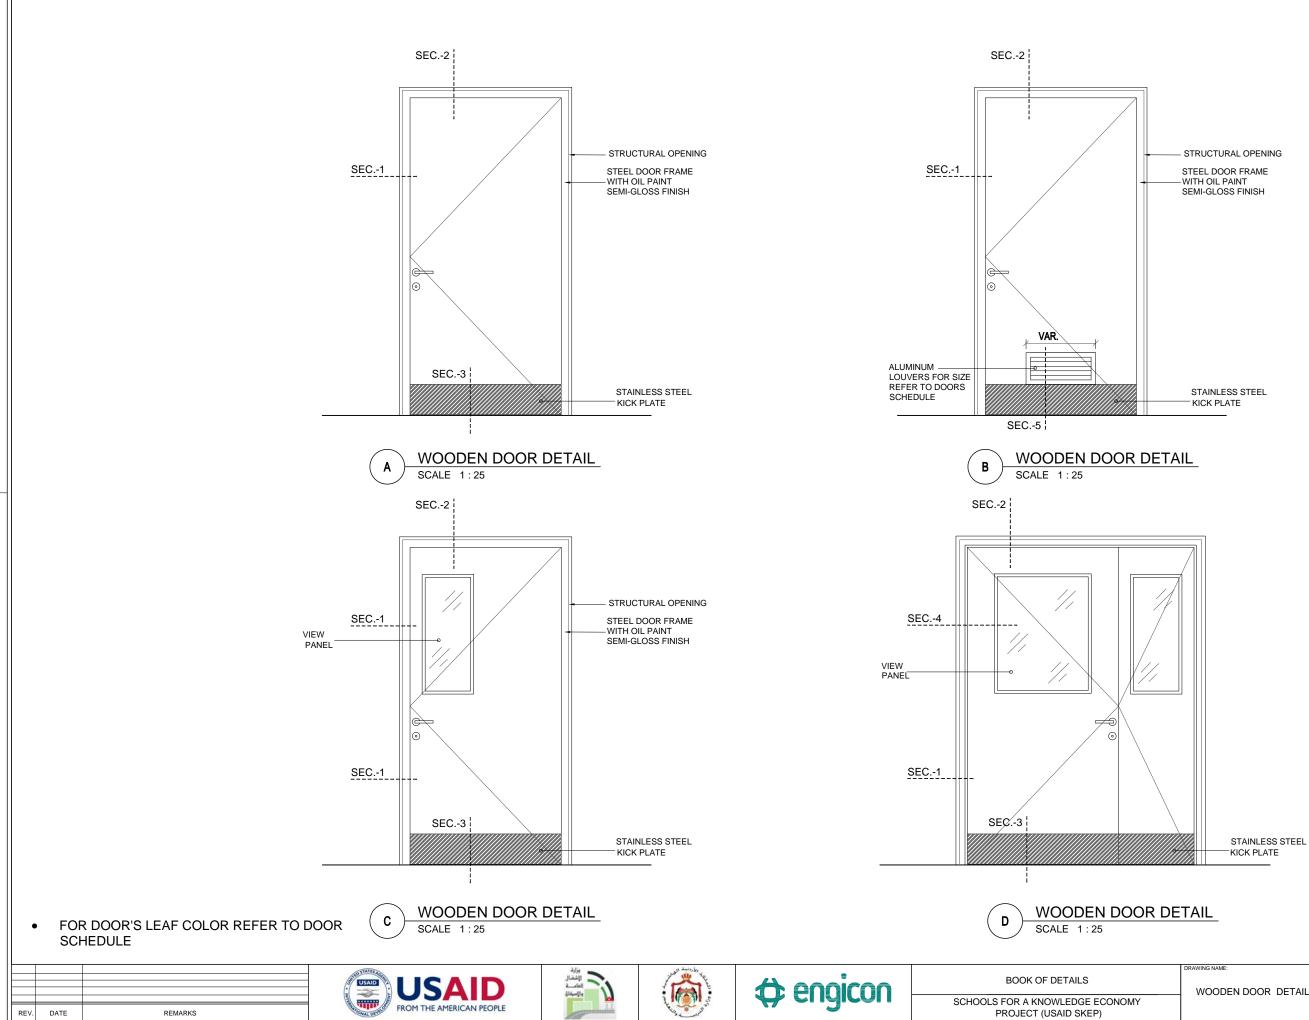

DRAWING NAME:	Design:	Drawn:	REVISION No. :
	H.B.	Engicon	0
WOODEN DOOR DETAIL	Checked:	Approved:	SHEET NUMBER:
 WOODEN DOOR DETAIL	M.Sh.	S.B.	-
	Date:	SCALE :	DRD-13
	June 2020	ASSHOWN	

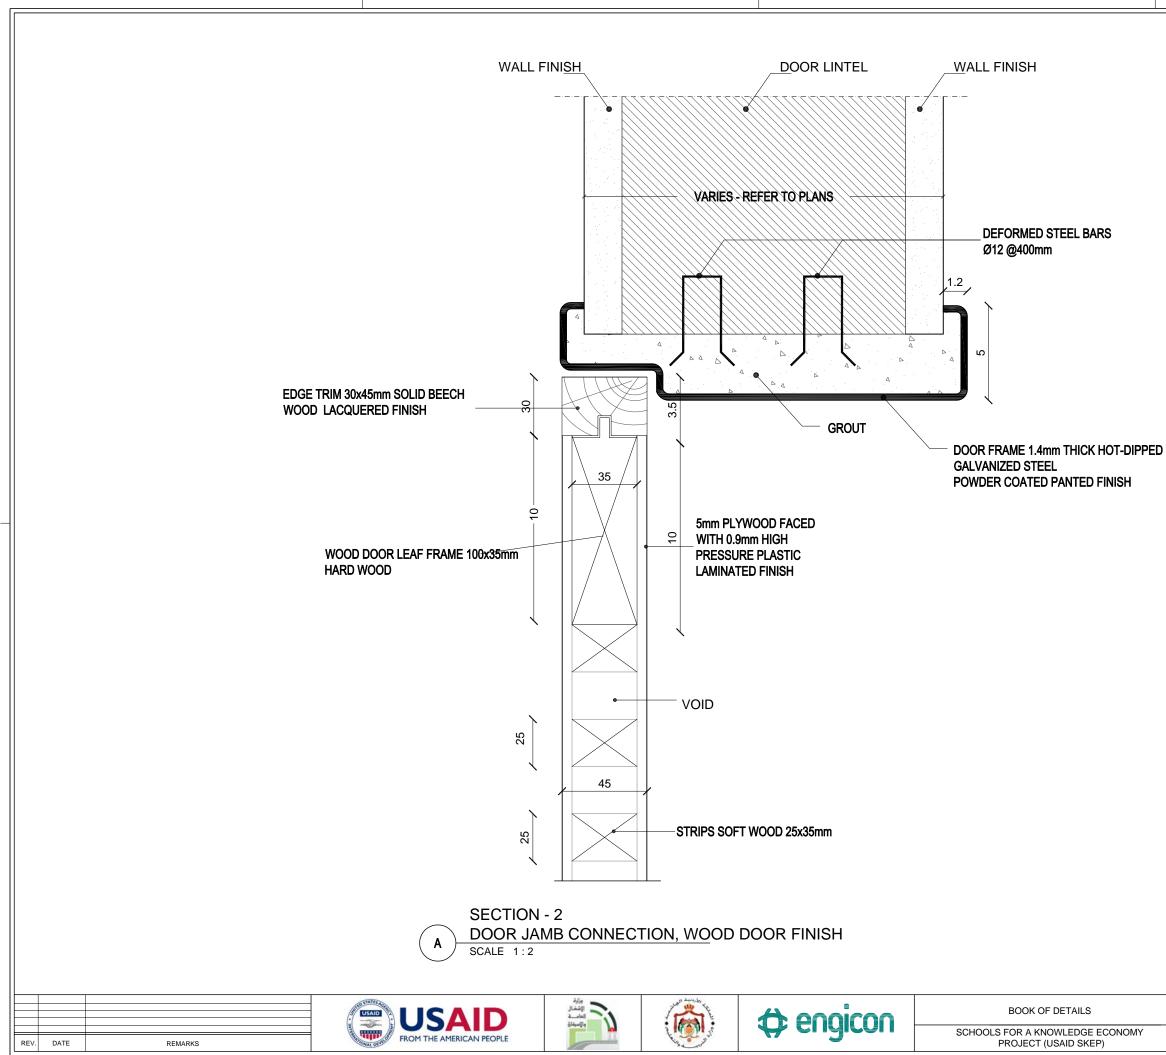

DRAWING NAME:	Design:	Drawn:	REVISION No. :		
	H.B.	Engicon	0		
WOODEN DOOR DETAIL	Checked:	Approved:	SHEET NUMBER:		
WOODEN DOOR DETAIL	M.Sh.	S.B.			
	Date:	SCALE :	DRD-14		
	June 2020	AS SHOWN			

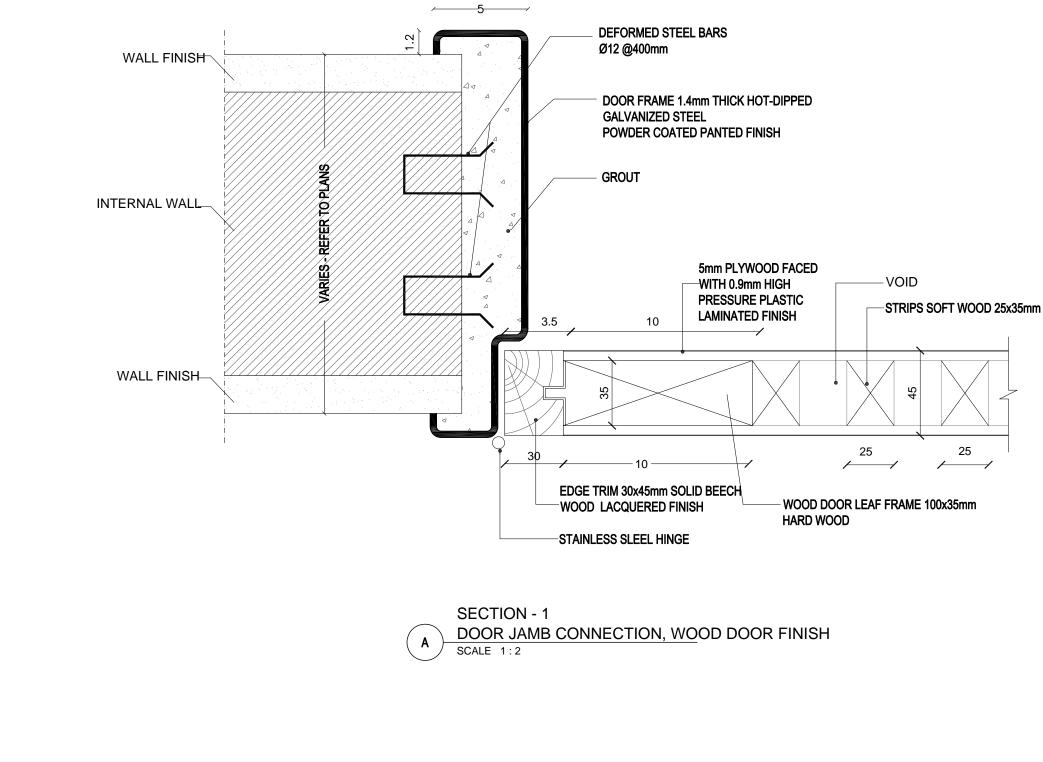

characteristics

الأشغال الأشغال والإسطارة

FROM THE AMERICAN PEOPLE


FROM THE AMERICAN PEOPLE

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	REV.	DATE	REMARKS


BOOK OF DETAILS

SCHOOLS FOR A KNOWLEDGE ECONOMY PROJECT (USAID SKEP)


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	Date:	SCALE :	DRD-15
	June 2020	AS SHOWN	

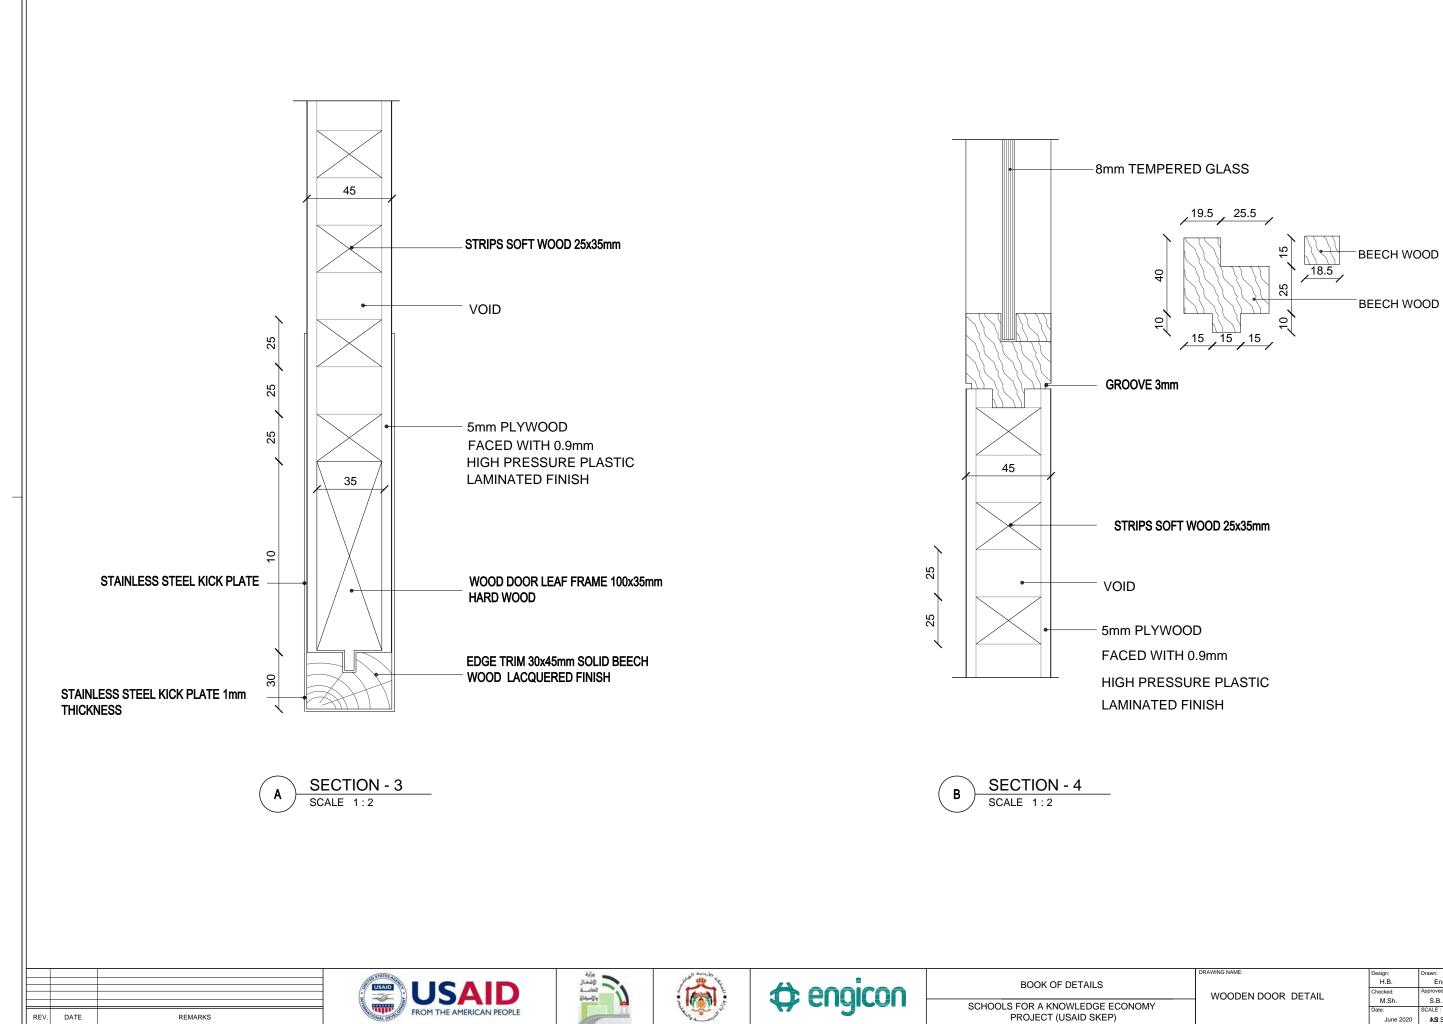


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WOODEN DOOR DETAIL	M.Sh.	S.B.	
	Date:	SCALE :	DRD-16
	June 2020	AS SHOWN	

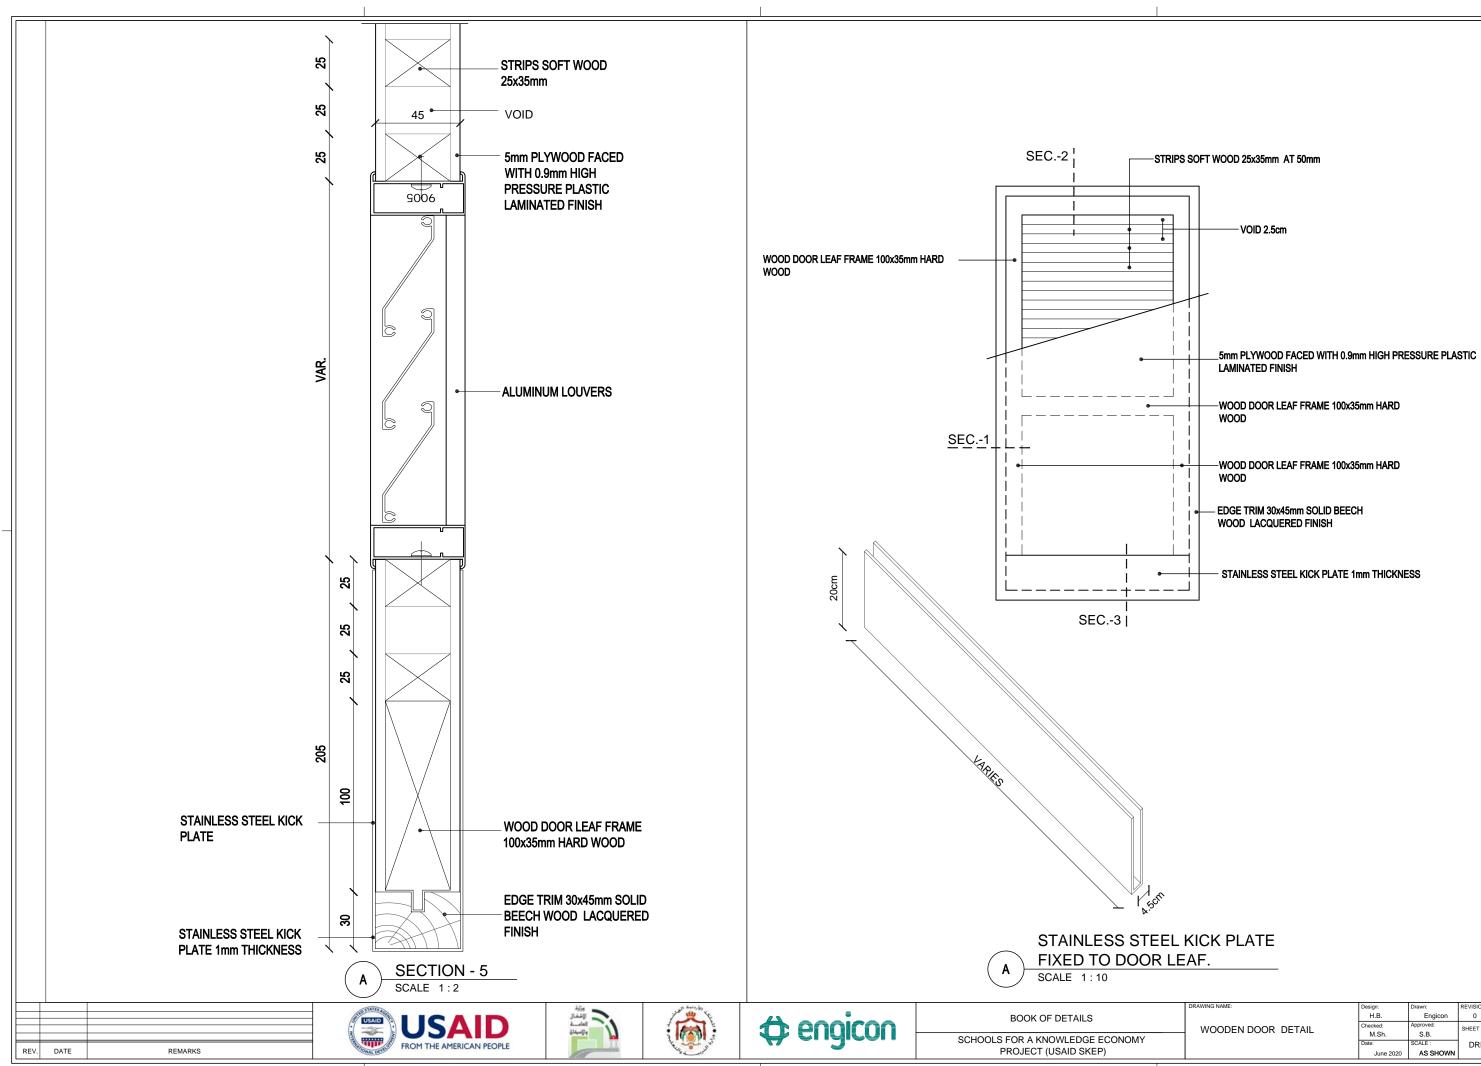


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WOODEN DOOR DETAIL	Checked:	Approved:	SHEET NUMBER:
WOODEN DOOR DETAIL	M.Sh.	S.B.	
	Date:	SCALE :	DRD-17
	June 2020	AS SHOWN	

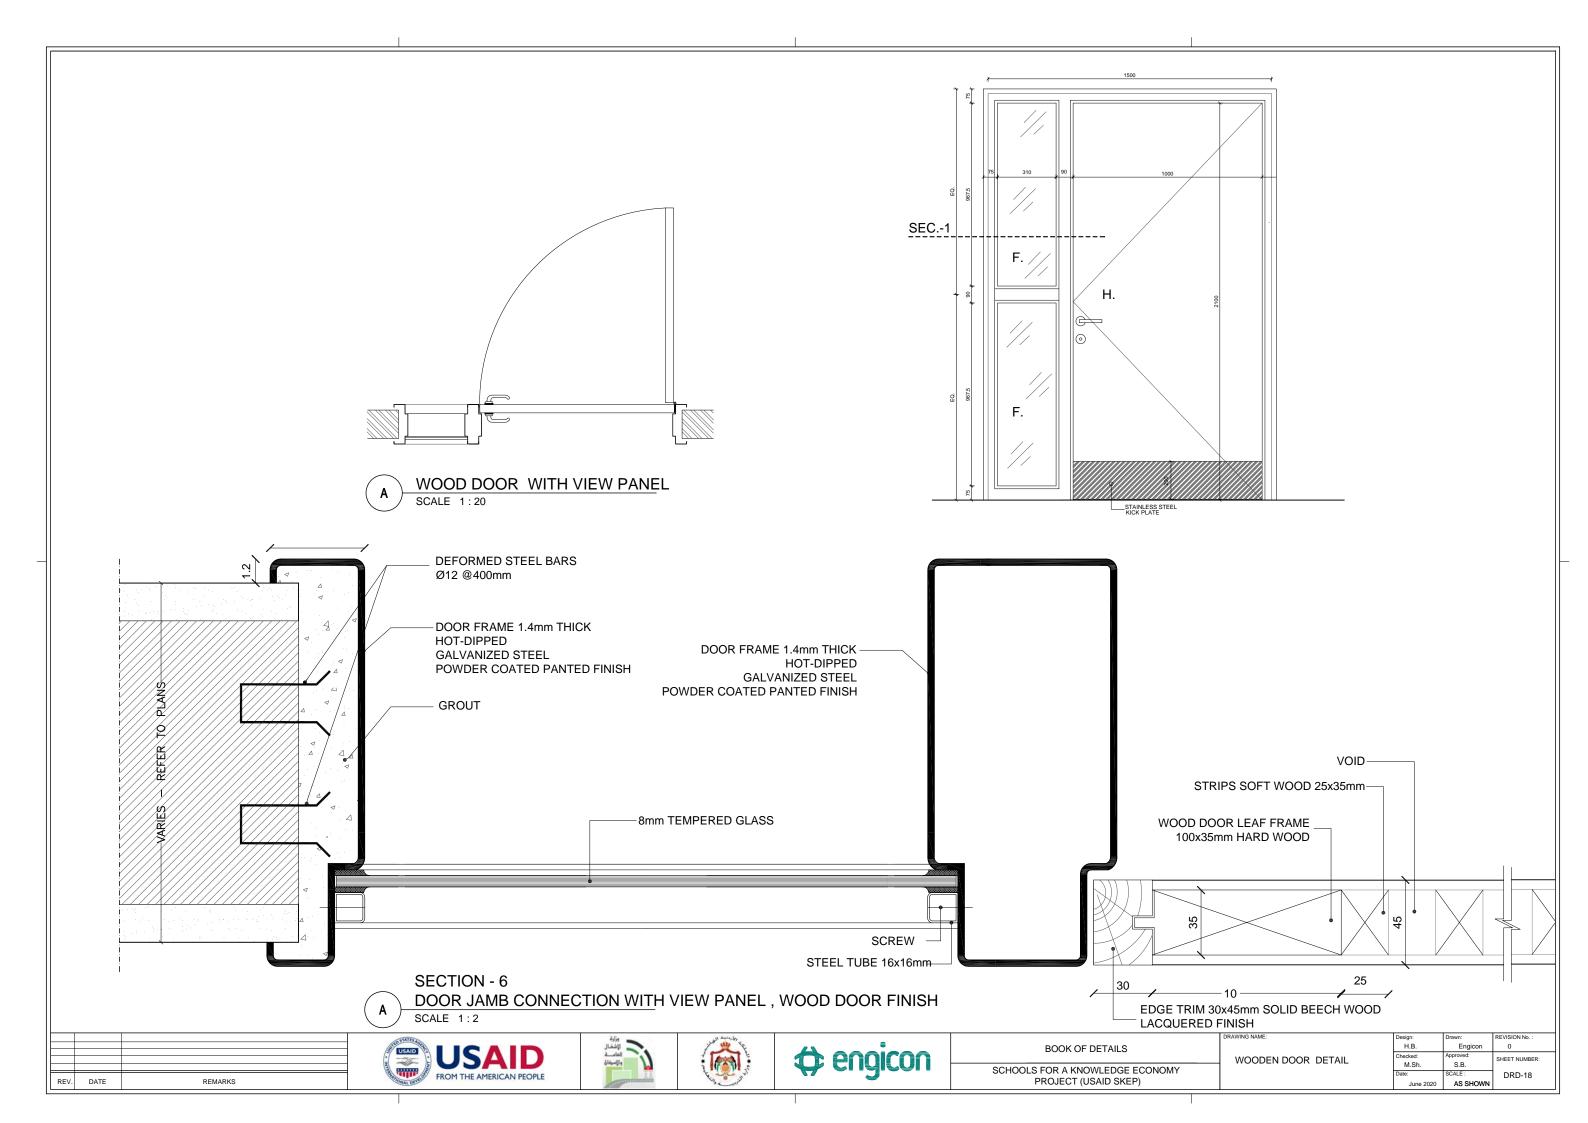

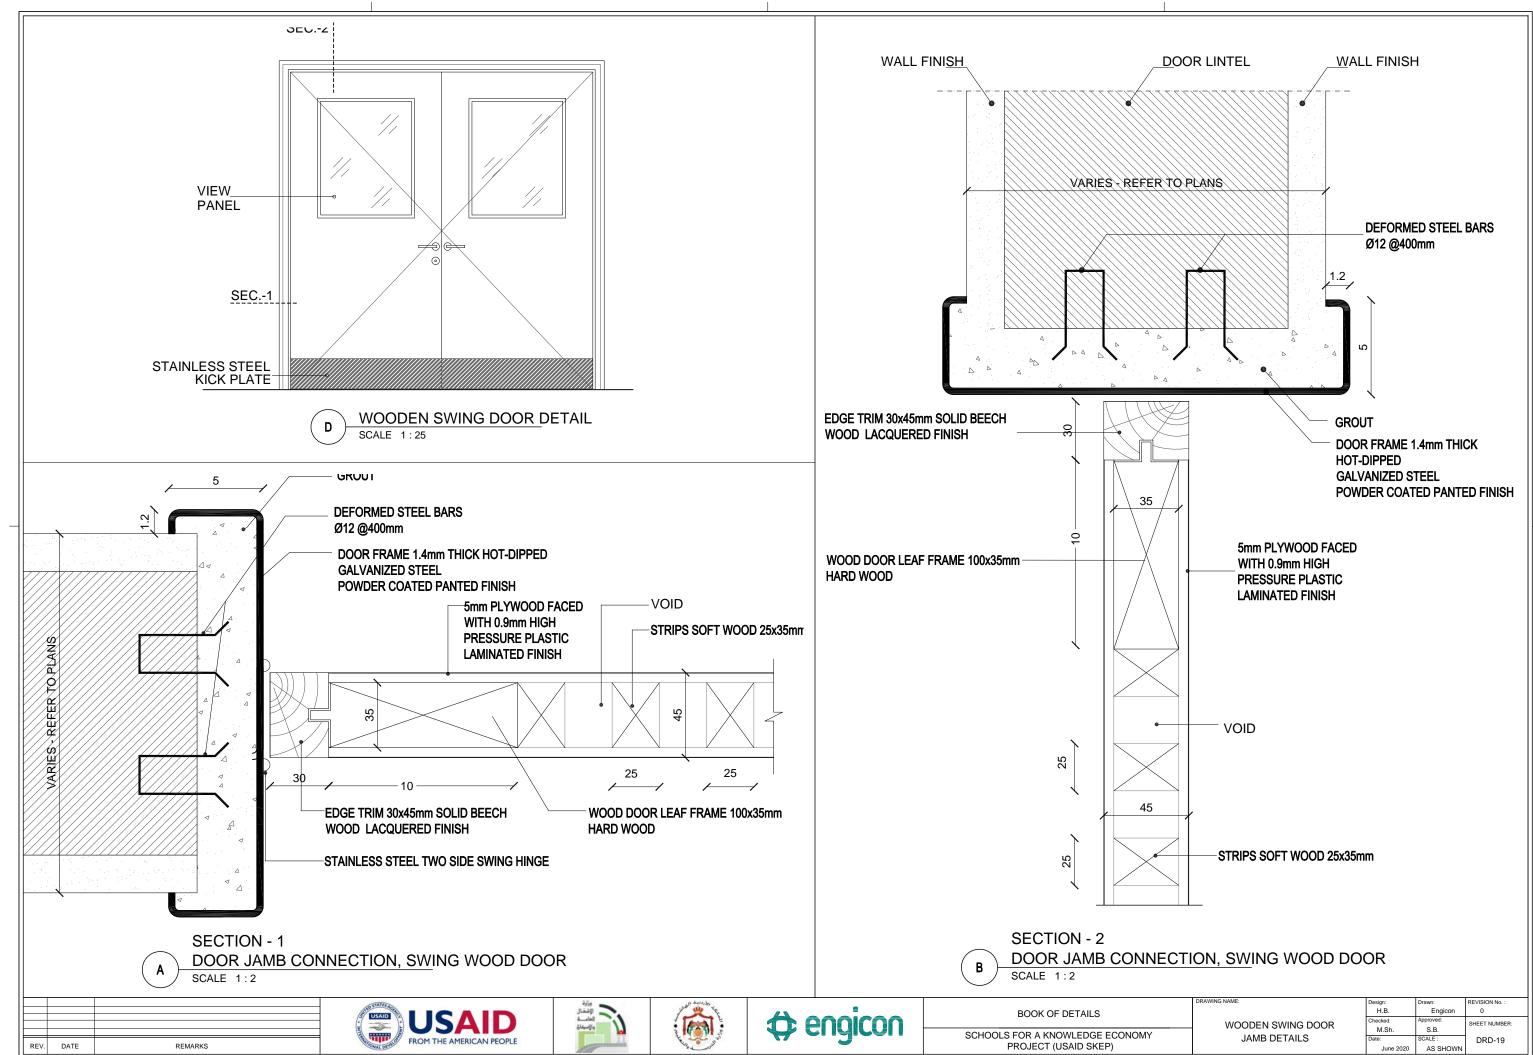

	н.в.	Engicon	0
WOODEN SWING DOOR	onounda.	Approved:	SHEET NUMBER:
	M.Sh.	S.B.	
JAMB DETAILS	Date:	SCALE :	DRD-19
	June 2020	AS SHOWN	

WINDOWS DETAILS

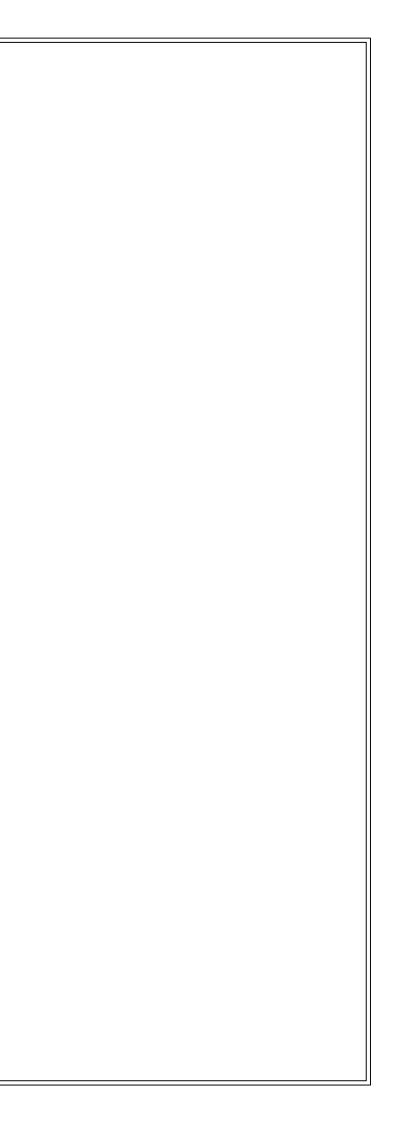

GENERAL NOTES:

- 1- ALL ALUMINUM DOORS AND WINDOWS SECTIONS SHALL BE POWDER COATED (DARK SILVER COLOR) (COLOR IS SUBJECTED TO ENGINEER APPROVAL).
- 2- ALL ALUMINUM SECTIONS SHALL BE AT LEAST 25 MICRON AND APPROVED BY THE ENGINEER FOR SLIDING WINDOWS & DOORS.
- 3- FLY SCREEN SHALL BE ALUMINUM WOVEN MESH IN AN ALUMINUM FRAME SAME COLORS AS DOORS AND WINDOWS.

4- ALL ALUMINUM DOORS AND WINDOWS SHALL BE PROVIDED WITH THE NECESSARY HARDWARE AND ACCESSORIES AS PER APPROVED SAMPLES.

- 5- ALL ALUMINUM DOORS AND WINDOWS SHALL BE COMPLETELY WEATHER AND DUST PROOF.
- 6- CONTRACTOR SHALL SUBMIT WORKSHOP DRAWINGS AND COMPLETE SAMPLES (ALL ALUMINUM SECTIONS, ACCESSORIES AND FITTINGS) ON WOODEN FRAME FOR THE ENGINEER'S APPROVAL
- 7- GLASS SPECIFICATIONS:
- A ALL ACCESSORIES & FIXING MATERIAL SUCH AS NEOPRENE GASKETS, BRUSHES,SCREWS & SILICON SHALL BE APPROVED BY THE ENGINEER.
- B- ALL WINDOWS SHALL BE DOUBLE GLAZED
 - 6mm CLIMAGUARD NEUTRAL 70 TEMPERED GLASS
 - 12mm AIRSPACE
 - 6mm CLEAR GLASS TEMPERED
- C- ALL WINDOWS SIZES SHALL BE VERIFIED FROM ACTUAL SITE CONDITIONS.
- D- GLAZING SHALL BE EXECUTED BY ALUMINUM SUPPLIER.

GLAZING PERFORMANCE DATA:


CHARACTERISTICS	
VISIBLE LIGHT	
TRANSMISSION (%)	67
REFLECTION-OUT (%)	12
REFLECTION-IN (%)	12
SOLAR ENERGY	
TRANSMISSION (%)	46
REFLECTION-OUT (%)	16
U-VALUE	
W/SQ.M/C	1.9
SOLAR HEAT GAIN CO-EFFICIENT	0.54
SHADING CO-EFFICIENT (SHGC/0.87)	0.62

REV.	DATE	REMARKS









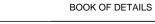



SCHOOLS FOR A KNOWLEDGE ECONOMY PROJECT (USAID SKEP)

DRAWING NAME:	Design:	Drawn:	REVISION No. :
	H.B.	Engicon	0
GENERAL NOTES	Checked:	Approved:	SHEET NUMBER:
	M.Sh.	S.B.	GHEET HOMBER
ALUMINUM DOORS & WINDOWS	Date:	SCALE :	WD01
	June 2020	AS SHOWN	

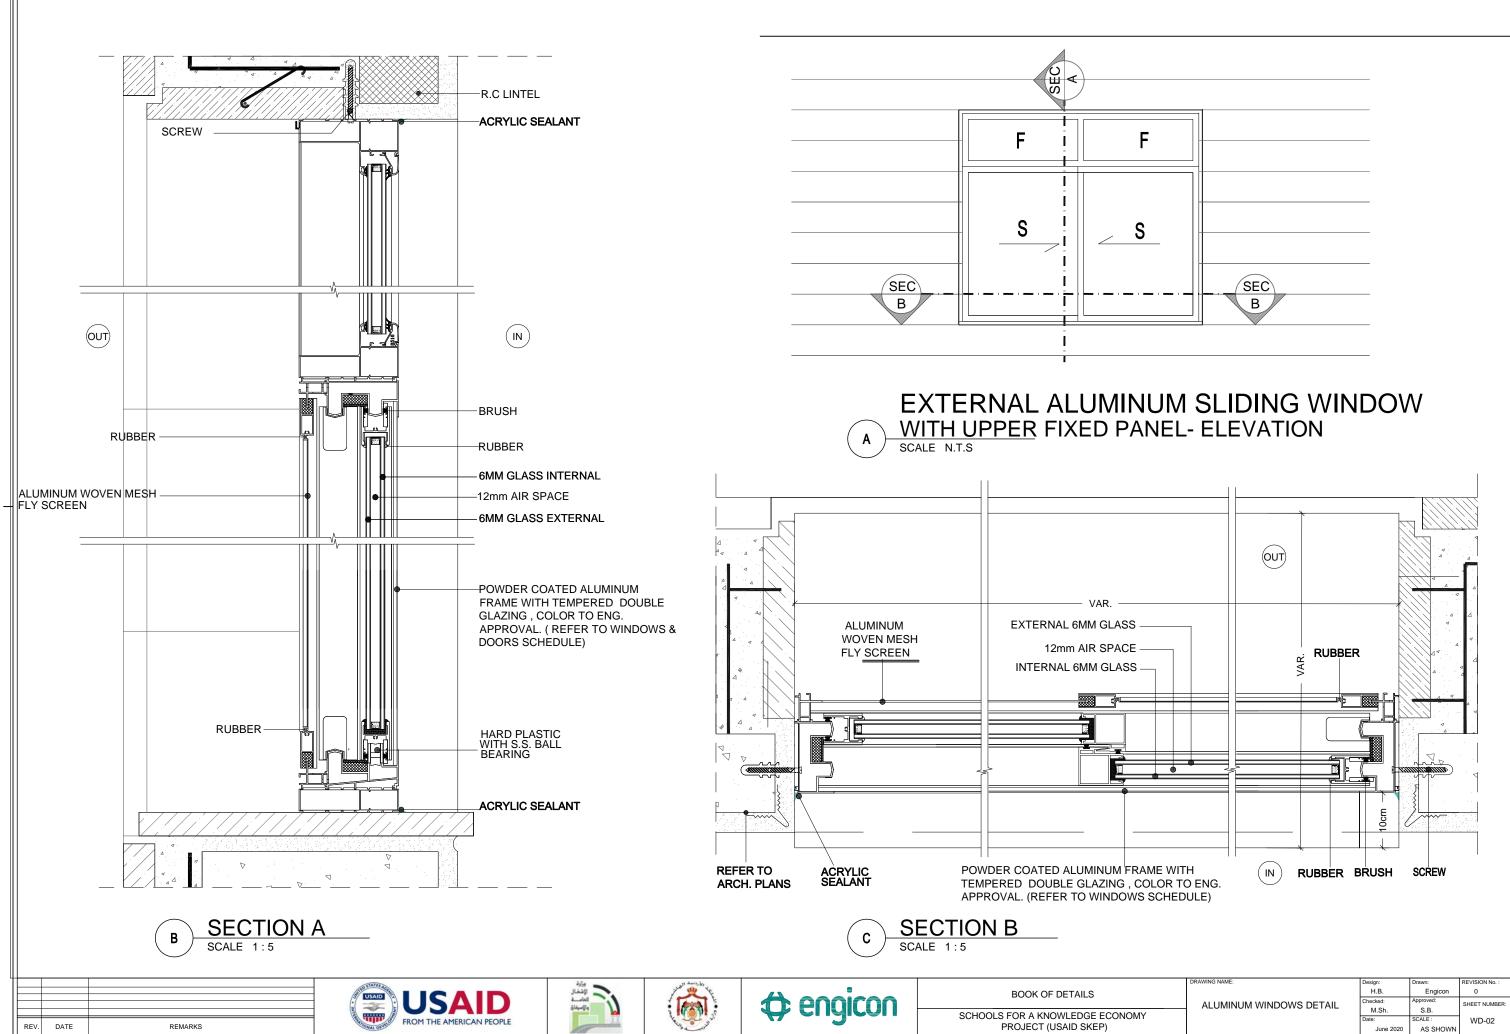


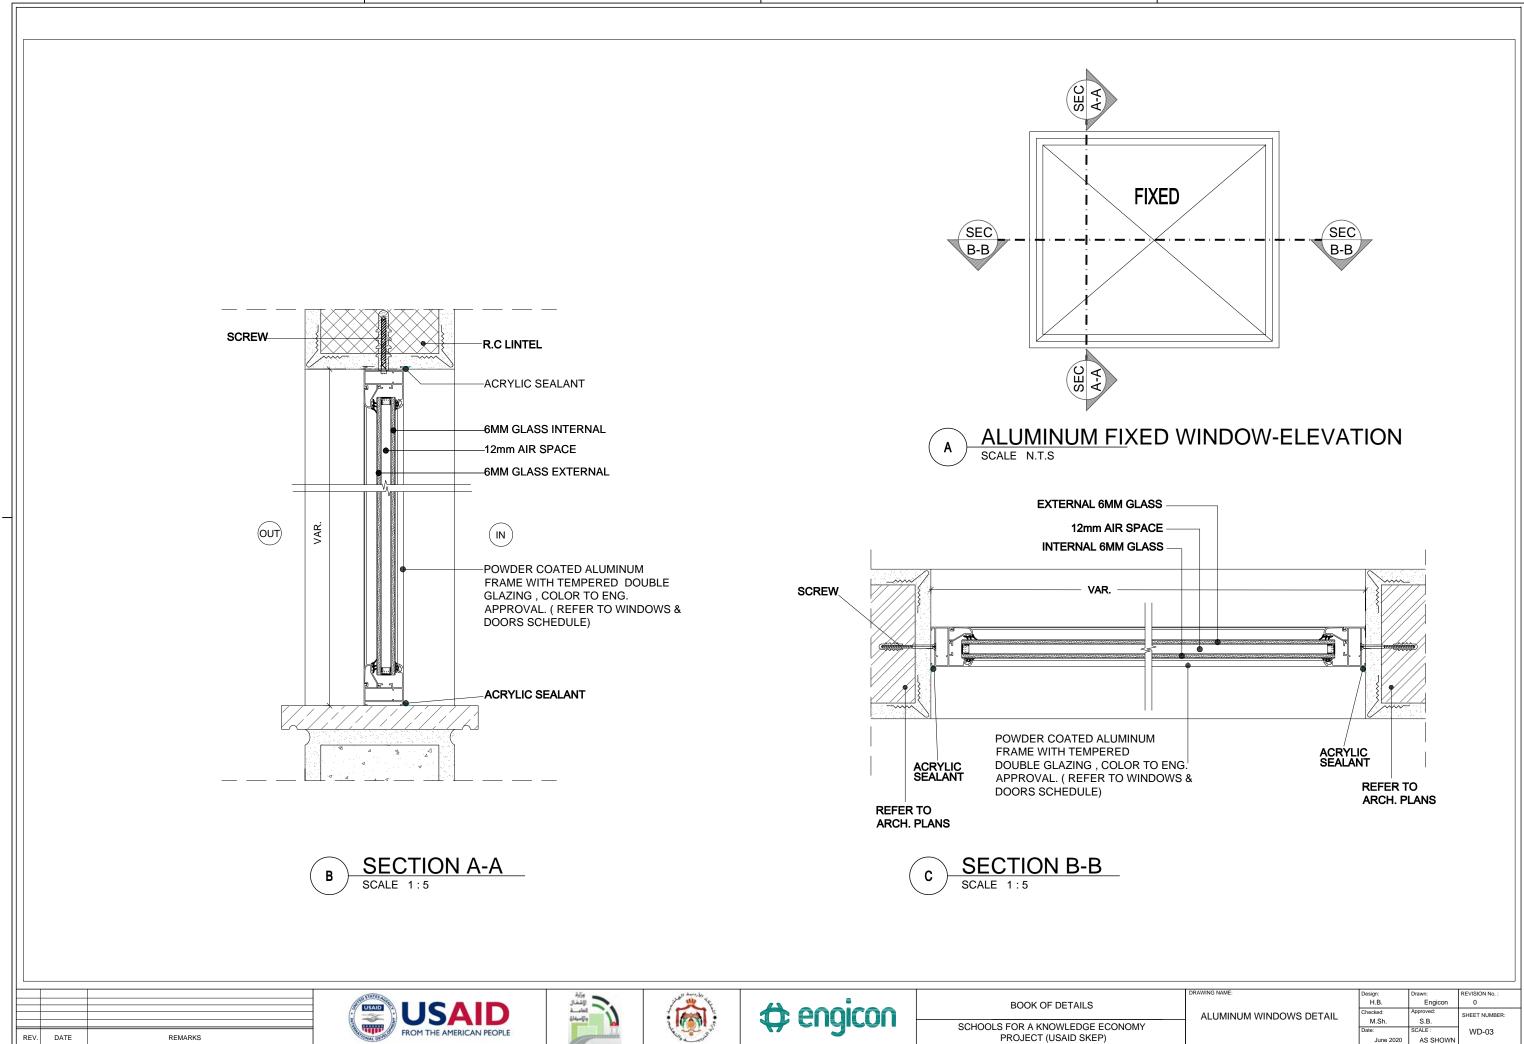


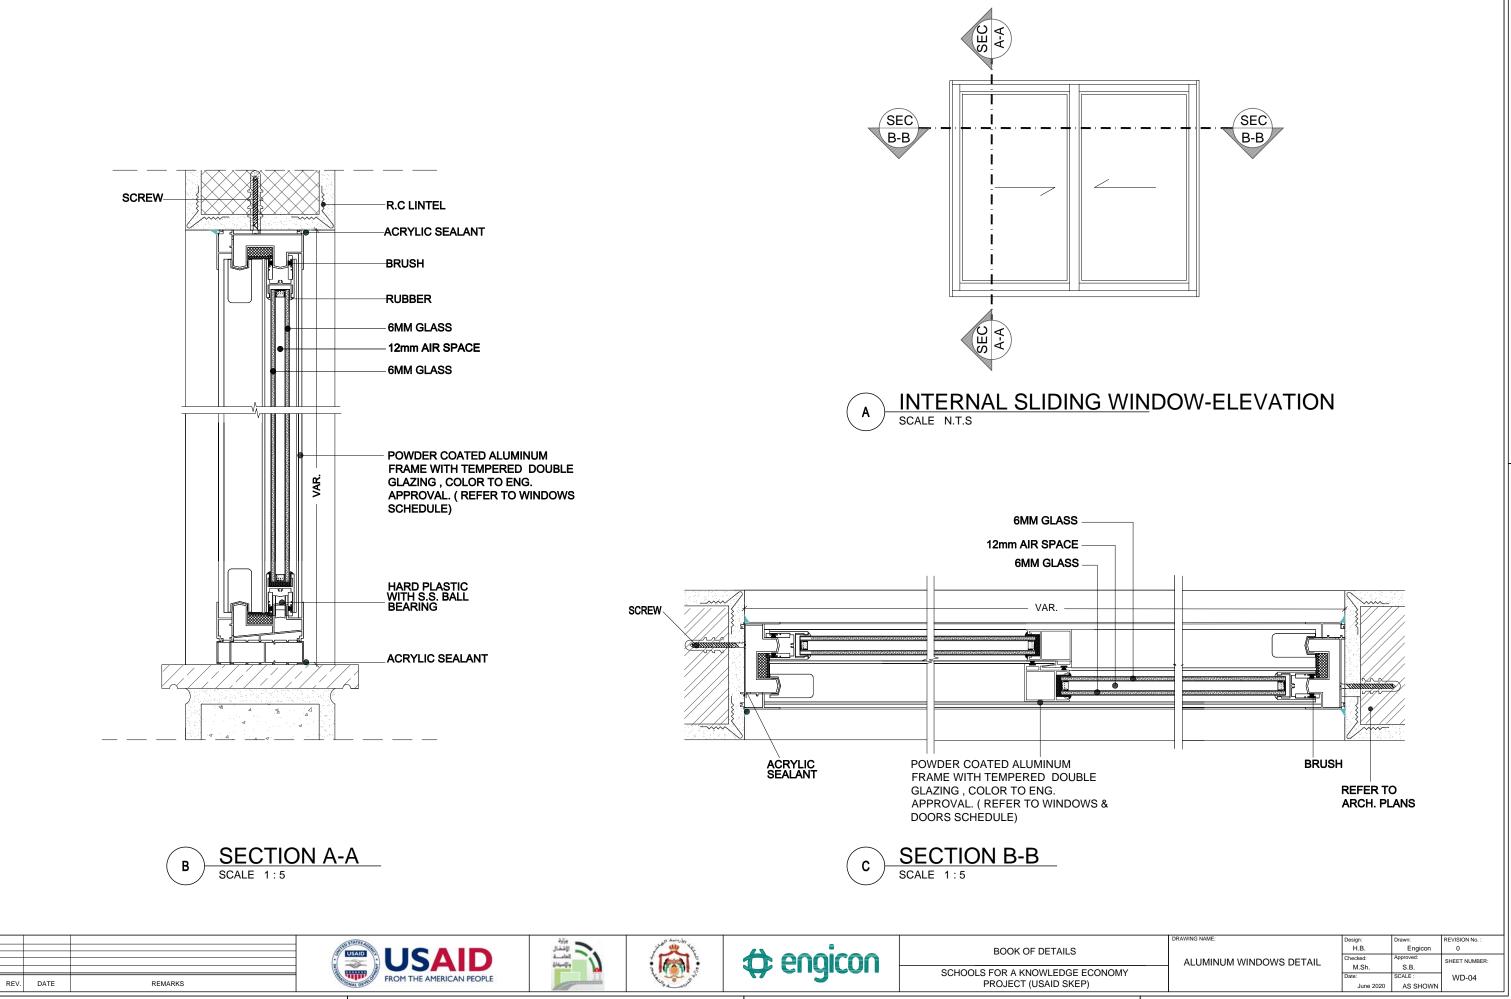

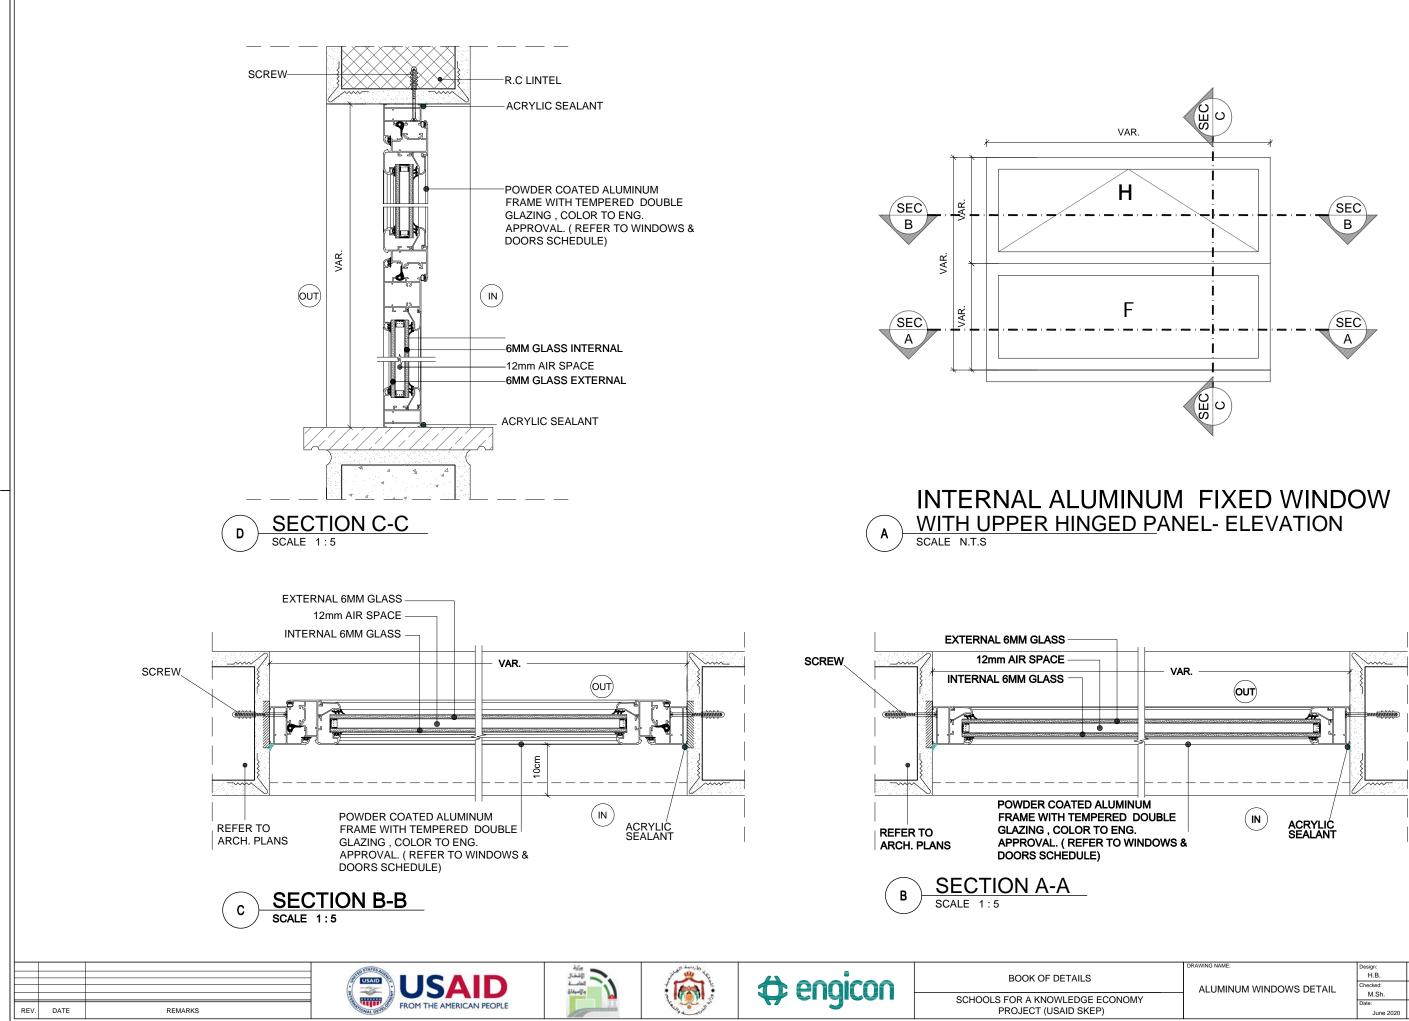


	DRAWING NAME:	Design:	Drawn:	REVISION No. :
	H.B.	Engicon	0	
	ALUMINUM WINDOWS DETAIL	Checked:	Approved:	SHEET NUMBER:
		M.Sh.	S.B.	ONEET NOMBER.
		Date:	SCALE :	WD-05
		June 2020	AS SHOWN	

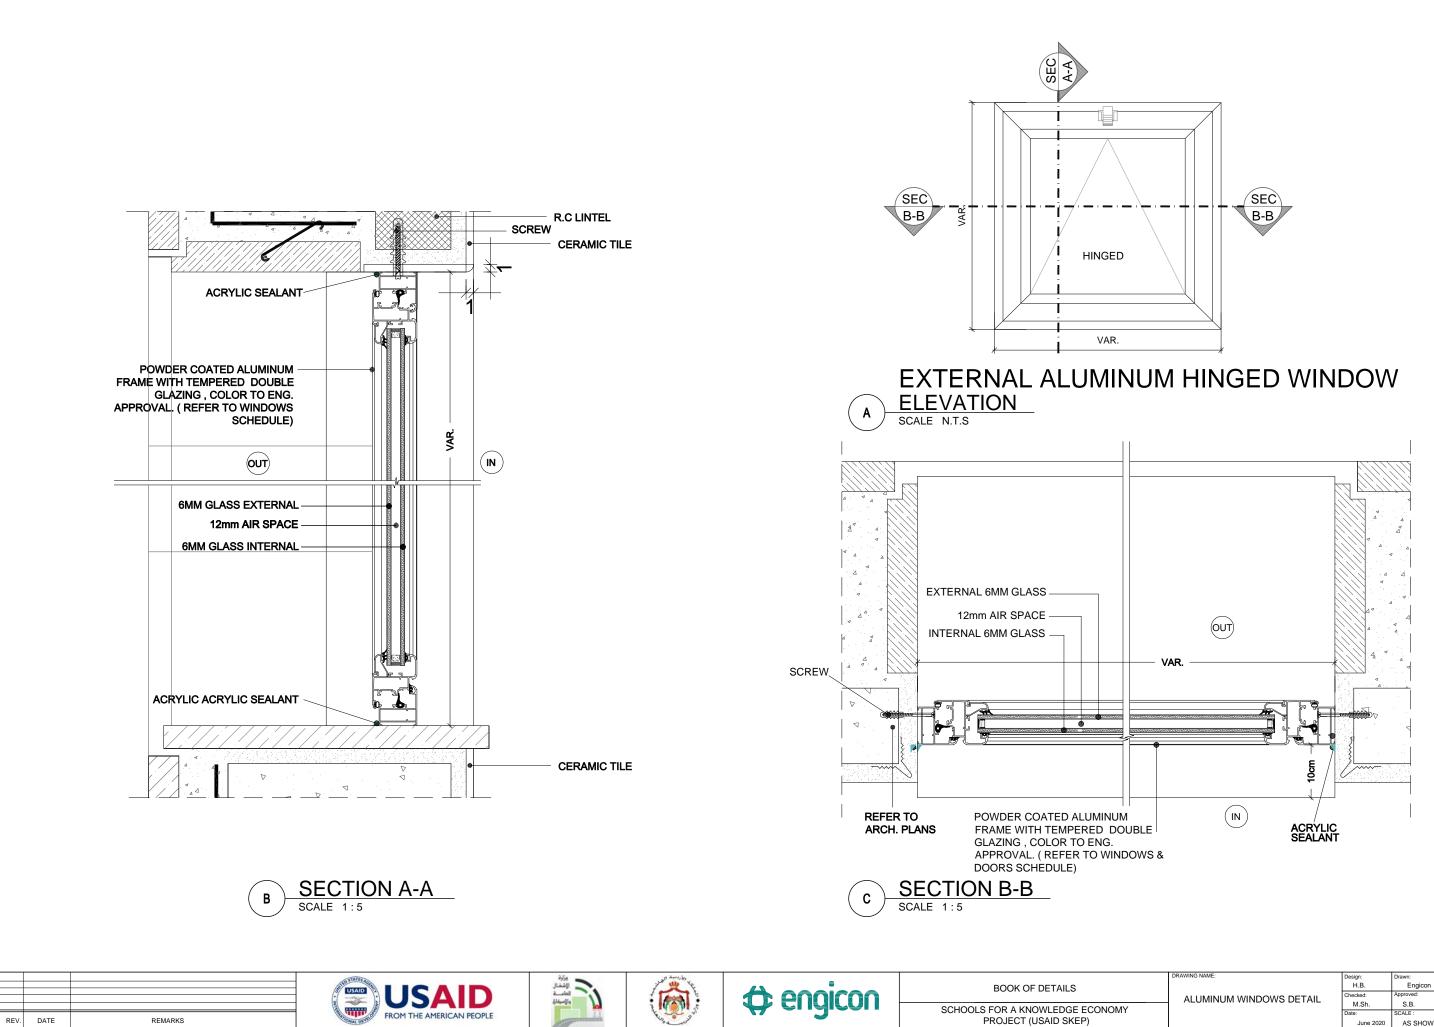

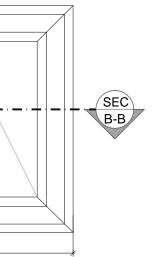

	DRAWING NAME:	Design:	Drawn:	REVISION No. :
	ALUMINUM WINDOWS DETAIL	H.B.	Engicon	0
		Checked:	Approved:	SHEET NUMBER:
		M.Sh.	S.B.	UNEET NOMBER
		Date:	SCALE :	WD-06
		June 2020	AS SHOWN	

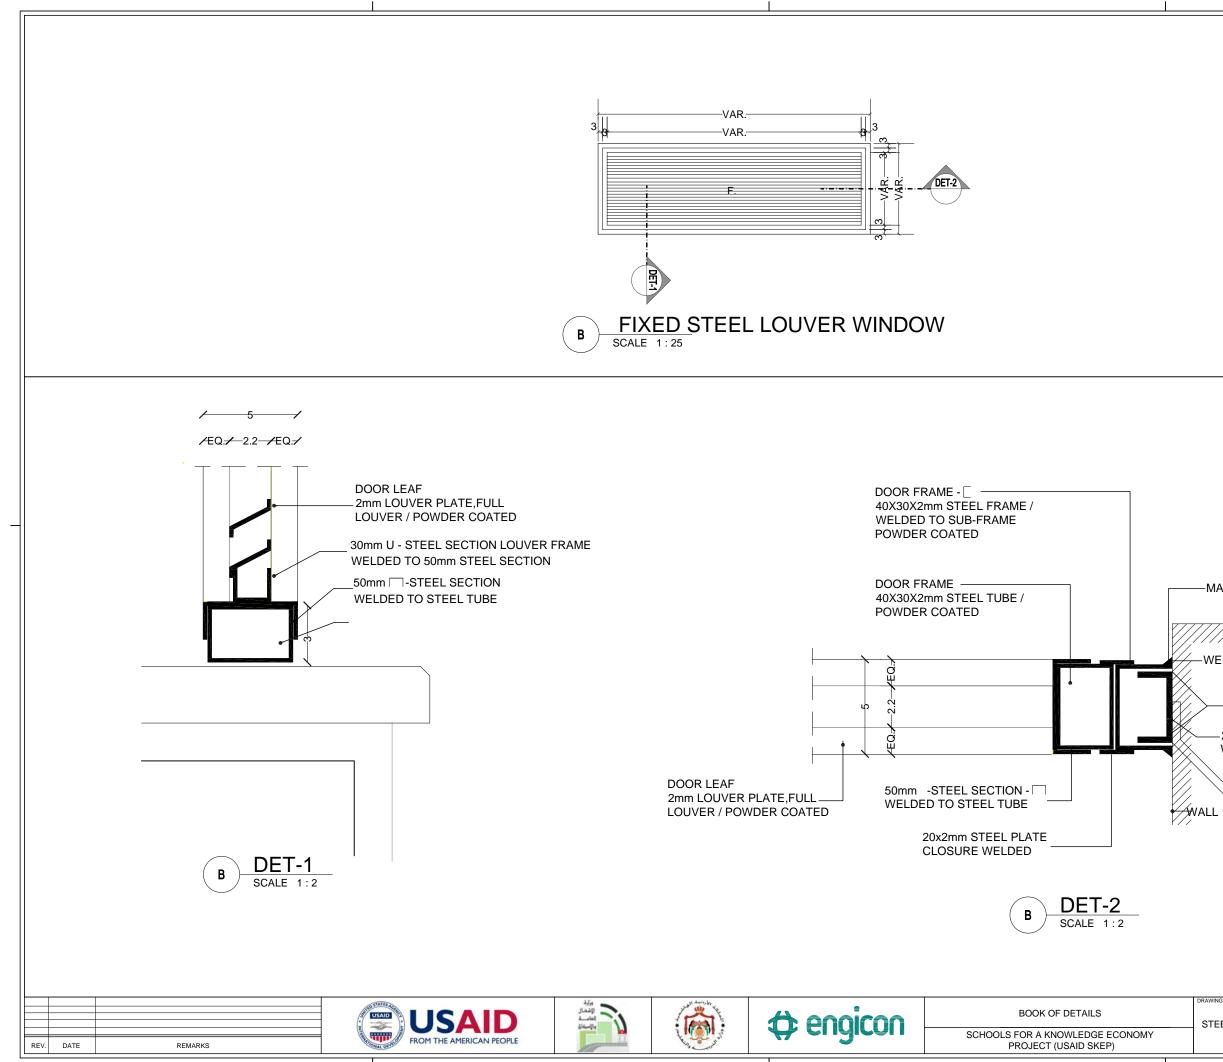

	DRAWING NAME:			251/010111
DRAWING NAME:	DRAWING NAME:	Design:	Drawn:	REVISION No. :
	STEEL LOUVER WINDOWS DETAIL	H.B.	Engicon	0
		Checked:	Approved:	SHEET NUMBER:
	STELL LOOVER WINDOWS DETAIL	M.Sh.	S.B.	
		Date:	SCALE :	WD-07
		June 2020	AS SHOWN	

20mm -STEEL SECTION WELDED TO STEEL ANCHOR

- BUILT IN ANCHOR


AT ADEQUATE SPACES


-MASTIC


-WELDS

-WELDS


	CURTAIN WALL AT TYPICAL HORIZONTA SCALE 1:4	TRANSOM OUTER EDGE	 L			CURTAIN WALL AT OPENING UTER EL GLASS SPA
			مرتاد الشغال المام		<pre>engicon</pre>	BOOK OF DETAILS
REV.	DATE REMARKS	FROM THE AMERICAN PEOPLE	Ordendid	A CONTRACT OF		SCHOOLS FOR A KNOWLEDGE ECONOMY PROJECT (USAID SKEP)

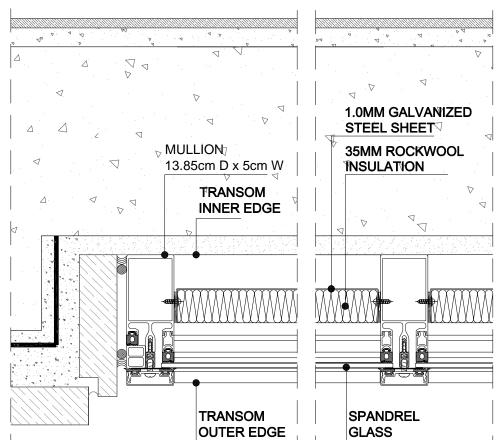


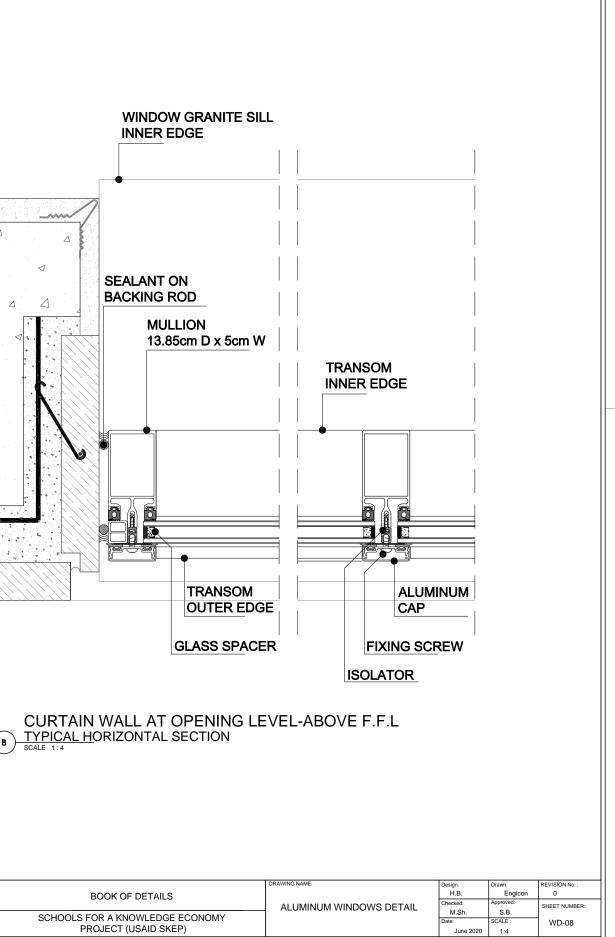

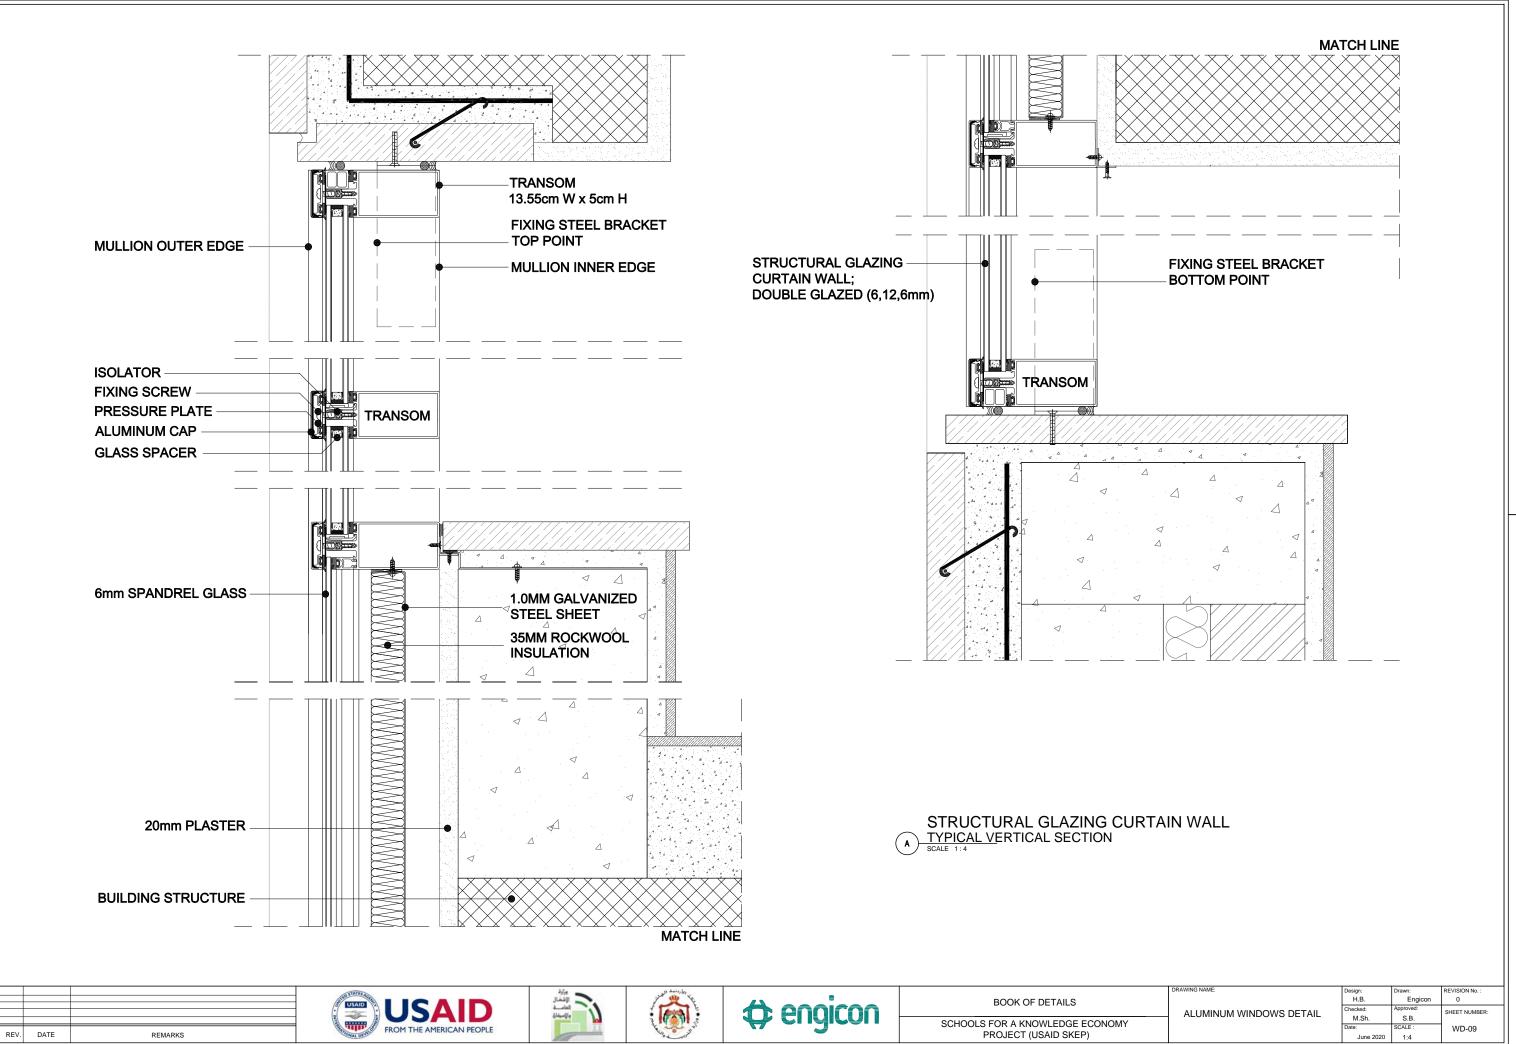

SCHOOL COMPONENTS FIXED FURNITURE DETAILS

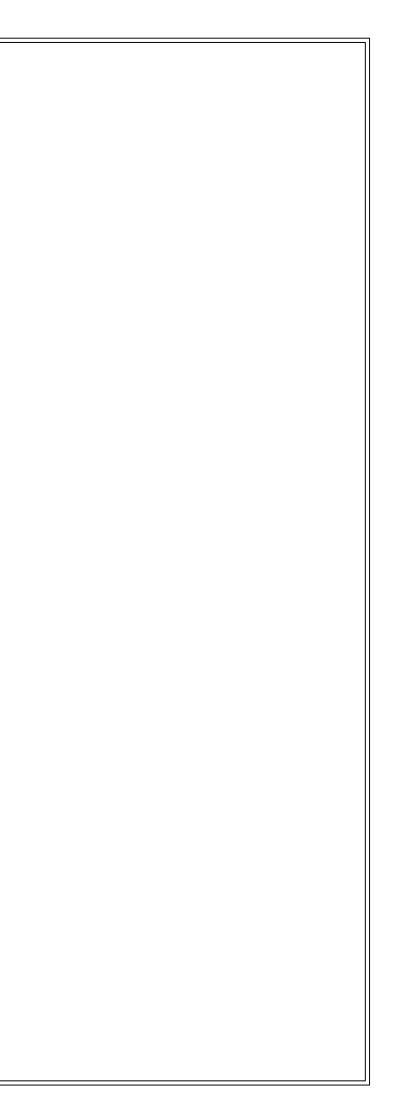

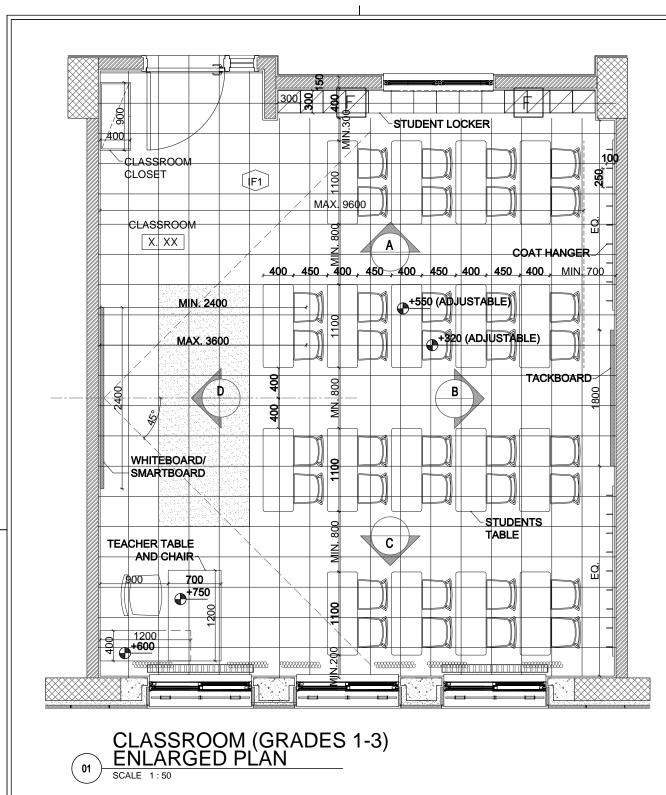


MOUNTING HEIGHTS FOR TACKBOARD AND MARKERBOARD (FLOOR TO BOTTOM OF FRAME/TRAY)	
GRADE LEVEL:	MOUNTING HEIGHT:
KINDERGARTEN, AND 1ST TO 3RD GRADE	60cm
3RD TO 5TH GRADE	70cm
6TH TO12TH GRADE	90cm


REMARKS	FROM THE AMERICAN PEOPLE







TAG	TILING DESCRIPT	ΓΙΟΝ			
IF#	INTERIOR FLOOR TILES REFERENCE IF1: FULL BODY FULLY VITRIFI POLISHED -SIZE 40X40cm- COU BEIGE (TO APPROVAL OF THE IF2: FULL BODY FULLY VITRIFI POLISHED- SIZE 40X40cm- COU MAROON (TO APPROVAL OF T	ED PORCELAIN- LOR SHADE LIGHT ENGINEER) ED PORCELAIN- LOR SHADE LIGHT			
IW#	INTERIOR WALL FINISH REF NUMBE IW4: FULL BODY FULLY VITRIFIED P SIZE 40X40cm- UP TO 1.2m WITH 1.1 TRIM TOPPED WITH PLASTER AND	ORCELAIN- POLISHED- Icm ALUMINUM ANGLE			
	LIGHT BEIGE				
NOTE:	(REF TO SCHOOL DRAWINGS)				
	100 SCRE				
(02	HANGING HEIGH GRADES 1-3 SCALE 1:10		1		Januara
	BOOK OF DETAILS	FIXED FURNITURE DETAILS	Design: H.B. Checked: M.Sh	Drawn: Engicon Approved:	REVISION No. : 0 SHEET NUMBER:
SCHOOL	S FOR A KNOWLEDGE ECONOMY PROJECT (USAID SKEP)	TYPICAL CLASSROOM (GRADE 1-3)	M.Sh. Date: June 2020	S.B. SCALE : AS SHOWN	FFD-01

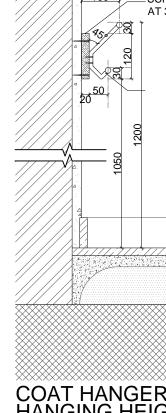

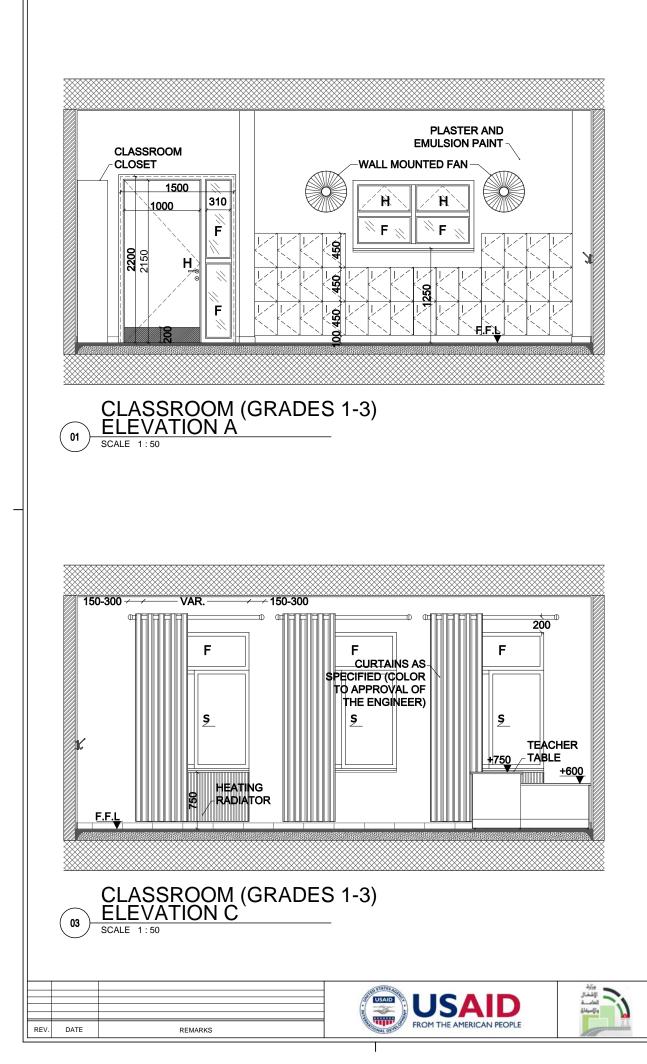

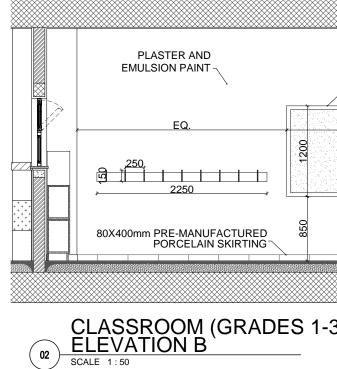

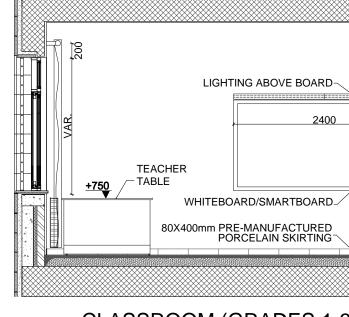




characteristics

BOOK OF DETAILS

SCHOOLS FOR A KNOWLEDGE ECONOMY PROJECT (USAID SKEP)

TACKBOARD 1800 CHROME COAT HANGER CHROME COAT HANGER HEATING RADIATOR F.E.L 3)	
03 FFD01 PLASTER AND EMULSION PAINT	
3)	

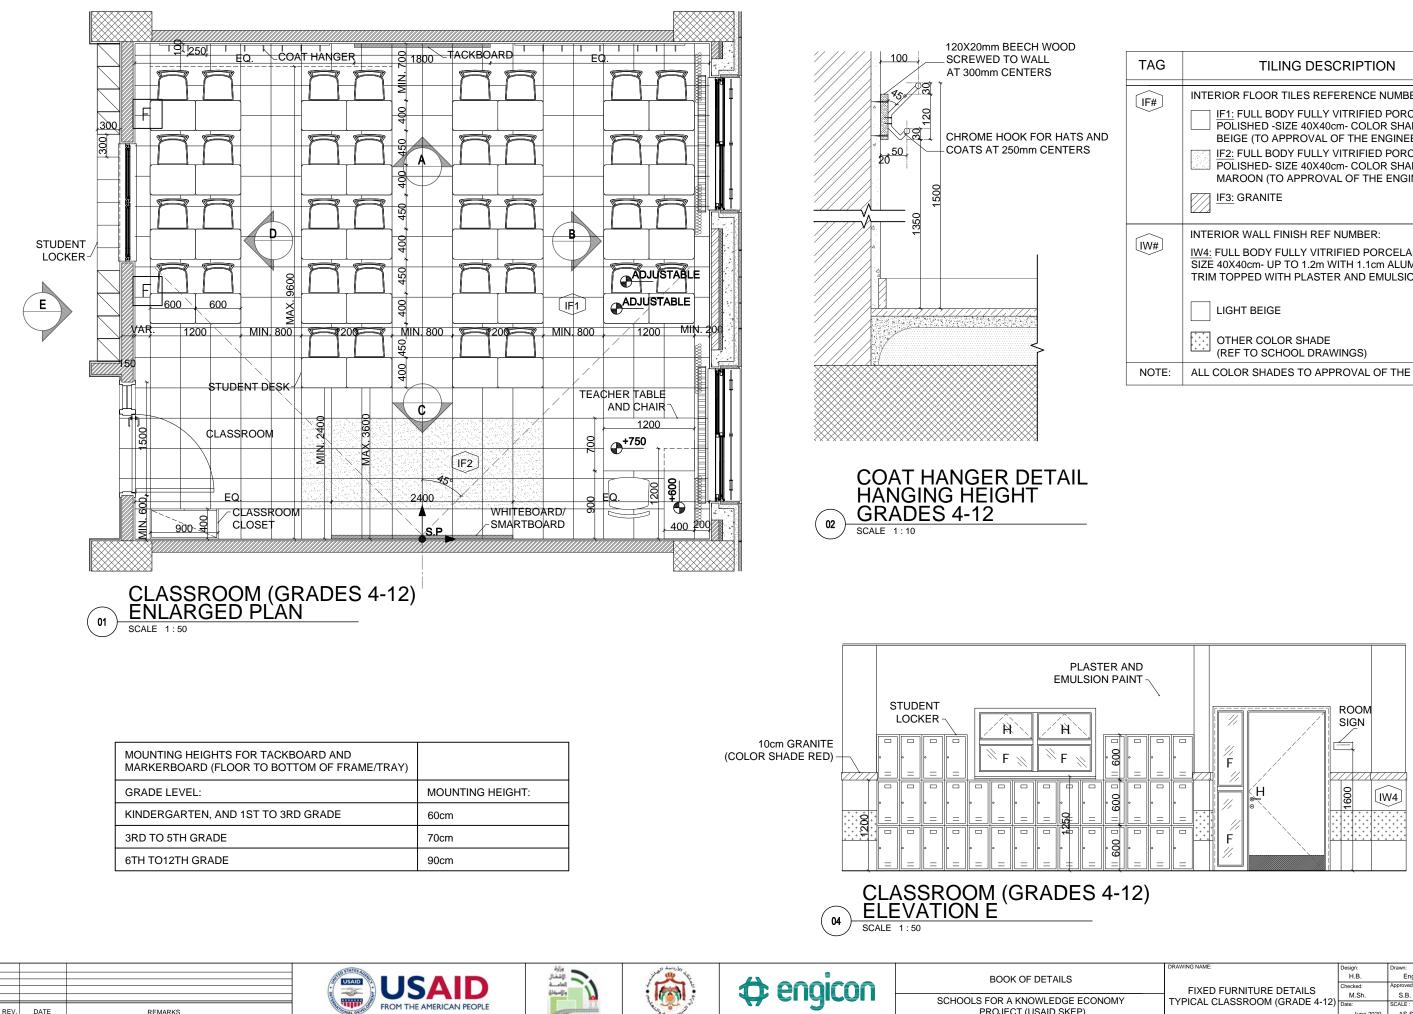



REMARKS


PROJECT (USAID SKEP)

ΓAG	TILING DESCRIPTION
IF#	INTERIOR FLOOR TILES REFERENCE NUMBER: IF1: FULL BODY FULLY VITRIFIED PORCELAIN- POLISHED -SIZE 40X40cm- COLOR SHADE LIGHT BEIGE (TO APPROVAL OF THE ENGINEER) IF2: FULL BODY FULLY VITRIFIED PORCELAIN- POLISHED- SIZE 40X40cm- COLOR SHADE LIGHT MAROON (TO APPROVAL OF THE ENGINEER) IF3: GRANITE
W#	INTERIOR WALL FINISH REF NUMBER: IW4: FULL BODY FULLY VITRIFIED PORCELAIN- POLISHED- SIZE 40X40cm- UP TO 1.2m WITH 1.1cm ALUMINUM ANGLE TRIM TOPPED WITH PLASTER AND EMULSION PAINT LIGHT BEIGE OTHER COLOR SHADE (REF TO SCHOOL DRAWINGS)
NOTE:	ALL COLOR SHADES TO APPROVAL OF THE ENGINEER


		-		
	DRAWING NAME:	Design:	Drawn:	REVISION No. :
	FIXED FURNITURE DETAILS	H.B.	Engicon	0
		Checked:	Approved:	SHEET NUMBER:
		M.Sh.	S.B.	
		Date:	SCALE :	FFD-03
		June 2020	AS SHOWN	

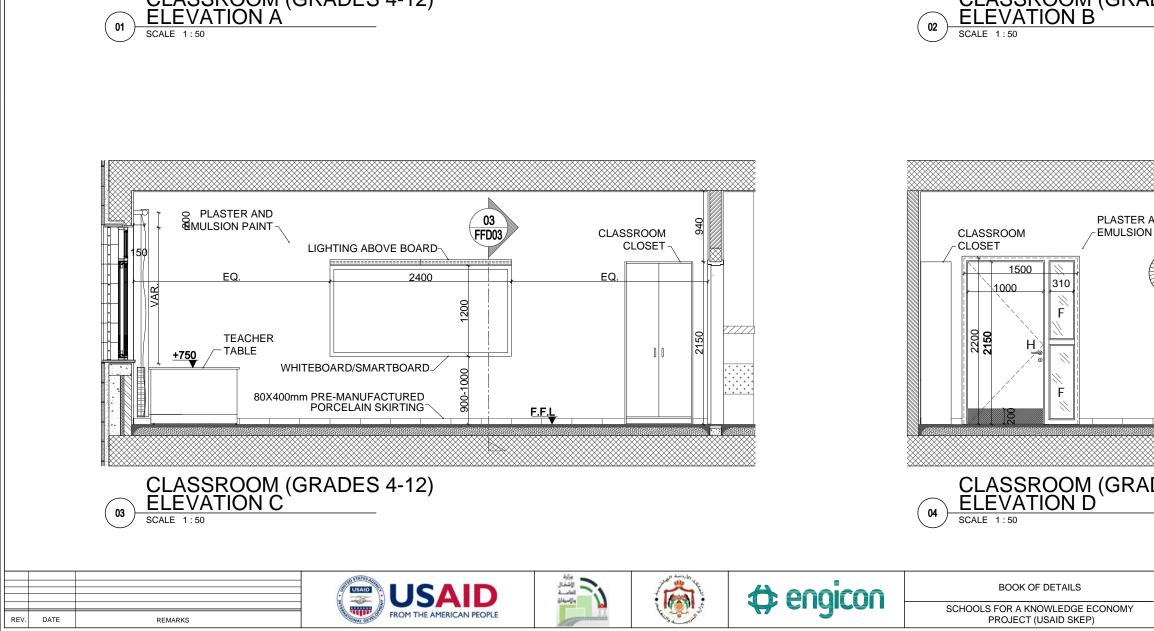

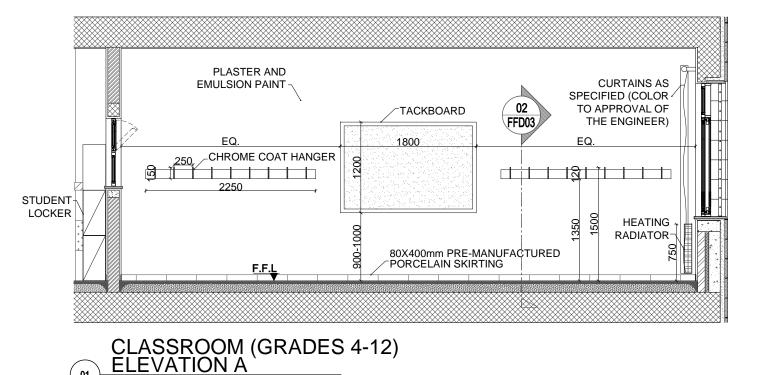

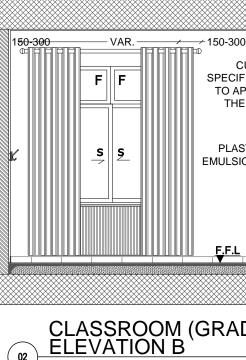

00 150-300 CURTAINS AS- IFIED (COLOR APPROVAL OF IE ENGINEER) STER AND SION PAINT- F F F F F F F F F F F F F	
ADES 4-12)	
AND N PAINT WALL MOUNTED FAN WALL MOUNTED FAN F F F F F F F F F F F F F F F F F F	
DES 4-12)	

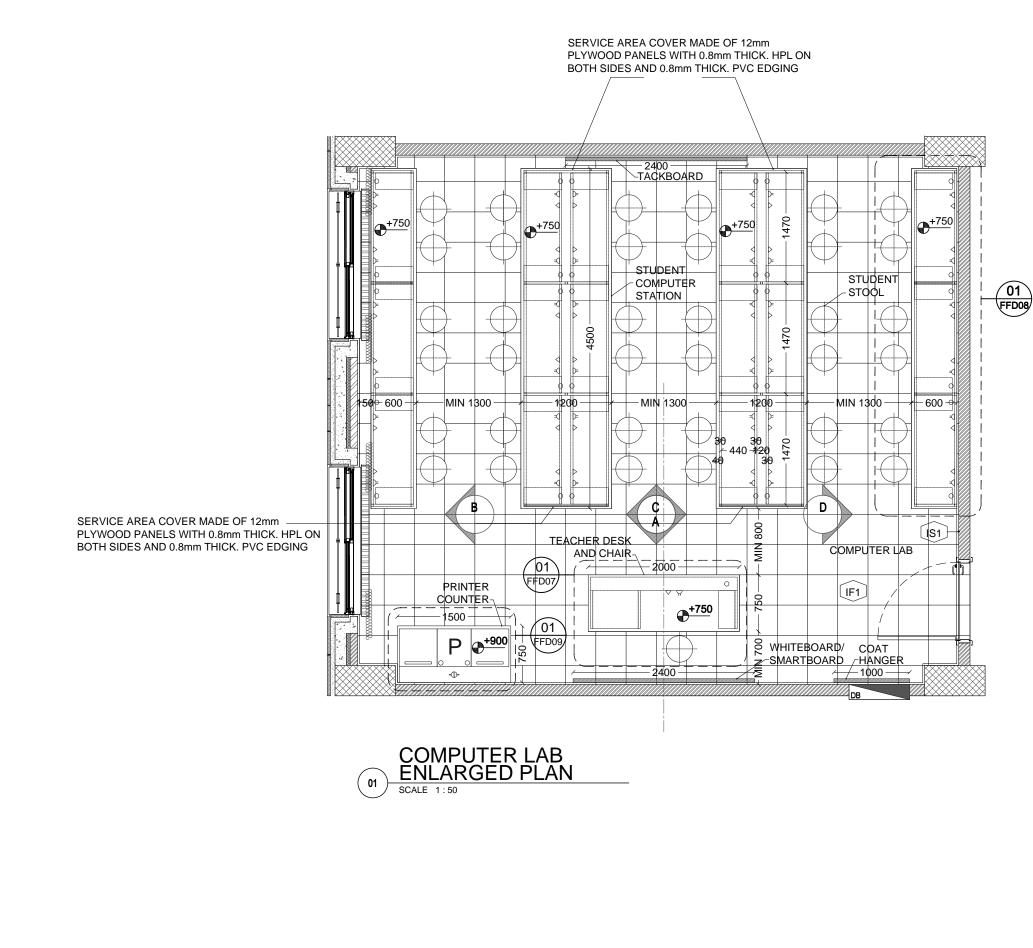

REV.	DATE	REMARKS








BOOK OF DETAILS


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	H.B.	Engicon	0
FIXED FURNITURE DETAILS	Checked:	Approved:	SHEET NUMBER:
	M.Sh.	S.B.	
TYPICAL COMPUTER LAB	Date:	SCALE :	FFD-05
ENLARGED PLAN	June 2020	1:50	

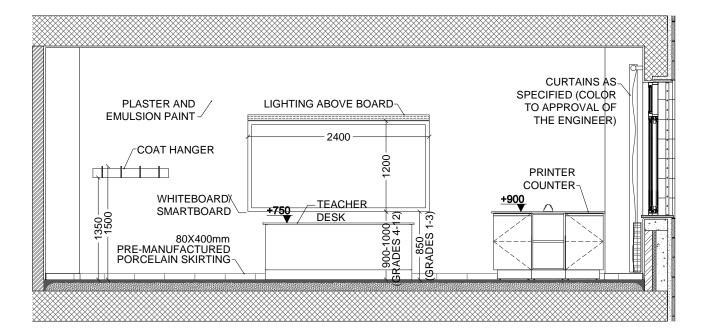



REMARKS


REV. DATE

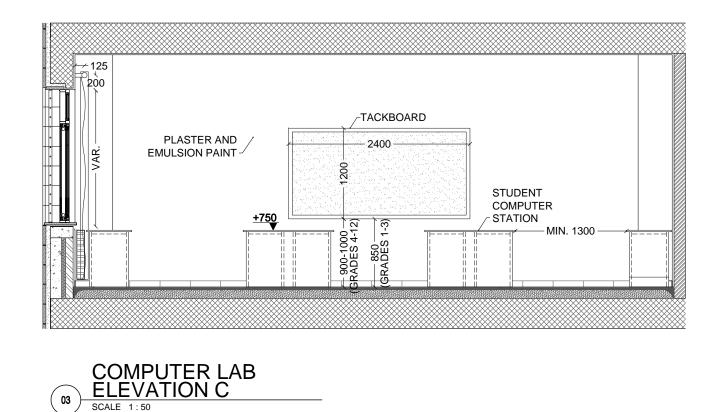


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الإشغال الإشغال والإسهارة


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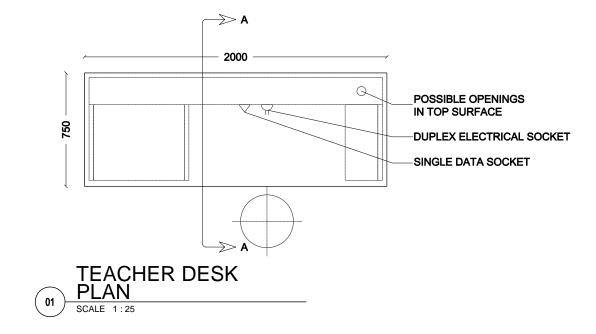




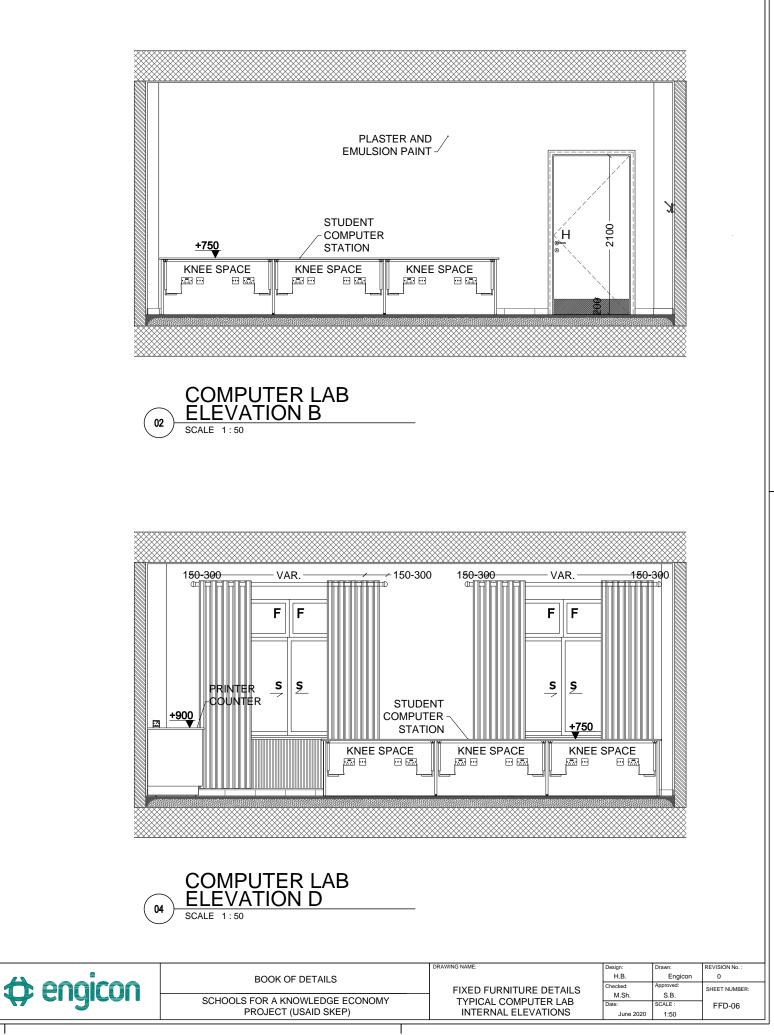


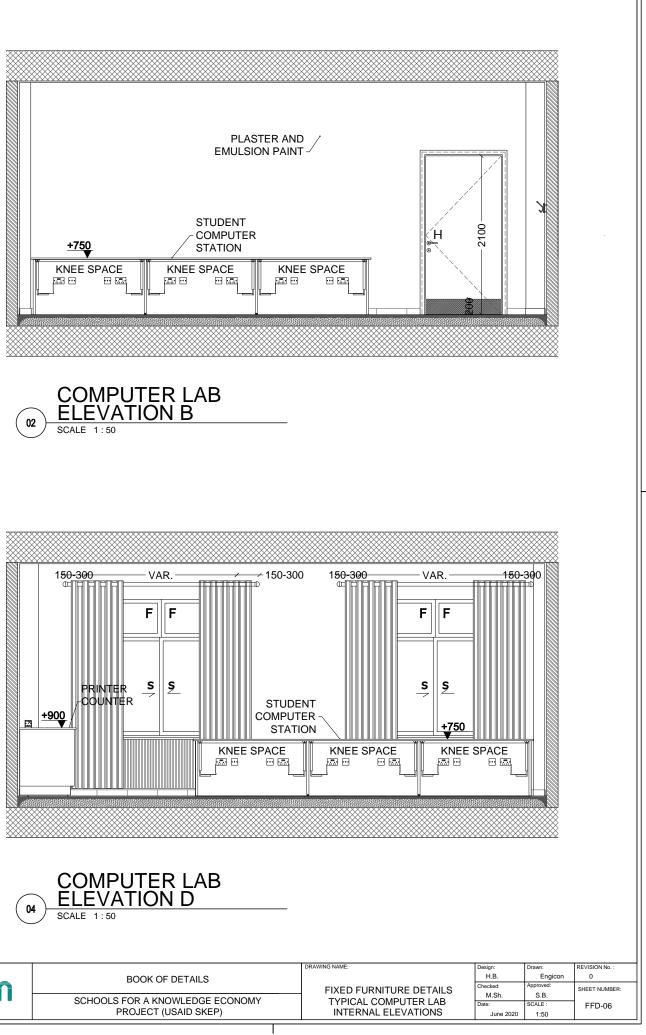


	750 VALUE OF COVERED V METAL CPU SINGLE DAT SINGLE DAT VALUE OF COVERED V SINGLE DAT O.8mm THIC EPOXY POV 30X30X1.5m BACK PANE COVERED V	TA SOCKET E FILLER MADE OF 12mm THICK PLYV TH 0.8mm THICK HPL ON BOTH SIDES, K PVC EDGING WDER COATED METAL FRAME MADE (nm CROSS SECTIONAL TUBES EL MADE OF 18mm THICK PLYWOOD P. WITH 0.8mm HIGH PRESSURE LAMINAT S AND 2mm THICK PVC EDGING E SCREW	VOOD AND DF ANELS &	KNEE SPACE	DRAWERS UNIT SINGLE DATA SOCKET DUPLEX ELECTRICAL SOCKET METAL CPU HOLDER
	TEACHER DESK SECTION A-A SCALE 1:25			TEACHER DESK FRONT ELEVATION SCALE 1:25	
REV. DATE REMARKS	FROM THE AMERICAN PEOPLE	Hall And	the engicon	BOOK OF DETAILS SCHOOLS FOR A KNOWLEDGE ECONOMY PROJECT (USAID SKEP)	DRAWING NAME: FIXED FURNITURE DETAILS TYPICAL COMPUTER LAB TEACHER DESK Ju

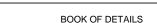


DRAWING NAME:	Design:	Drawn:	REVISION No. :
	H.B.	Engicon	0
FIXED FURNITURE DETAILS	Checked:	Approved:	SHEET NUMBER:
	M.Sh.	S.B.	CHEET NOMBER.
TYPICAL COMPUTER LAB	Date:	SCALE :	FFD-07
TEACHER DESK	June 2020	1:25	

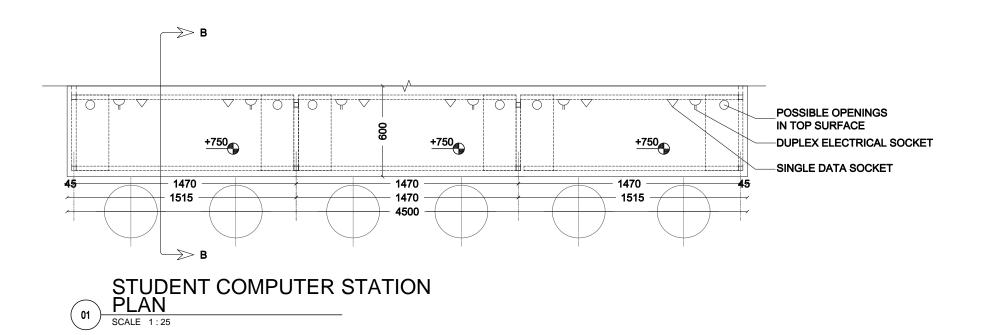


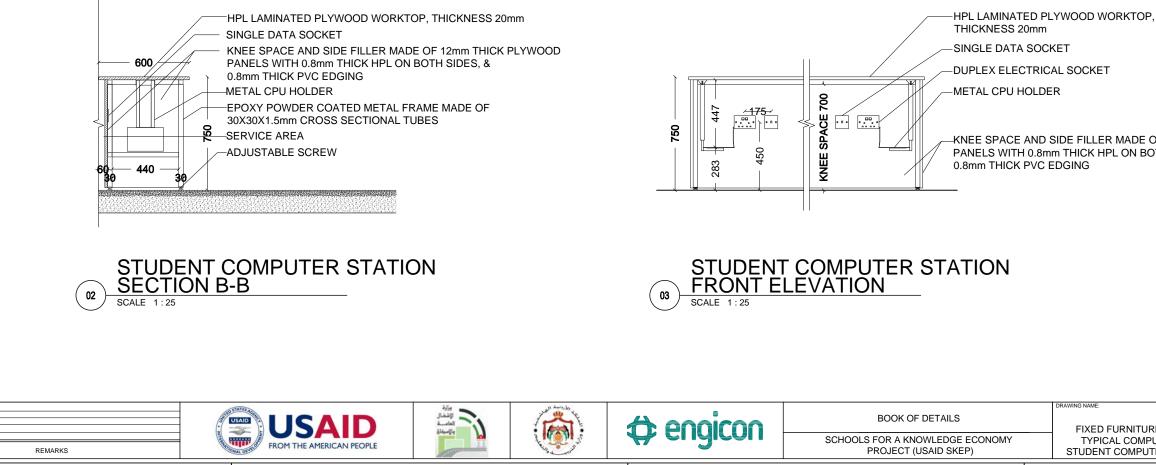


DRAWING NAME:	Design: H.B.	Drawn: Engicon	REVISION No. : 01
	Checked: M.Sh.	Approved: S.B.	SHEET NUMBER:
TYPICAL COMPUTER LAB STUDENT COMPUTER STATION	Date: June 2020	SCALE : 1:25	FFD-08


-KNEE SPACE AND SIDE FILLER MADE OF 12mm THICK PLYWOOD PANELS WITH 0.8mm THICK HPL ON BOTH SIDES, &

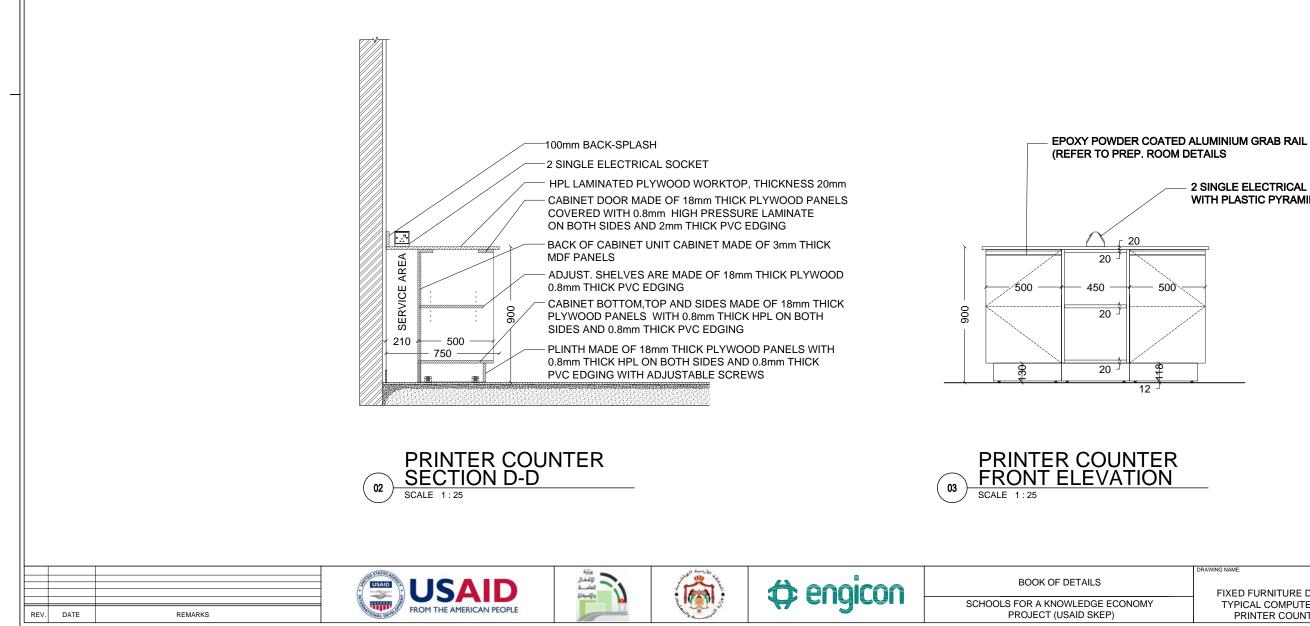

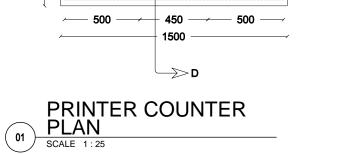

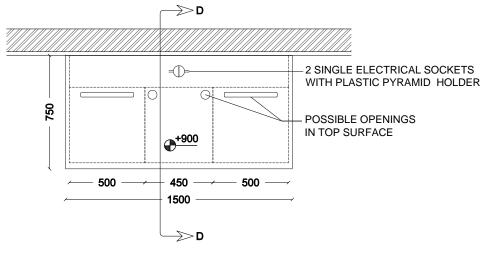

DRAWING NAME:	Design:	Drawn:	REVISION No. :
	H.B.	Engicon	0
FIXED FURNITURE DETAILS	Checked:	Approved:	SHEET NUMBER
	M.Sh.	S.B.	
TYPICAL COMPUTER LAB	Date:	SCALE :	FFD-09
PRINTER COUNTER	June 2020	1:25	

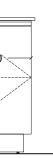

2 SINGLE ELECTRICAL SOCKETS WITH PLASTIC PYRAMID HOLDER


FROM THE AMERICAN PEOPLE	مردد الاختار المناف	<pre>condepart # Condepart # Condepart# # Condepart # Condepart # Condepart # Condepart #</pre>



SCALE 1:50

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SCHOOLS FOR A KNOWLEDGE ECONOMY PROJECT (USAID SKEP)

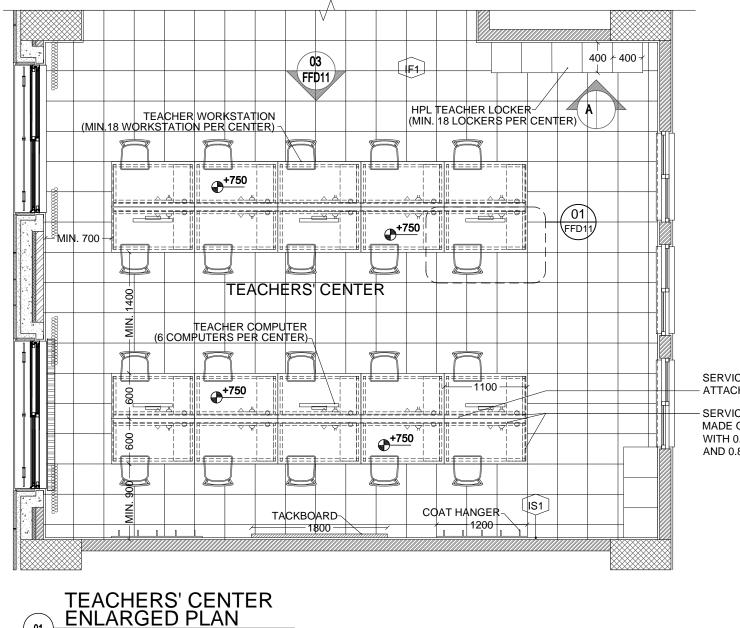

01

REV. DATE


SCALE 1:50

REMARKS

SERVICE AREA ALONG BACK OF ATTACHED DESKS


SERVICE AREA COVER AND SIDE FILLER MADE OF 12mm THK. PLYWOOD PANELS WITH 0.8mm THK. HPL ON BOTH SIDES AND 0.8mm THK PVC EDGING


HPL TEACHER LOCKER (MIN.18 LOCKERS PER CENTER)

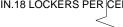

DRAWING NAME:	Design:	Drawn:	REVISION No. :
	H.B.	Engicon	0
FIXED FURNITURE DETAILS	Checked:	Approved:	SHEET NUMBER:
	M.Sh.	S.B.	
TYPICAL TEACHERS' CENTER	Date:	SCALE :	FFD-10
ENLARGED PLAN	June 2020	1:50	-

TEACHERS' CENTER ELEV. A- TEACHERS' LOCKERS

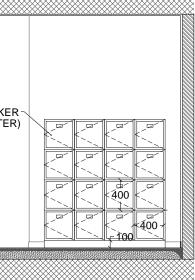

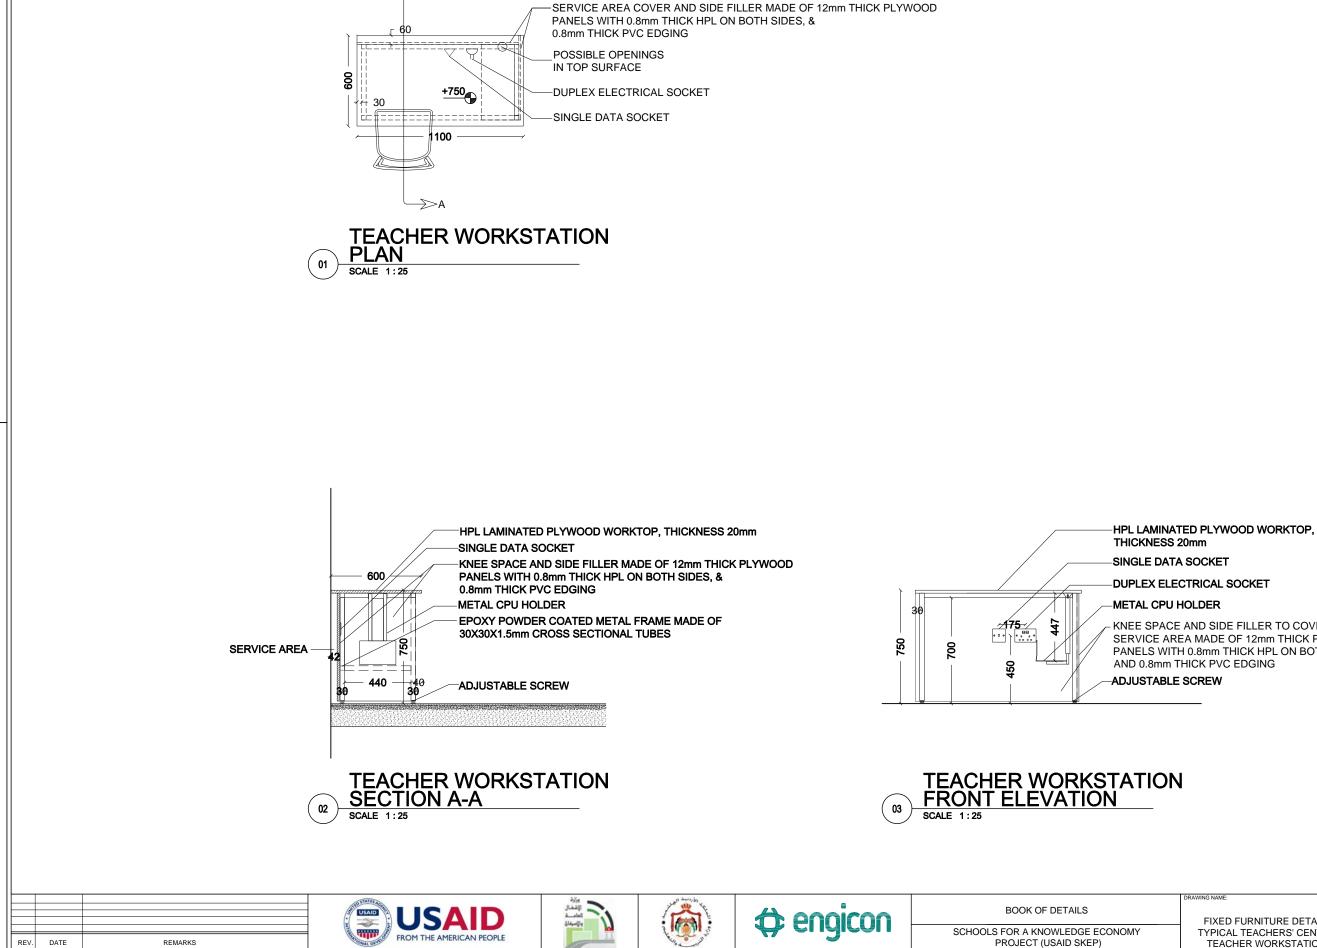


⇒A

DRAWING NAME:	Design:	Drawn:	REVISION No. :
	H.B.	Engicon	0
FIXED FURNITURE DETAILS	Checked:	Approved:	SHEET NUMBER
	M.Sh.	S.B.	
TYPICAL TEACHERS' CENTER	Date:	SCALE :	FFD-11
TEACHER WORKSTATION	June 2020	1:25	

- KNEE SPACE AND SIDE FILLER TO COVER THE NETWORKS SERVICE AREA MADE OF 12mm THICK PLYWOOD PANELS WITH 0.8mm THICK HPL ON BOTH SIDES,

AND 0.8mm THICK PVC EDGING

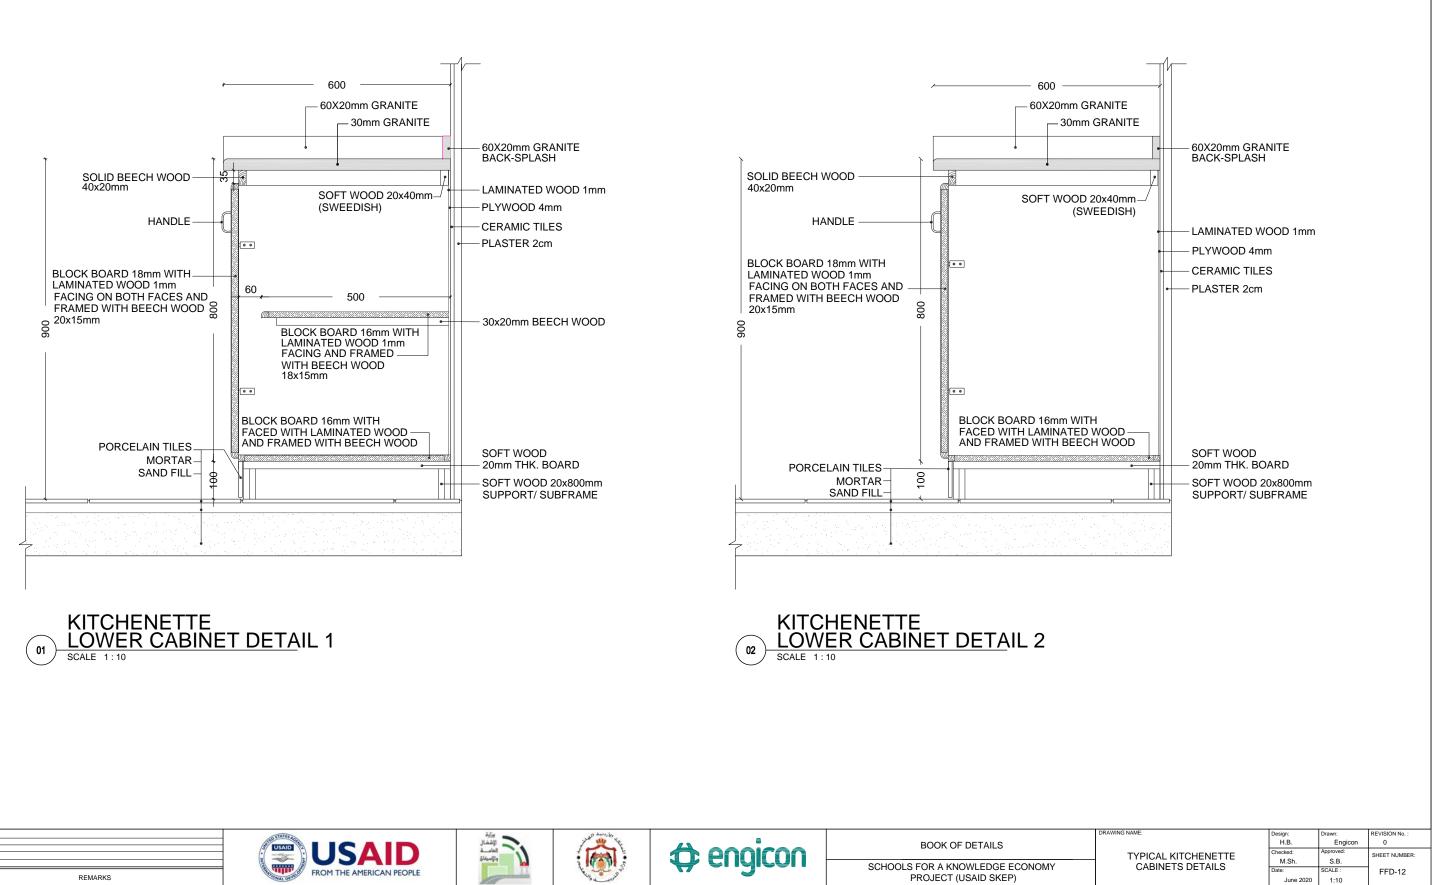










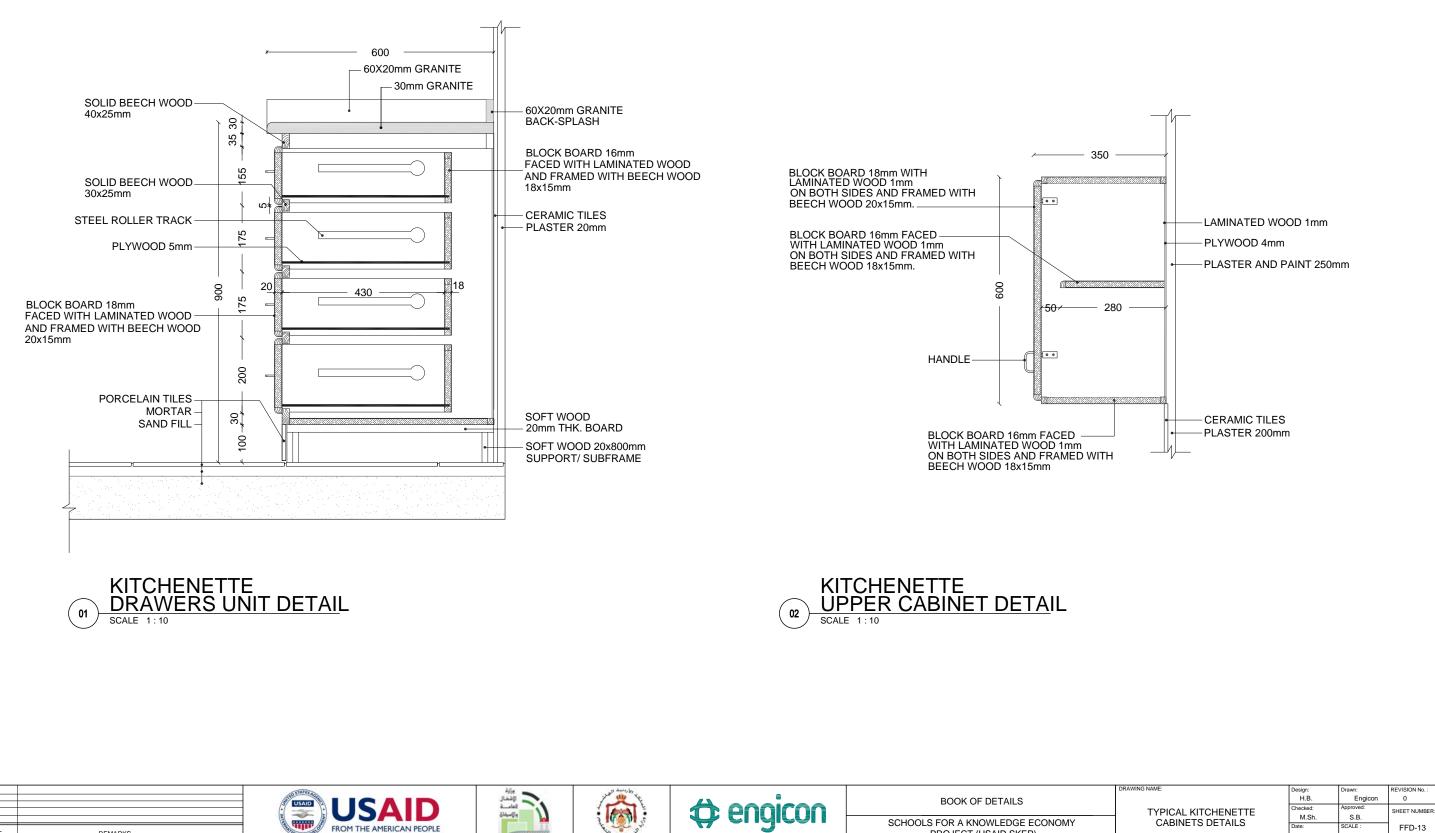


REMARKS

PROJECT (USAID SKEP)

June 2020

1:10

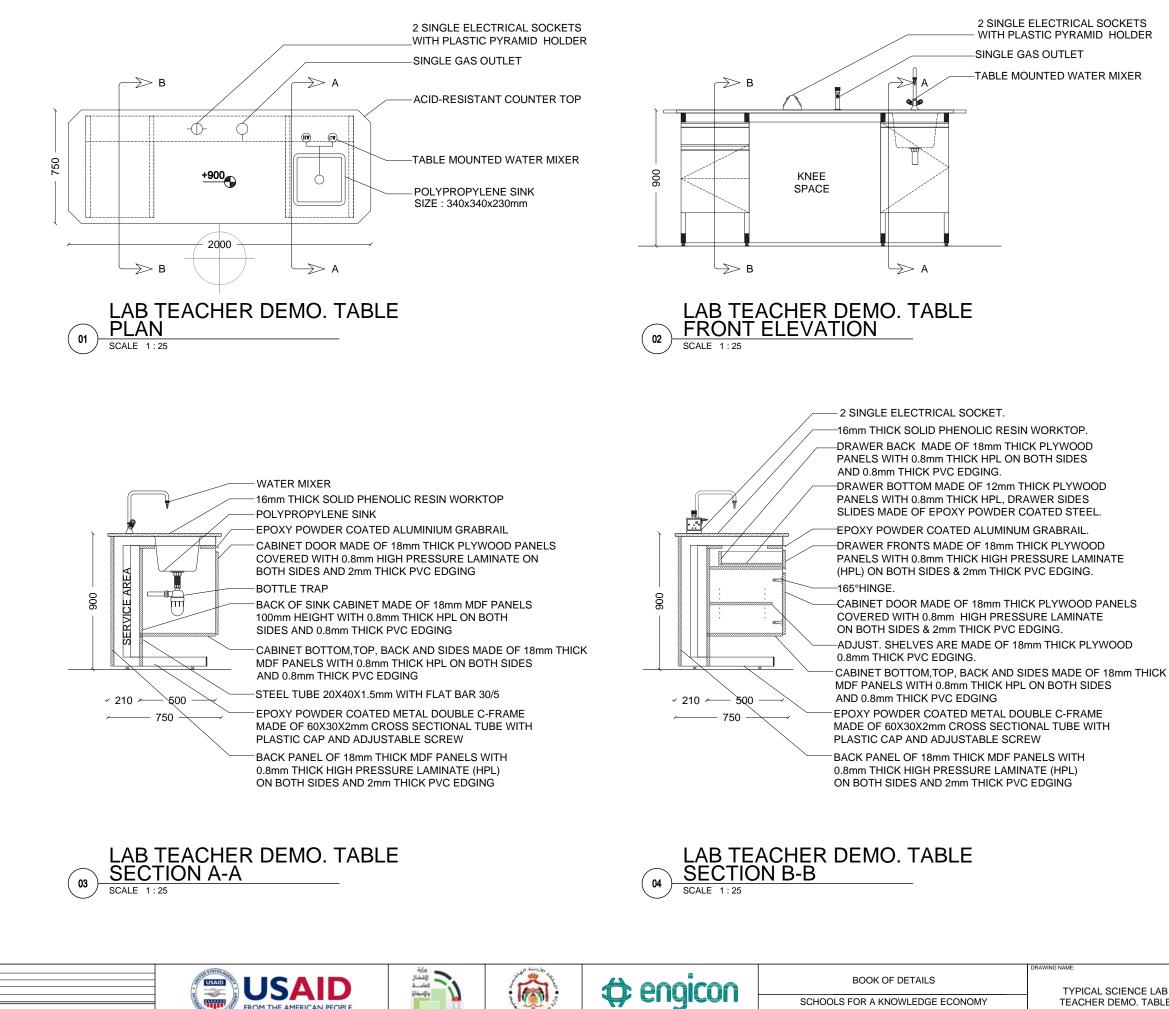

FROM THE AMERICAN PEOPLE

REV. DATE


REMARKS

SCHOOLS FOR A KNOWLEDGE ECONOM
PROJECT (USAID SKEP)


DRAWING NAME:	Design: H.B.	Drawn: Engicon	REVISION No. : 0
TYPICAL SCIENCE LAB	Checked: M.Sh.	Approved: S.B.	SHEET NUMBER:
TEACHER DEMO. TABLE	Date: June 2020	SCALE : 1:25	FFD-14

-TABLE MOUNTED WATER MIXER


2 SINGLE ELECTRICAL SOCKETS WITH PLASTIC PYRAMID HOLDER -SINGLE GAS OUTLET

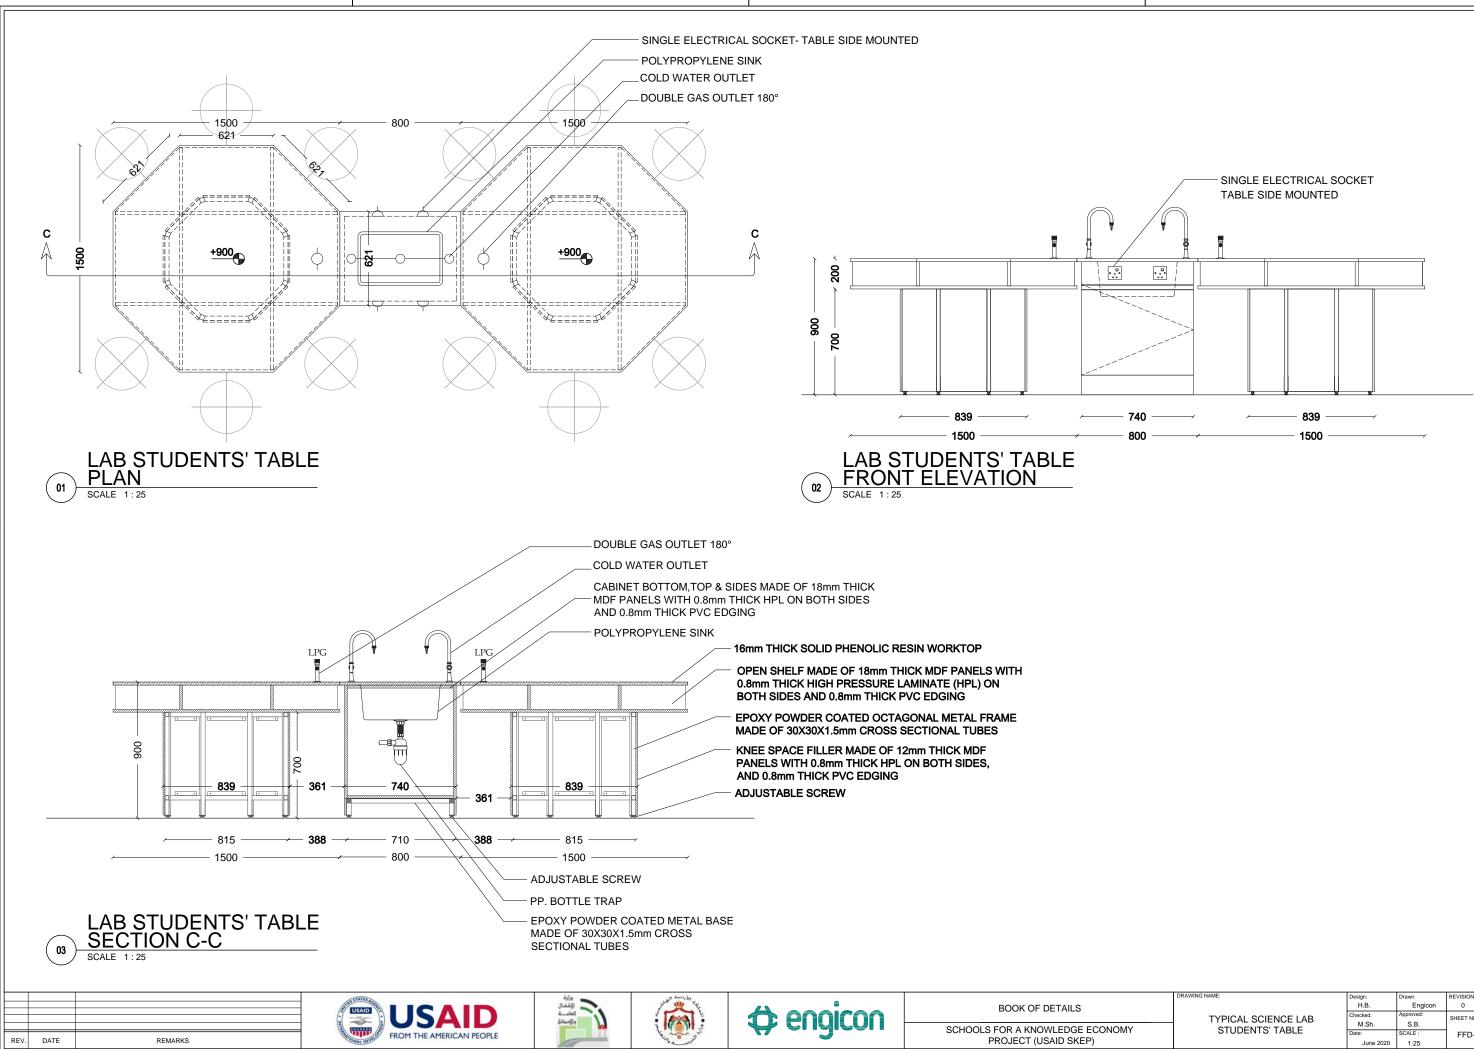


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	H.B.	Engicon	0
TYPICAL SCIENCE LAB	Checked:	Approved:	SHEET NUMBER:
	M.Sh.	S.B.	GHEET HOMBER.
STUDENTS' TABLE	Date:	SCALE :	FFD-15
	June 2020	1:25	

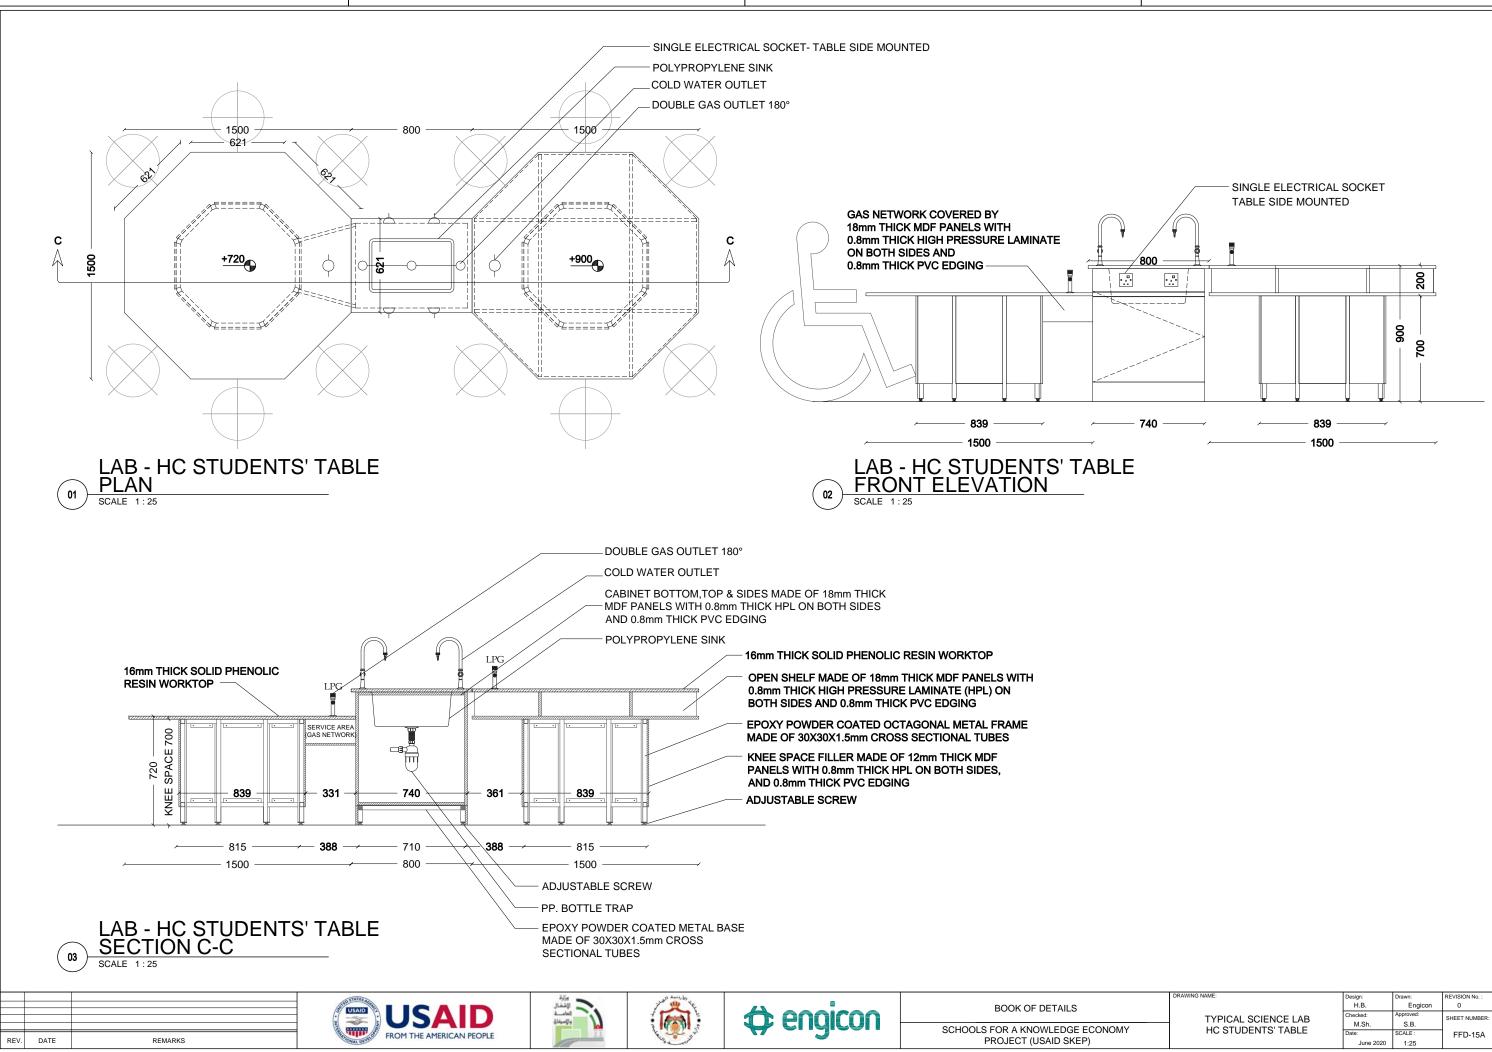

	DRAWING NAME:	Design:	Drawn:	REVISION No. :	
		H.B.	Engicon	0	
	I YPICAL SCIENCE LAB	Checked:	Approved:	SHEET NUMBER:	
		M.Sh.	S.B.		
	HC STUDENTS' TABLE	Date:	SCALE :	FFD-15A	
		June 2020	1:25		

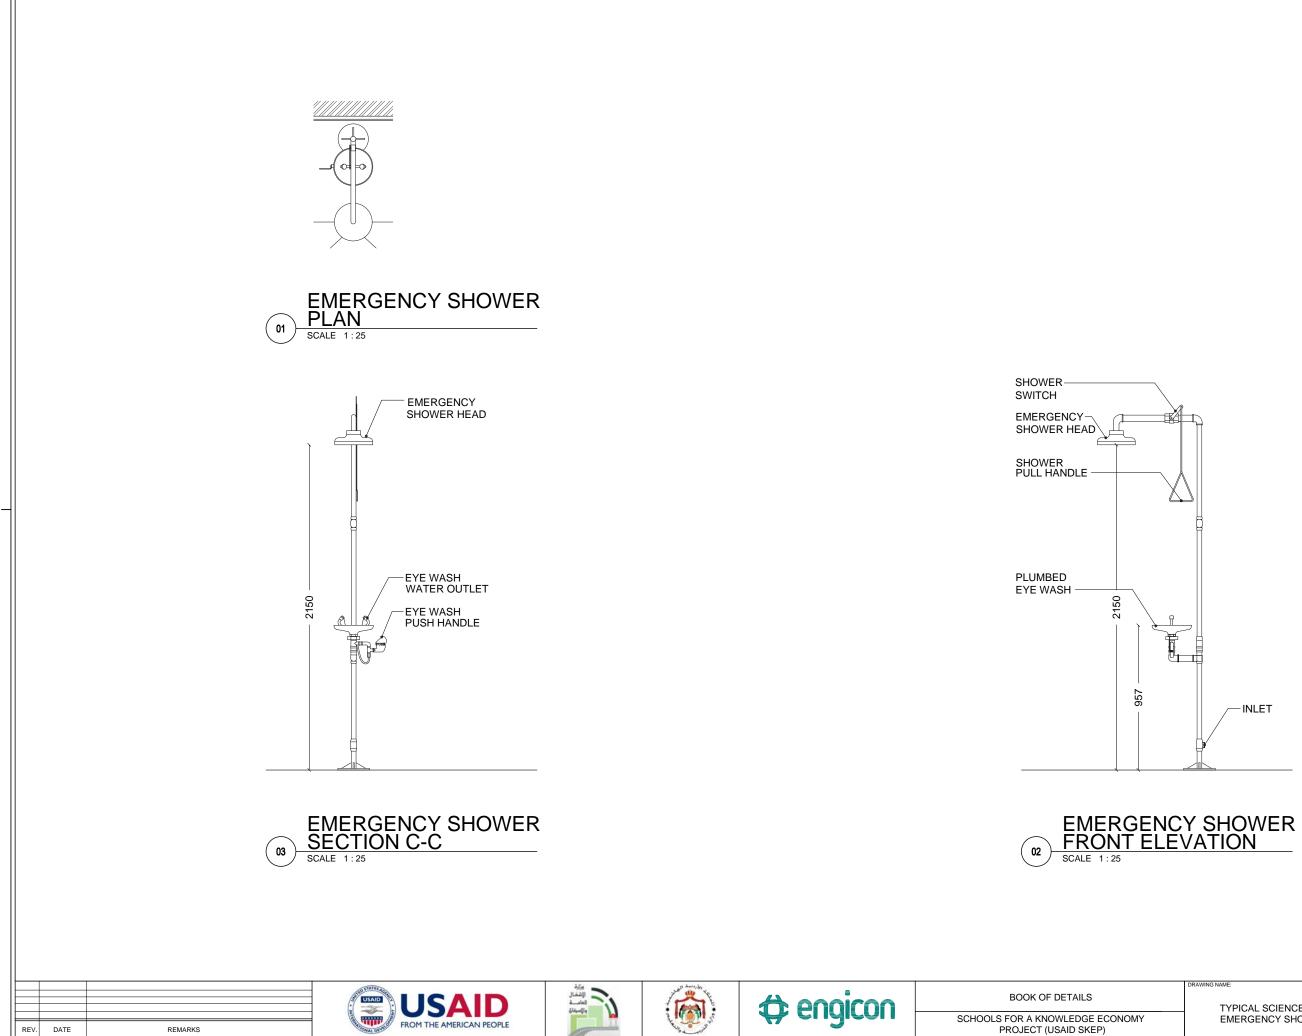


DRAWING NAME:	Design:	Drawn:	REVISION No. :	
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TYPICAL SCIENCE LAB	Checked:	Approved:	SHEET NUMBER	
 	M.Sh.	S.B.	GHEET HOMBER	
EMERGENCY SHOWER	Date:	SCALE :	FFD-16	
	June 2020	1:25		

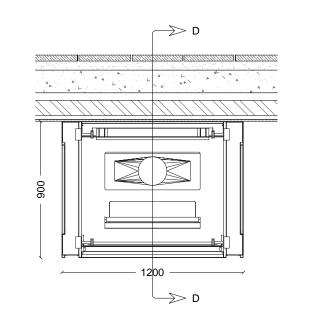




REV. DATE

REMARKS

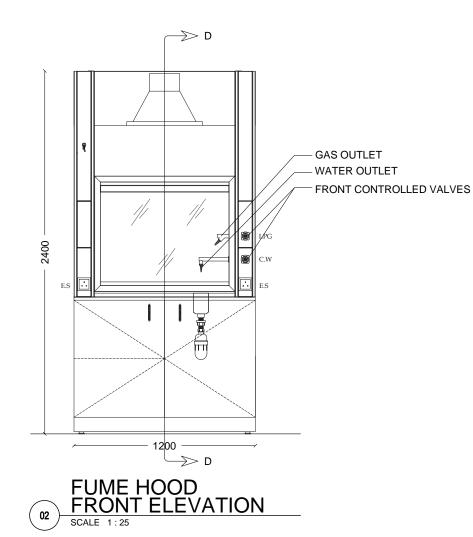


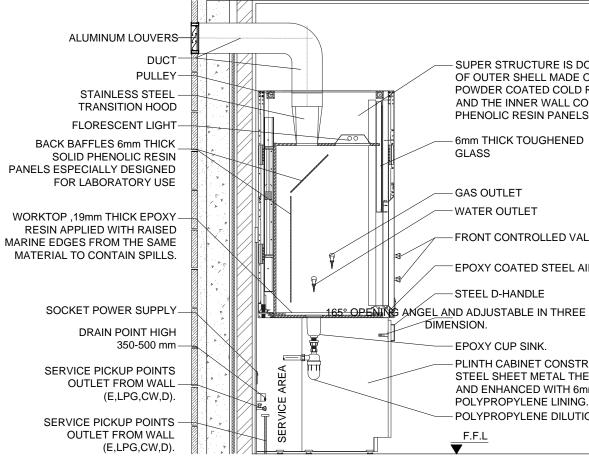







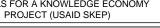

BOOK OF DETAILS

DRAWING NAME:	Design:	Drawn:	REVISION No. :
	H.B.	Engicon	0
TYPICAL SCIENCE LAB	Checked:	Approved:	SHEET NUMBER:
	M.Sh.	S.B.	
FUME HOOD	Date:	SCALE :	FFD-17
	June 2020	1:25	

DRAWING NAME:	Design:	Drawn:	REVISION No. :
	H.B.	Engicon	0
TYPICAL SCIENCE LAB	Checked:	Approved:	SHEET NUMBER:

EPOXY CUP SINK. PLINTH CABINET CONSTRUCTED FROM EPOXY COATED STEEL SHEET METAL THE CABINET IS VENTILATED AND ENHANCED WITH 6mm THICK HIGH QUALITY POLYPROPYLENE LINING. POLYPROPYLENE DILUTION TRAP EPOXY CUP SINK.

STEEL D-HANDLE

- EPOXY COATED STEEL AIR FOIL


-FRONT CONTROLLED VALVES

WATER OUTLET


- GAS OUTLET

6mm THICK TOUGHENED

SUPER STRUCTURE IS DOUBLE WALL CONSISTING OF OUTER SHELL MADE OF HIGH QUALITY EPOXY POWDER COATED COLD ROLLED STEEL SHEET METAL AND THE INNER WALL CONSTRUCTED FROM SOLID PHENOLIC RESIN PANELS.

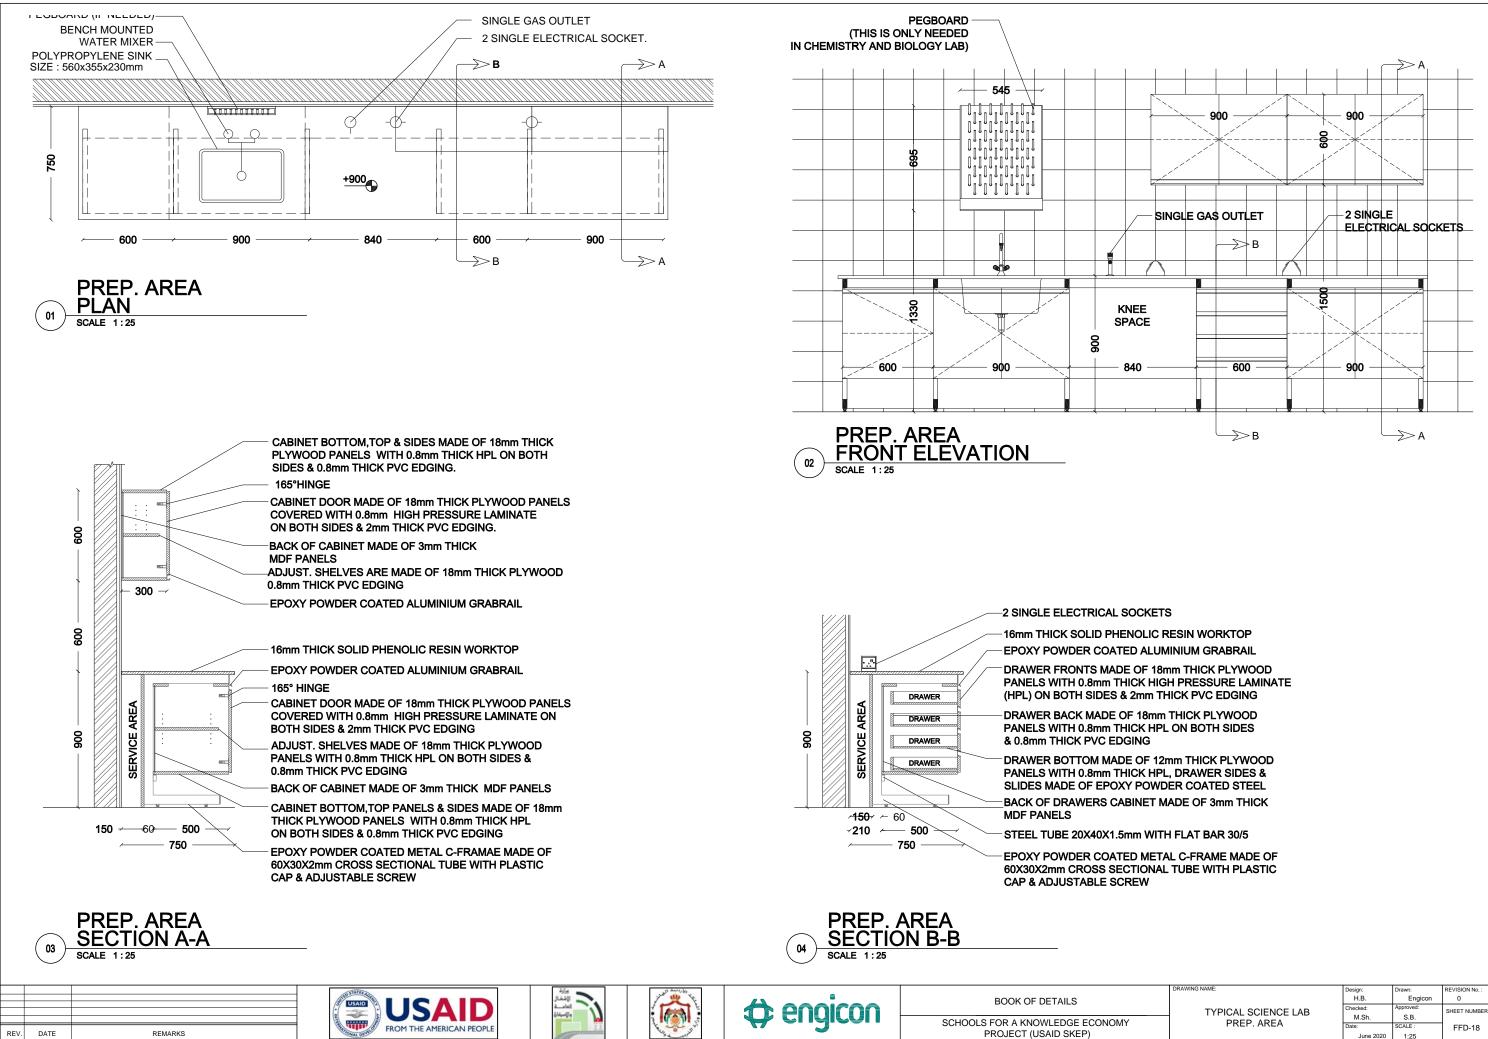

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DRAWING NAME:	Design:	Drawn:	REVISION No. :	l
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TYPICAL SCIENCE LAB	Checked:	Approved:	SHEET NUMBER:	l
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PREP. AREA	Date:	SCALE :	FFD-18	
	June 2020	1:25		

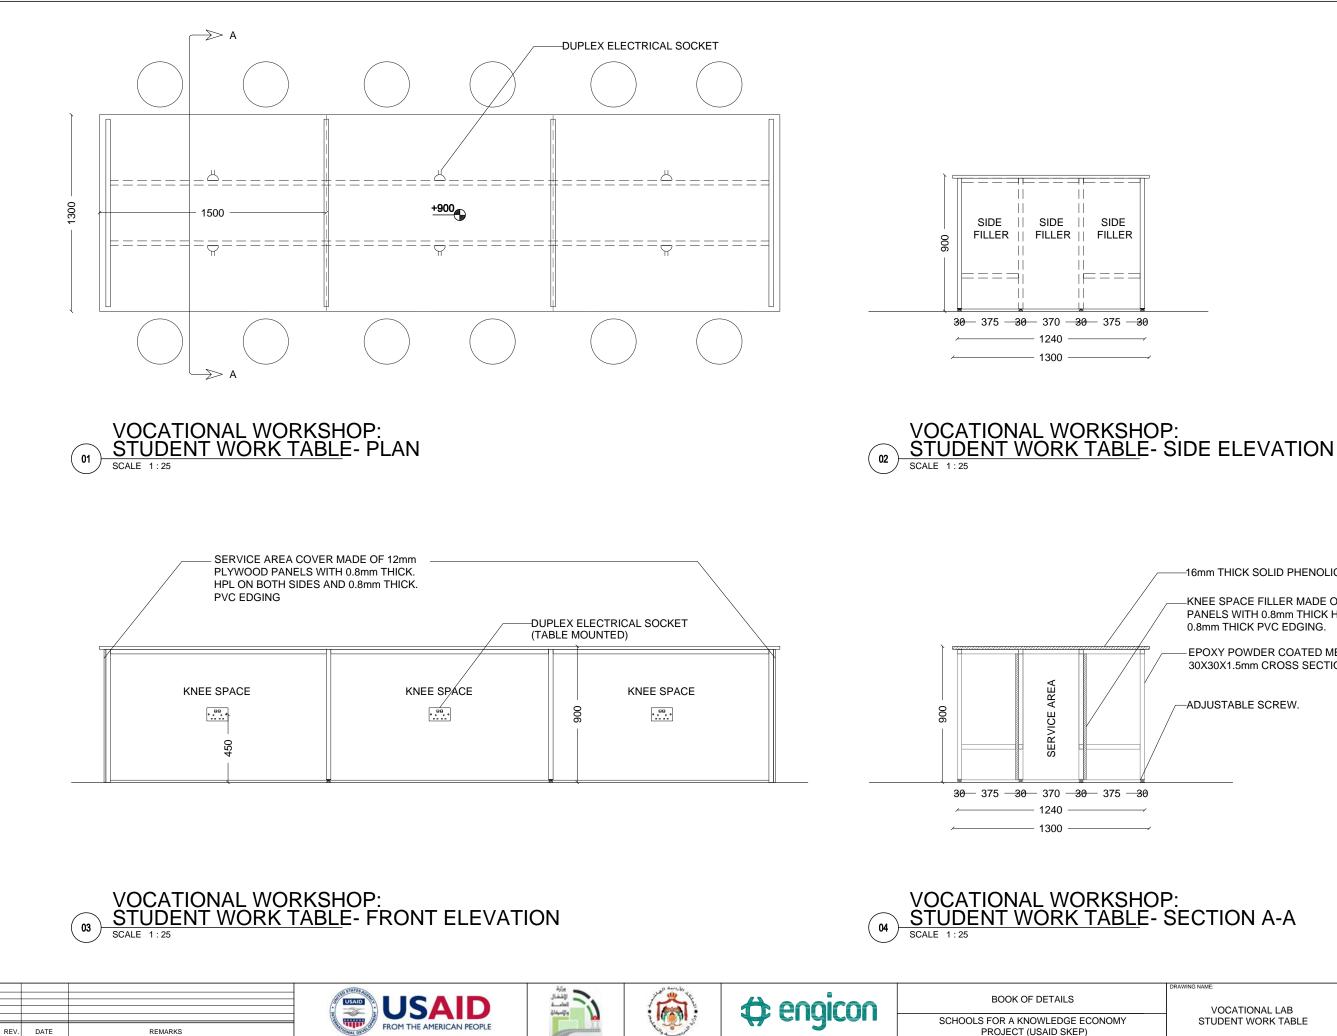

REV. DATE

REMARKS

PROJECT (USAID SKEP)


-16mm THICK SOLID PHENOLIC RESIN WORKTOP.

-KNEE SPACE FILLER MADE OF 12mm THICK PLYWOOD PANELS WITH 0.8mm THICK HPL ON BOTH SIDES, AND 0.8mm THICK PVC EDGING.


- EPOXY POWDER COATED METAL FRAME MADE OF 30X30X1.5mm CROSS SECTIONAL TUBES.

-ADJUSTABLE SCREW.

	DRAWING NAME:	Design:	Drawn:	REVISION No. :
		H.B.	Engicon	0
		Checked: M.Sh.	Approved: S.B.	SHEET NUMBER:
		Date: June 2020	SCALE : 1:25	FFD-19

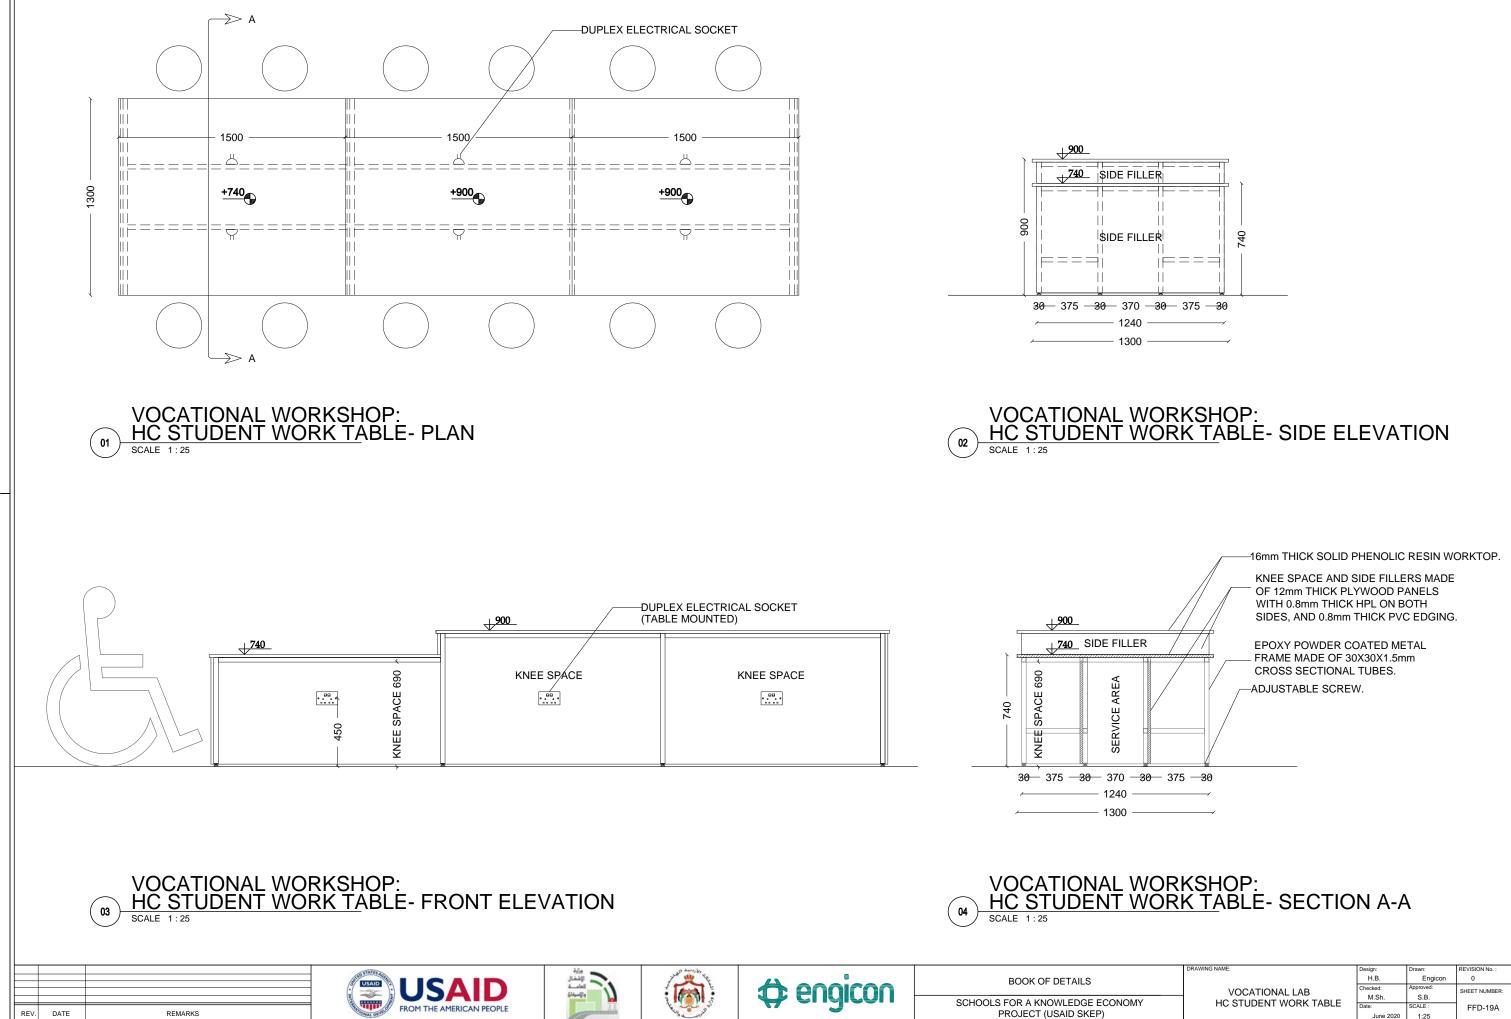


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DRAWING NAME:	Design:	Drawn:	REVISION No. :
	H.B.	Engicon	0
	Checked:	Approved:	SHEET NUMBER:
	M.Sh.	S.B.	
	Date:	SCALE :	FFD-19A
	June 2020	1:25	
	VOCATIONAL LAB	VOCATIONAL LAB HC STUDENT WORK TABLE	VOCATIONAL LAB HC STUDENT WORK TABLE

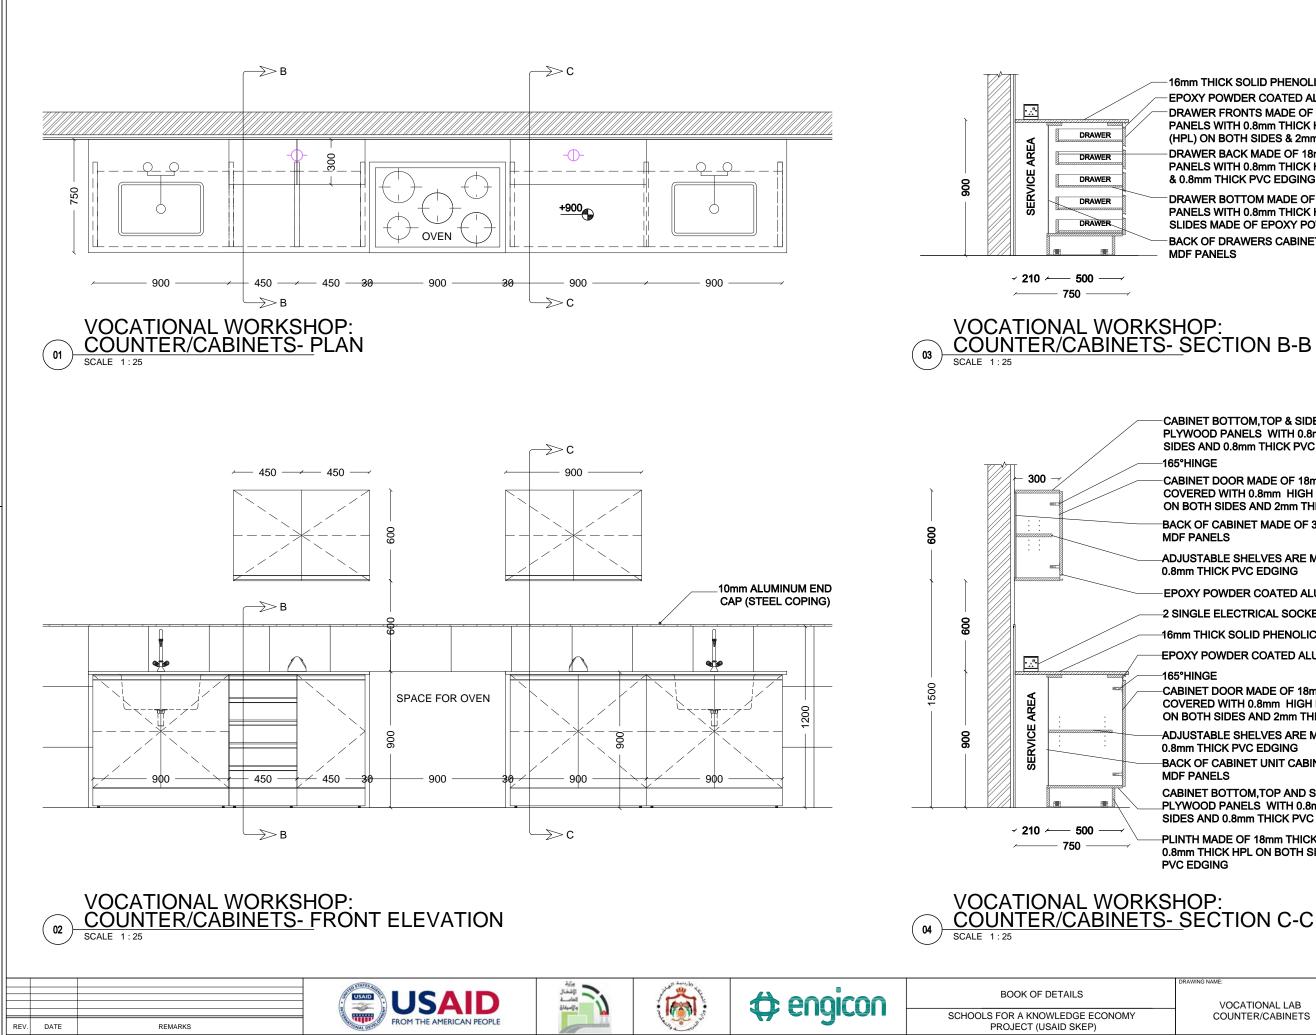


- 16mm THICK SOLID PHENOLIC RESIN WORKTOP EPOXY POWDER COATED ALUMINIUM GRABRAIL DRAWER FRONTS MADE OF 18mm THICK PLYWOOD PANELS WITH 0.8mm THICK HIGH PRESSURE LAMINATE (HPL) ON BOTH SIDES & 2mm THICK PVC EDGING DRAWER BACK MADE OF 18mm THICK PLYWOOD PANELS WITH 0.8mm THICK HPL ON BOTH SIDES & 0.8mm THICK PVC EDGING
- DRAWER BOTTOM MADE OF 12mm THICK PLYWOOD PANELS WITH 0.8mm THICK HPL, DRAWER SIDES & SLIDES MADE OF EPOXY POWDER COATED STEEL BACK OF DRAWERS CABINET MADE OF 3mm THICK
- MDF PANELS


- CABINET BOTTOM, TOP & SIDES MADE OF 18mm THICK PLYWOOD PANELS WITH 0.8mm THICK HPL ON BOTH SIDES AND 0.8mm THICK PVC EDGING.
- 165°HINGE
- CABINET DOOR MADE OF 18mm THICK PLYWOOD PANELS COVERED WITH 0.8mm HIGH PRESSURE LAMINATE ON BOTH SIDES AND 2mm THICK PVC EDGING.
- BACK OF CABINET MADE OF 3mm THICK MDF PANELS
- ADJUSTABLE SHELVES ARE MADE OF 18mm THICK PLYWOOD 0.8mm THICK PVC EDGING
- EPOXY POWDER COATED ALUMINIUM GRABRAIL
- -2 SINGLE ELECTRICAL SOCKET.
- -16mm THICK SOLID PHENOLIC RESIN WORKTOP.
- -EPOXY POWDER COATED ALUMINIUM GRABRAIL
- 165°HINGE
- CABINET DOOR MADE OF 18mm THICK PLYWOOD PANELS COVERED WITH 0.8mm HIGH PRESSURE LAMINATE ON BOTH SIDES AND 2mm THICK PVC EDGING
- ADJUSTABLE SHELVES ARE MADE OF 18mm THICK PLYWOOD 0.8mm THICK PVC EDGING
- BACK OF CABINET UNIT CABINET MADE OF 3mm THICK MDF PANELS
- CABINET BOTTOM, TOP AND SIDES MADE OF 18mm THICK PLYWOOD PANELS WITH 0.8mm THICK HPL ON BOTH SIDES AND 0.8mm THICK PVC EDGING
- PLINTH MADE OF 18mm THICK PLYWOOD PANELS WITH 0.8mm THICK HPL ON BOTH SIDES AND 0.8mm THICK **PVC EDGING**

DRAWING NAME:	Design:	Drawn:	REVISION No. :
	H.B.	Engicon	0
VOCATIONAL LAB	Checked:	Approved:	SHEET NUMBER:
COUNTER/CABINETS	M.Sh.	S.B.	
COUNTER/CADINETS	Date:	SCALE :	FFD-20
	June 2020	1:25	

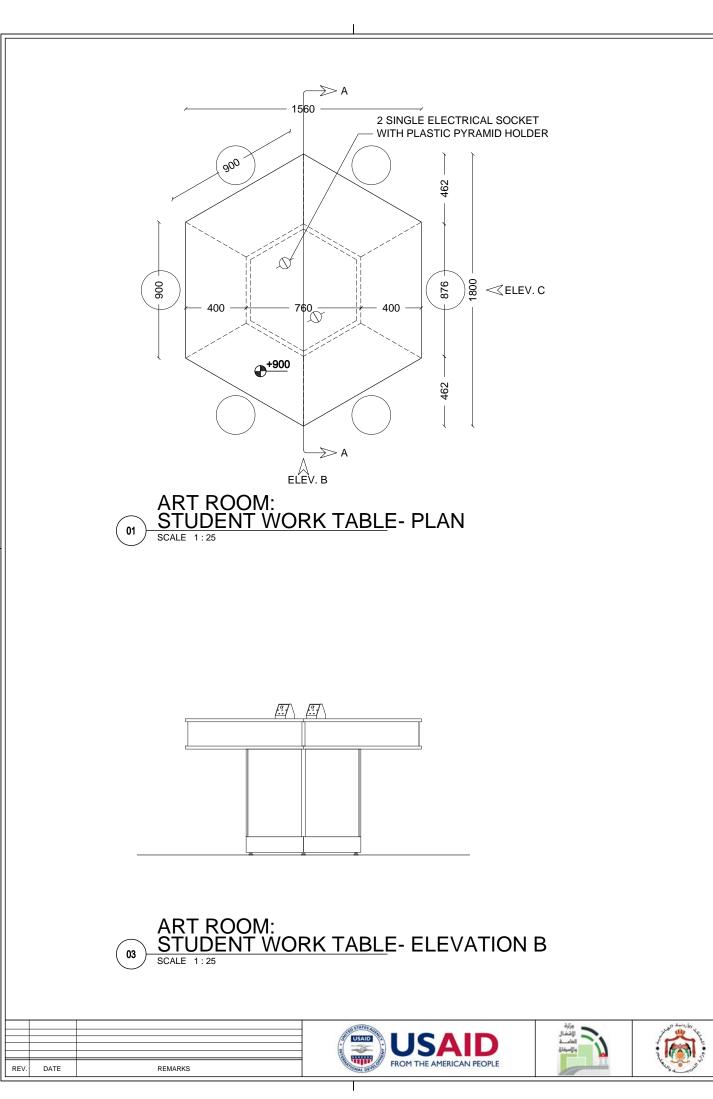

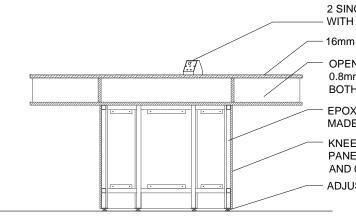



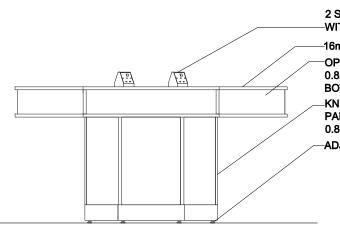



characteristics

BOOK OF DETAILS SCHOOLS FOR A KNOWLEDGE ECONOMY

PROJECT (USAID SKEP)

2 SINGLE ELECTRICAL SOCKET WITH PLASTIC PYRAMID HOLDER

16mm THICK SOLID PHENOLIC RESIN WORKTOP

OPEN SHELF MADE OF 18mm THICK MDF PANELS WITH 0.8mm THICK HIGH PRESSURE LAMINATE (HPL) ON BOTH SIDES AND 0.8mm THICK PVC EDGING


EPOXY POWDER COATED OCTAGONAL METAL FRAME MADE OF 30X30X1.5mm CROSS SECTIONAL TUBES


KNEE SPACE FILLER MADE OF 12mm THICK MDF PANELS WITH 0.8mm THICK HPL ON BOTH SIDES, AND 0.8mm THICK PVC EDGING ADJUSTABLE SCREW

2 SINGLE ELECTRICAL SOCKET WITH PLASTIC PYRAMID HOLDER


-16mm THICK SOLID PHENOLIC RESIN WORKTOP. OPEN SHELF MADE OF 18mm THICK MDF PANELS WITH 0.8mm THICK HIGH PRESSURE LAMINATE (HPL) ON BOTH SIDES AND 0.8mm THICK PVC EDGING KNEE SPACE FILLER MADE OF 12mm THICK PLYWOOD PANELS WITH 0.8mm THICK HPL ON BOTH SIDES, AND 0.8mm THICK PVC EDGING. ADJUSTABLE SCREW.

	DRAWING NAME:	Design:	Drawn:	REVISION No. :
		H.B.	Engicon	0
	TYPICAL ART ROOM	Checked:	Approved:	SHEET NUMBER
_		M.Sh.	S.B.	
	STUDENT WORK TABLE	Date:	SCALE :	FFD-21
		June 2020	1:25	

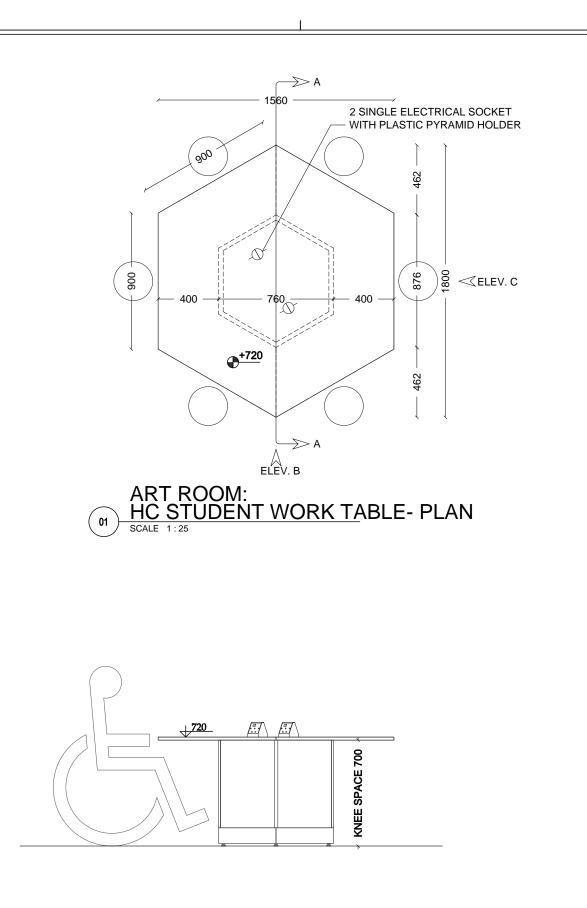

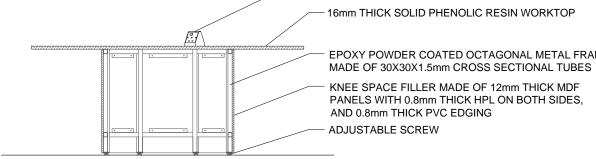



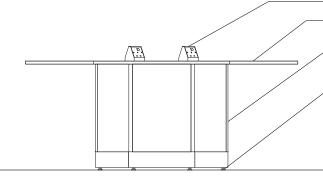







2 SINGLE ELECTRICAL SOCKET WITH PLASTIC PYRAMID HOLDER 16mm THICK SOLID PHENOLIC RESIN WORKTOP


EPOXY POWDER COATED OCTAGONAL METAL FRAME

KNEE SPACE FILLER MADE OF 12mm THICK MDF PANELS WITH 0.8mm THICK HPL ON BOTH SIDES, AND 0.8mm THICK PVC EDGING ADJUSTABLE SCREW

2 SINGLE ELECTRICAL SOCKET WITH PLASTIC PYRAMID HOLDER -16mm THICK SOLID PHENOLIC RESIN WORKTOP.

-KNEE SPACE FILLER MADE OF 12mm THICK PLYWOOD PANELS WITH 0.8mm THICK HPL ON BOTH SIDES, AND 0.8mm THICK PVC EDGING. -ADJUSTABLE SCREW.

DRAWING NAME:	Design:	Drawn:	REVISION No. :
	H.B.	Engicon	0
TYPICAL ART ROOM	Checked:	Approved:	SHEET NUMBER:
	M.Sh.	S.B.	
HC STUDENT WORK TABLE	Date:	SCALE :	FFD-21A
	June 2020	1:25	

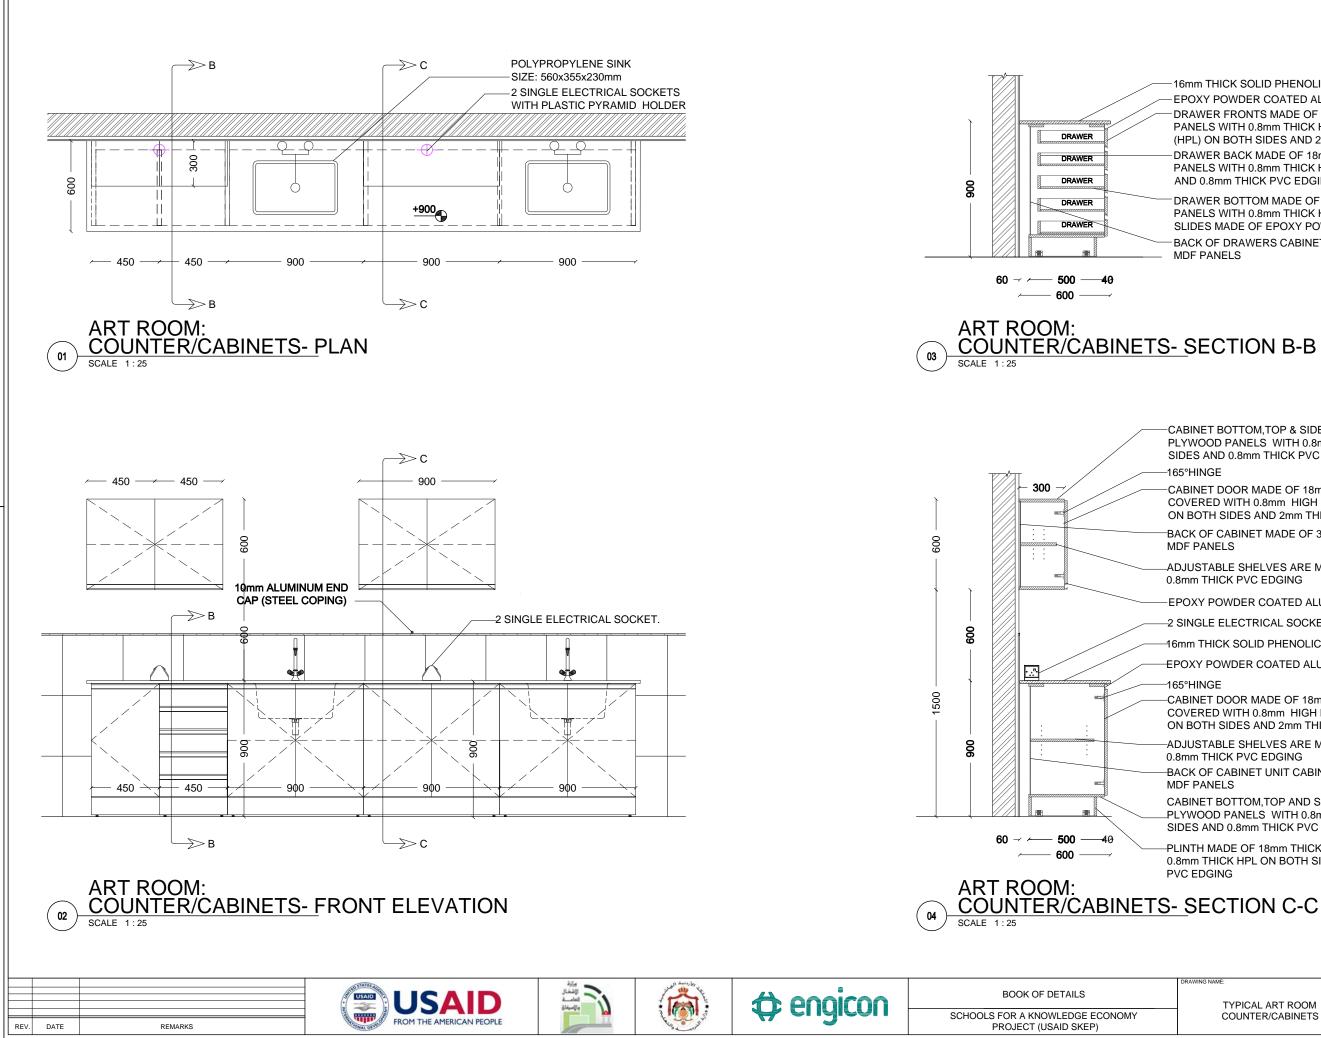



- EPOXY POWDER COATED ALUMINUM GRAB RAIL
DRAWER FRONTS MADE OF 18mm THICK PLYWOOD PANELS WITH 0.8mm THICK HIGH PRESSURE LAMINATE
(HPL) ON BOTH SIDES AND 2mm THICK PVC EDGING
— DRAWER BACK MADE OF 18mm THICK PLYWOOD PANELS WITH 0.8mm THICK HPL ON BOTH SIDES
AND 0.8mm THICK PVC EDGING

DRAWER BOTTOM MADE OF 12mm THICK PLYWOOD PANELS WITH 0.8mm THICK HPL, DRAWER SIDES AND SLIDES MADE OF EPOXY POWDER COATED STEEL BACK OF DRAWERS CABINET MADE OF 3mm THICK MDF PANELS


CABINET BOTTOM, TOP & SIDES M/ PLYWOOD PANELS WITH 0.8mm T SIDES AND 0.8mm THICK PVC EDG	HICK HPL (
—165°HINGE			
—CABINET DOOR MADE OF 18mm TH COVERED WITH 0.8mm HIGH PRES ON BOTH SIDES AND 2mm THICK F	SURE LAN	/INATE	ELS
BACK OF CABINET MADE OF 3mm MDF PANELS	THICK		
—ADJUSTABLE SHELVES ARE MADE 0.8mm THICK PVC EDGING	OF 18mm	THICK PLY	WOOD
	IUM GRAB	RAIL	
-16mm THICK SOLID PHENOLIC RES	IN WORKT	OP.	
	UM GRABF	RAIL	
 —165°HINGE —CABINET DOOR MADE OF 18mm TH COVERED WITH 0.8mm HIGH PRES ON BOTH SIDES AND 2mm THICK P —ADJUSTABLE SHELVES ARE MADE 0.8mm THICK PVC EDGING —BACK OF CABINET UNIT CABINET M MDF PANELS CABINET BOTTOM, TOP AND SIDES —PLYWOOD PANELS WITH 0.8mm TH SIDES AND 0.8mm THICK PVC EDG —PLINTH MADE OF 18mm THICK PLY 0.8mm THICK HPL ON BOTH SIDES PVC EDGING *S- SECTION C-C 	SOURE LAN VC EDGIN OF 18mm MADE OF 3 MADE OF HICK HPL C ING WOOD PAI	VINATE G THICK PLN mm THICK 18mm THI DN BOTH NELS WITH	WOOD CK
DRAWING NAME:	Design: H.B.	Drawn: Engicon	REVISION No. : 0
TYPICAL ART ROOM COUNTER/CABINETS	Checked: M.Sh. Date:	Approved: S.B. SCALE :	SHEET NUMBER: FFD-22
	June 2020	1:25	


SCHOOL COMPONENTS WET AREAS DETAILS

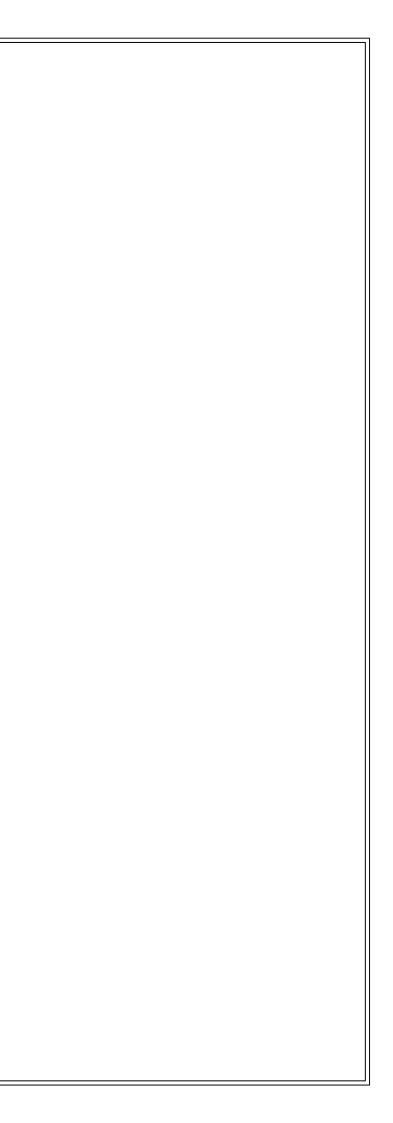

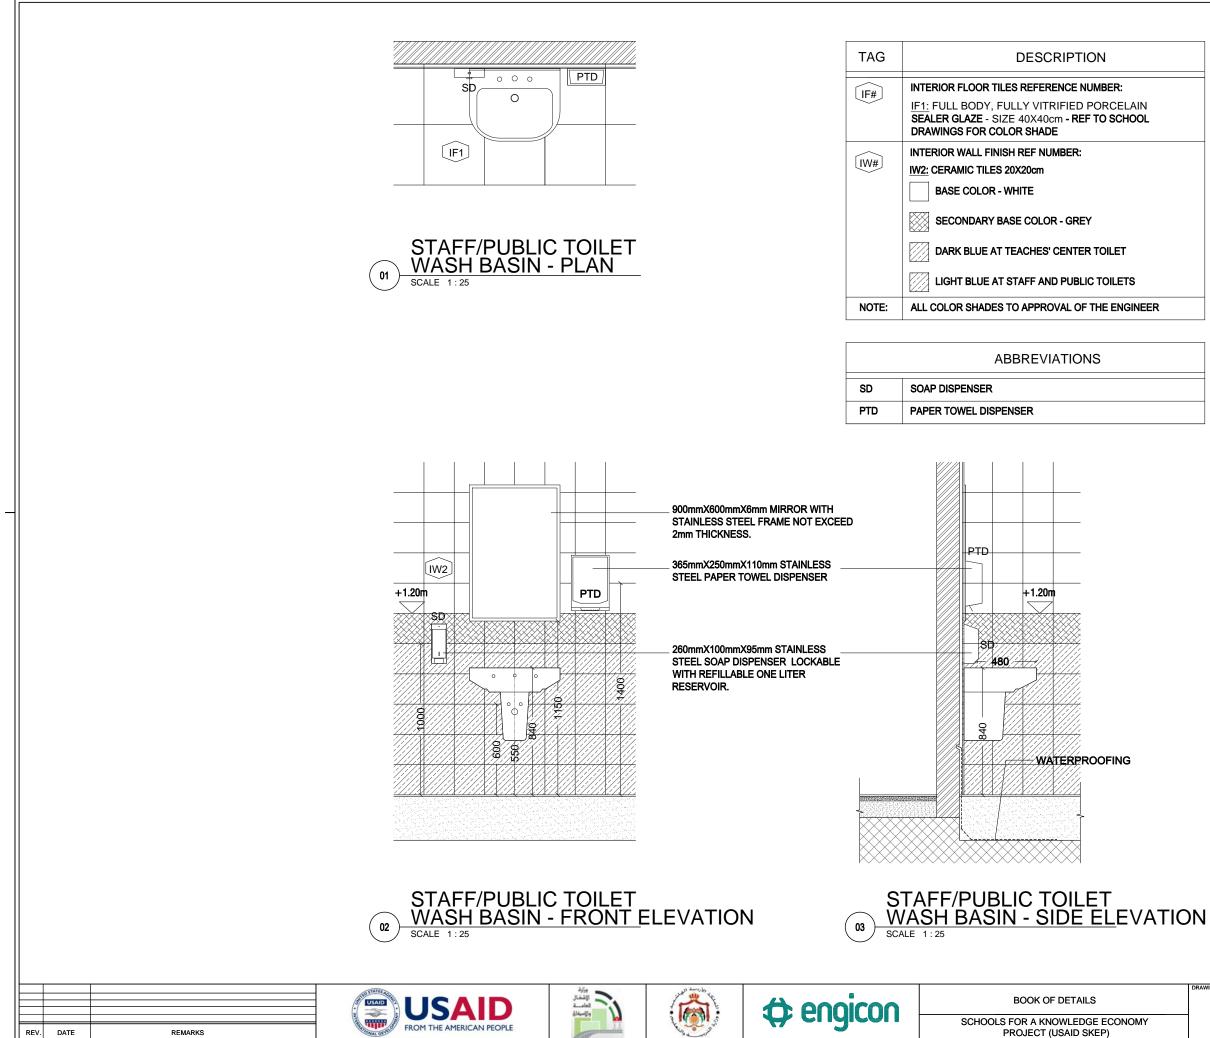

DRAWING NAME:	Design:	Drawn:	REVISION No. :
	H.B.	Engicon	0
STAFF/ PUBLIC TOILETS	Checked:	Approved:	SHEET NUMBER:
	M.Sh.	S.B.	
WASH BASIN DETAILS	Date:	SCALE :	WAD-01
	June 2020	1:25	

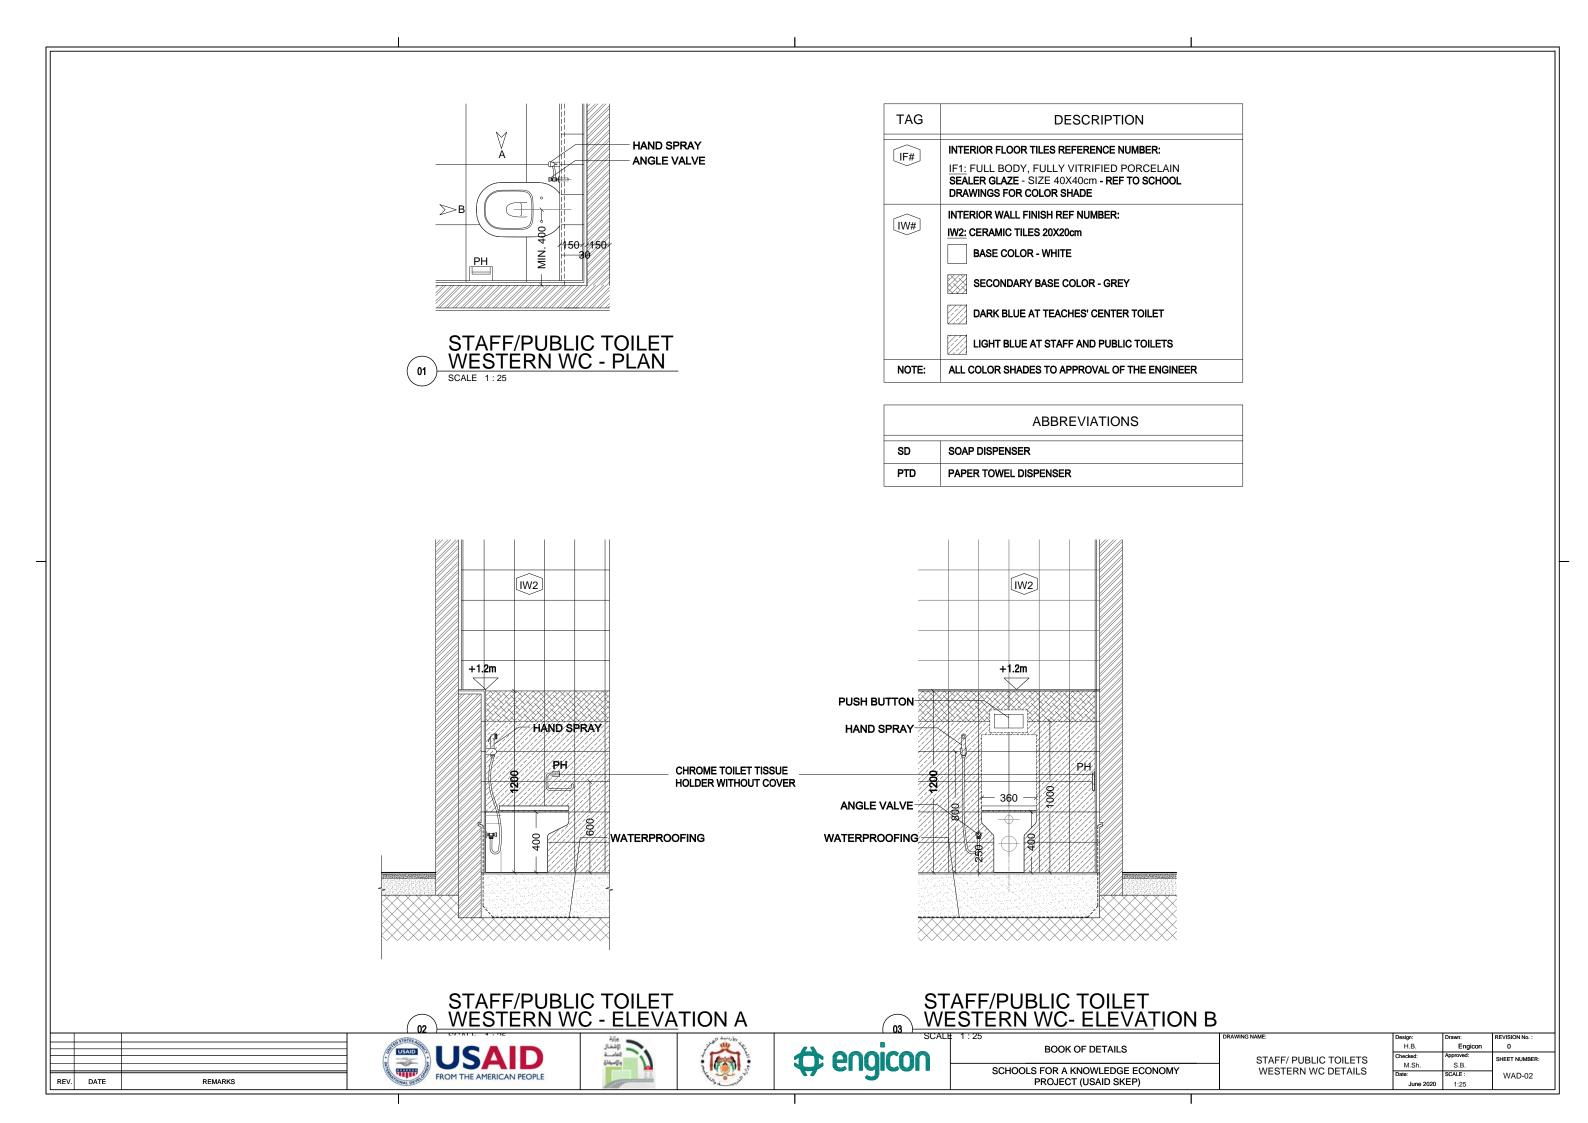

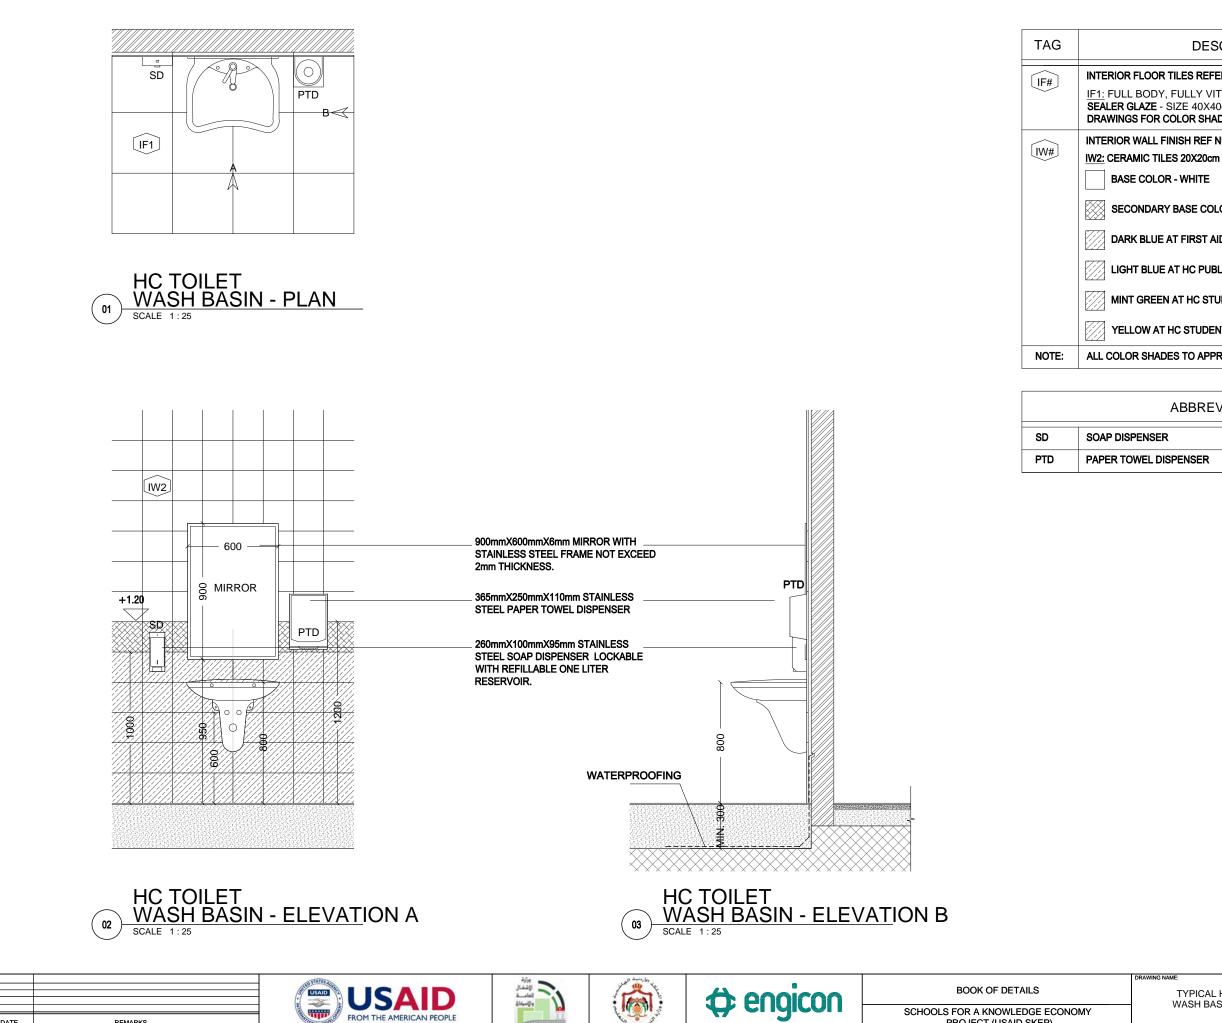

REV. DATE

REMARKS

PROJECT (USAID SKEP)

DESCRIPTION

INTERIOR FLOOR TILES REFERENCE NUMBER:

IF1: FULL BODY, FULLY VITRIFIED PORCELAIN SEALER GLAZE - SIZE 40X40cm - REF TO SCHOOL DRAWINGS FOR COLOR SHADE

INTERIOR WALL FINISH REF NUMBER:

BASE COLOR - WHITE

SECONDARY BASE COLOR - GREY

DARK BLUE AT FIRST AID TOILET

LIGHT BLUE AT HC PUBLIC TOILET

MINT GREEN AT HC STUDENTS' TOILET (GRADES 1-3)

YELLOW AT HC STUDENTS' TOILET (GRADES 4-12)


ALL COLOR SHADES TO APPROVAL OF THE ENGINEER

ABBREVIATIONS

SOAP DISPENSER

PAPER TOWEL DISPENSER

DRAWING NAME:	Design:	Drawn:	REVISION No. :	I
	H.B.	Engicon	0	
TYPICAL HC TOILET	Checked:	Approved:	SHEET NUMBER:	
WASH BASIN DETAILS	M.Sh.	S.B.	ONEET NOMBER	
	Date:	SCALE :	WAD-03	
	June 2020	1:25		I

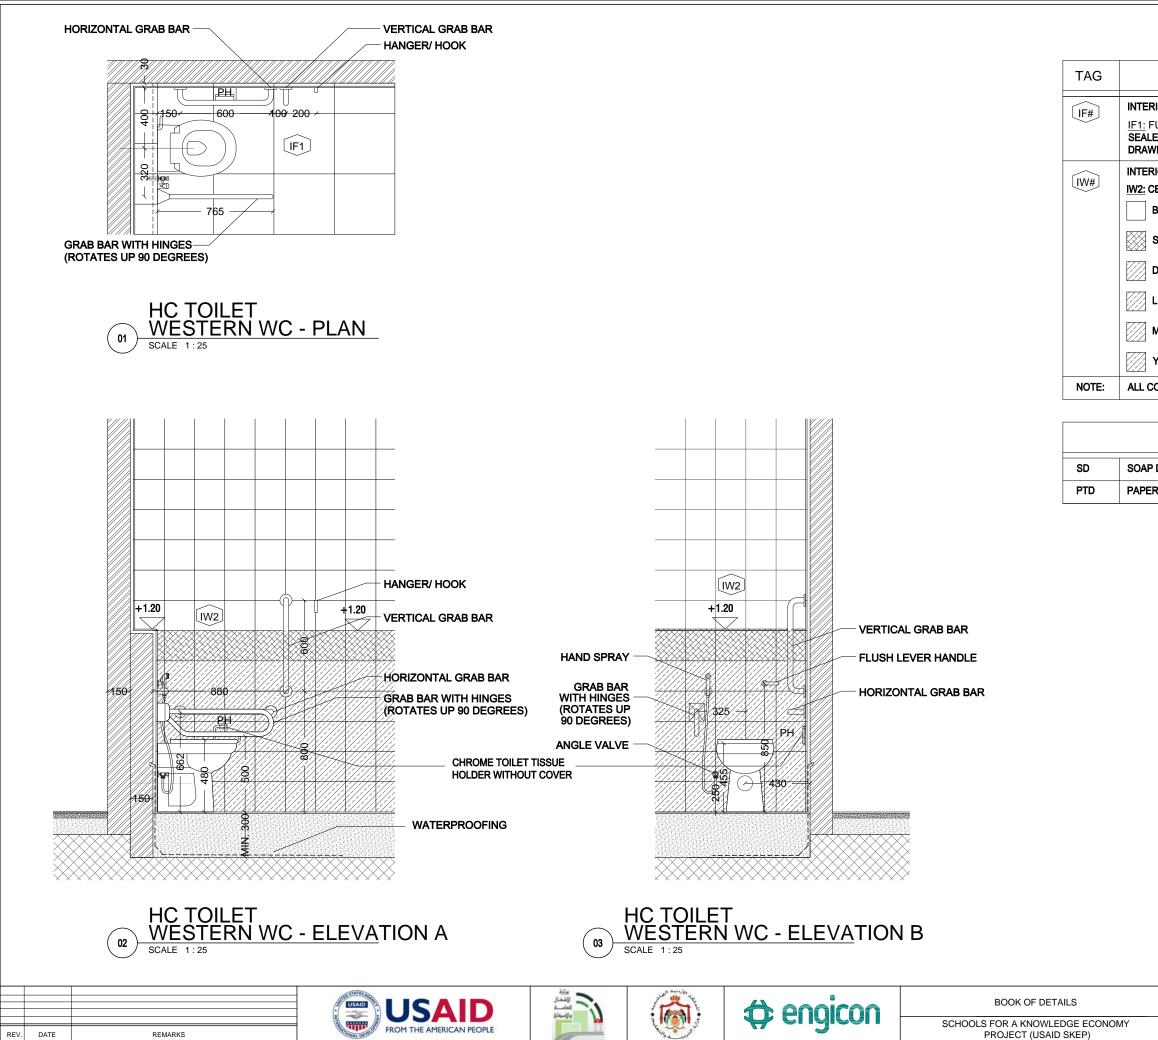

DESCRIPTION

INTERIOR FLOOR TILES REFERENCE NUMBER:

IF1: FULL BODY, FULLY VITRIFIED PORCELAIN SEALER GLAZE - SIZE 40X40cm - REF TO SCHOOL DRAWINGS FOR COLOR SHADE

INTERIOR WALL FINISH REF NUMBER: IW2: CERAMIC TILES 20X20cm

BASE COLOR - WHITE

SECONDARY BASE COLOR - GREY

DARK BLUE AT FIRST AID TOILET

LIGHT BLUE AT HC PUBLIC TOILET

MINT GREEN AT HC STUDENTS' TOILET (GRADES 1-3)

YELLOW AT HC STUDENTS' TOILET (GRADES 4-12)


ALL COLOR SHADES TO APPROVAL OF THE ENGINEER


ABBREVIATIONS

SOAP DISPENSER

PAPER TOWEL DISPENSER


DRAWING NAME:	Design:	Drawn:	REVISION No. :
	H.B.	Engicon	0
TYPICAL HC TOILET	Checked:	Approved:	SHEET NUMBER:
WC DETAILS	M.Sh.	S.B.	GHEET NOMBER.
	Date:	SCALE :	WAD-04
	June 2020	1:25	

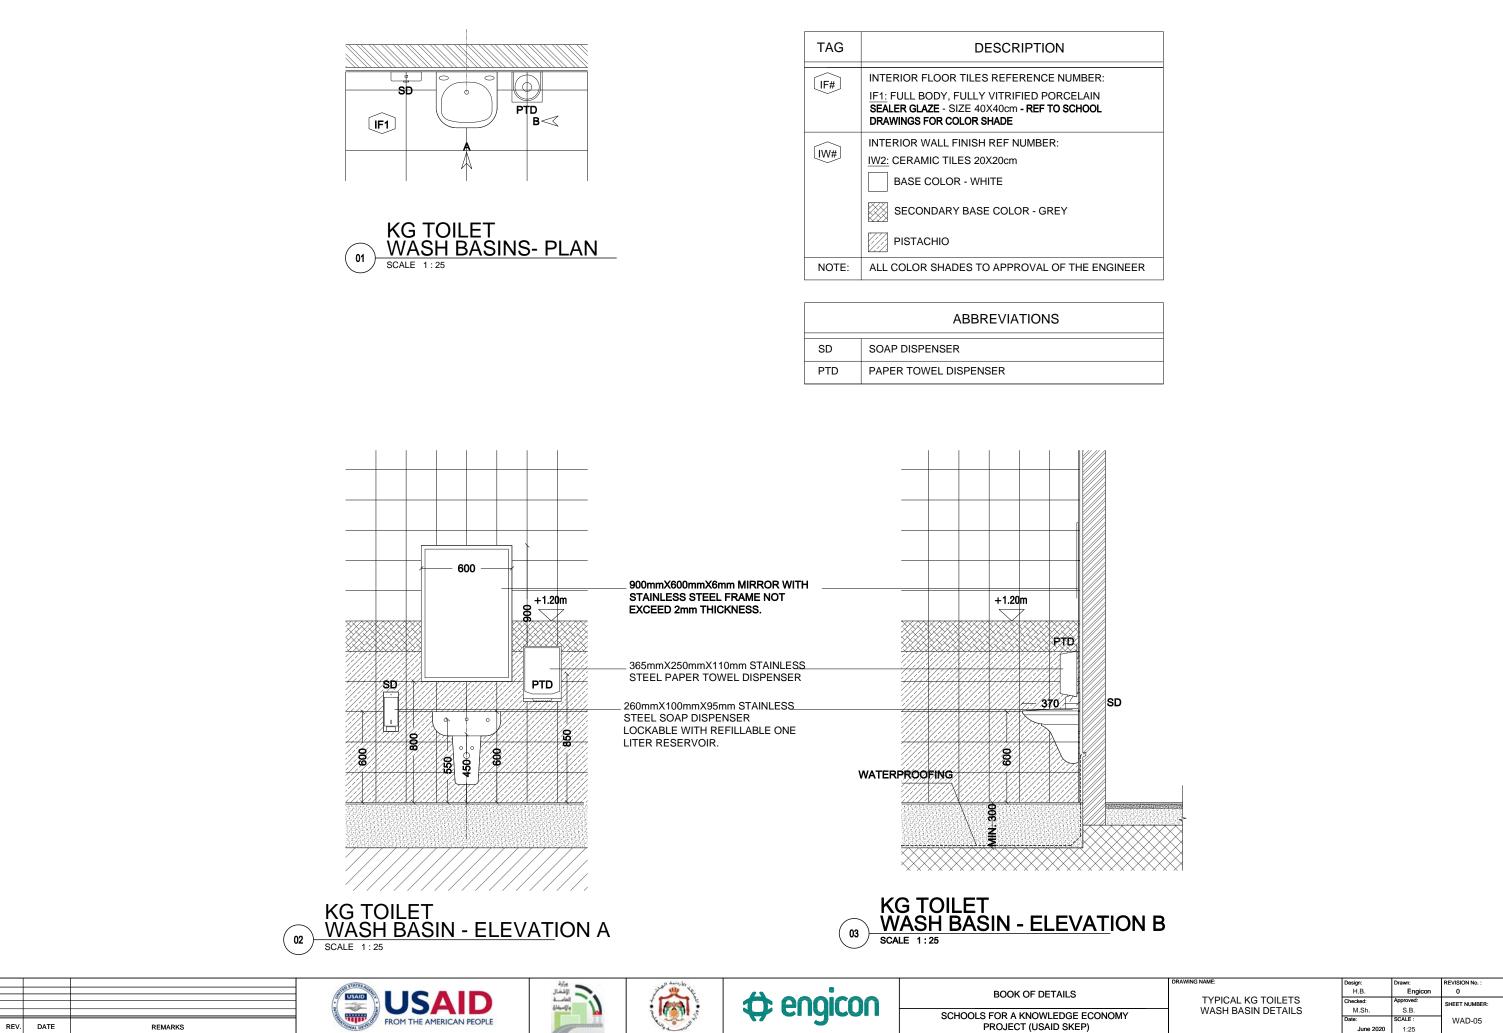

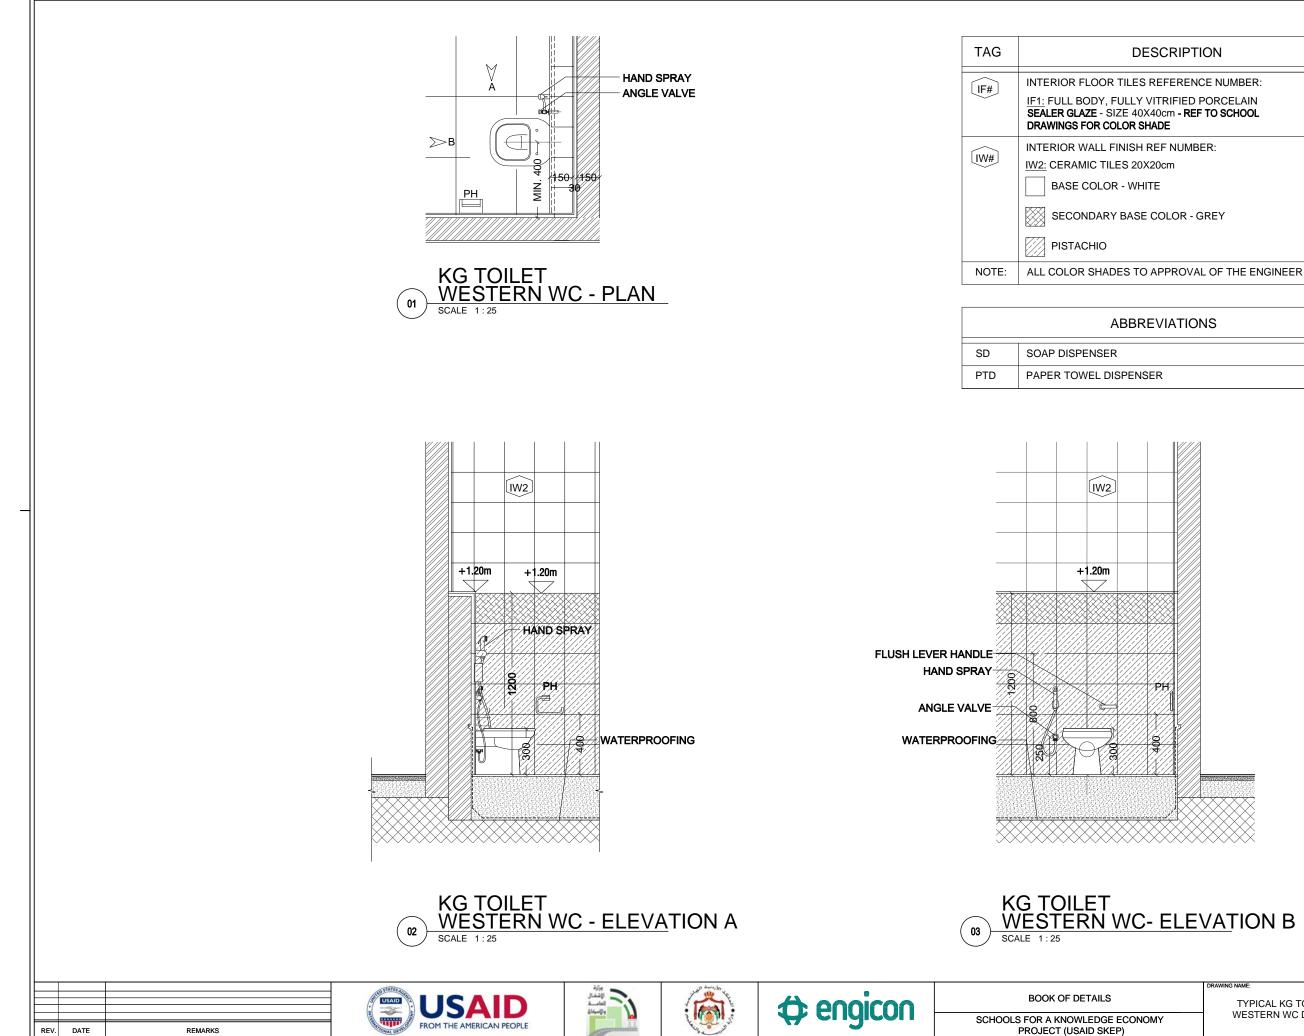


РТ	ION	

DRAWING NAME:	Design:	Drawn:	REVISION No. :
	H.B.	Engicon	0
TYPICAL KG TOILETS	Checked:	Approved:	SHEET NUMBER:
WESTERN WC DETAILS	M.Sh.	S.B.	OTILLT HOMBLIN
	Date:	SCALE :	WAD-06
	June 2020	1:25	

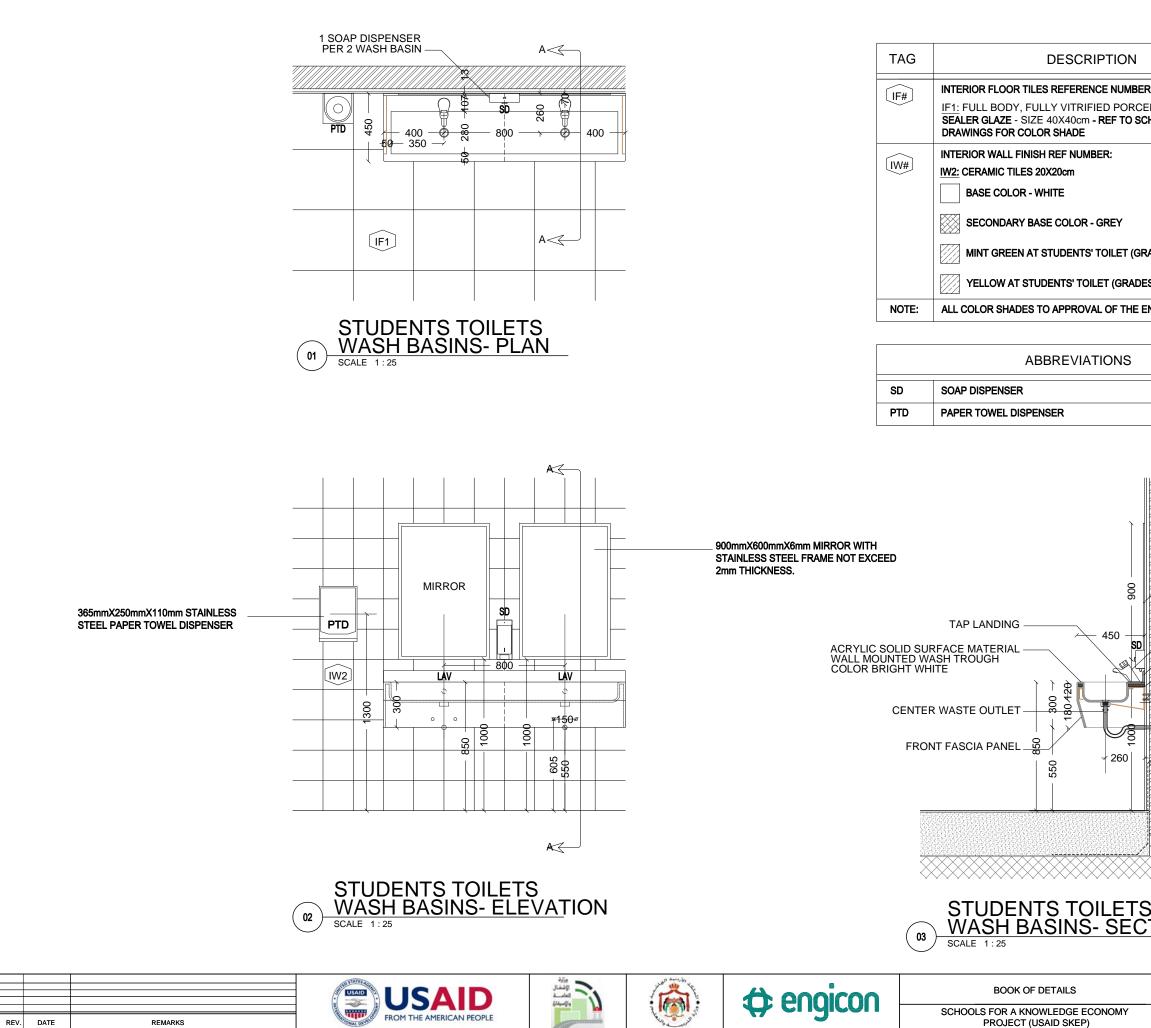

l	
BER: ICELAIN SCHOOL	
GRADES: 1-3)	
DES: 4-12)	
EENGINEER	
Generation MIRROR BASIN MIXER TAP PUSH BOTTOM SELF CLOSING TIMED FLOW -ADJUSTABLE TEMPERTURE CONTR -7.5cm REAR UPSTAND -18mm WATERPROOF PLYWOOD -EXPANSION BOLTS -STEEL WALL MOUNTING BRACKETS	DL
⁻ S <u>CTIO</u> N A-A	


DRAWING NAME:	Design:	Drawn:	REVISION No. :
	H.B.	Engicon	0
TYPICAL STUDENTS' TOILETS	Checked:	Approved:	SHEET NUMBER:
	M.Sh.	S.B.	
WASH BASIN DETAILS	Date:	SCALE :	WAD-07
	June 2020	1:25	

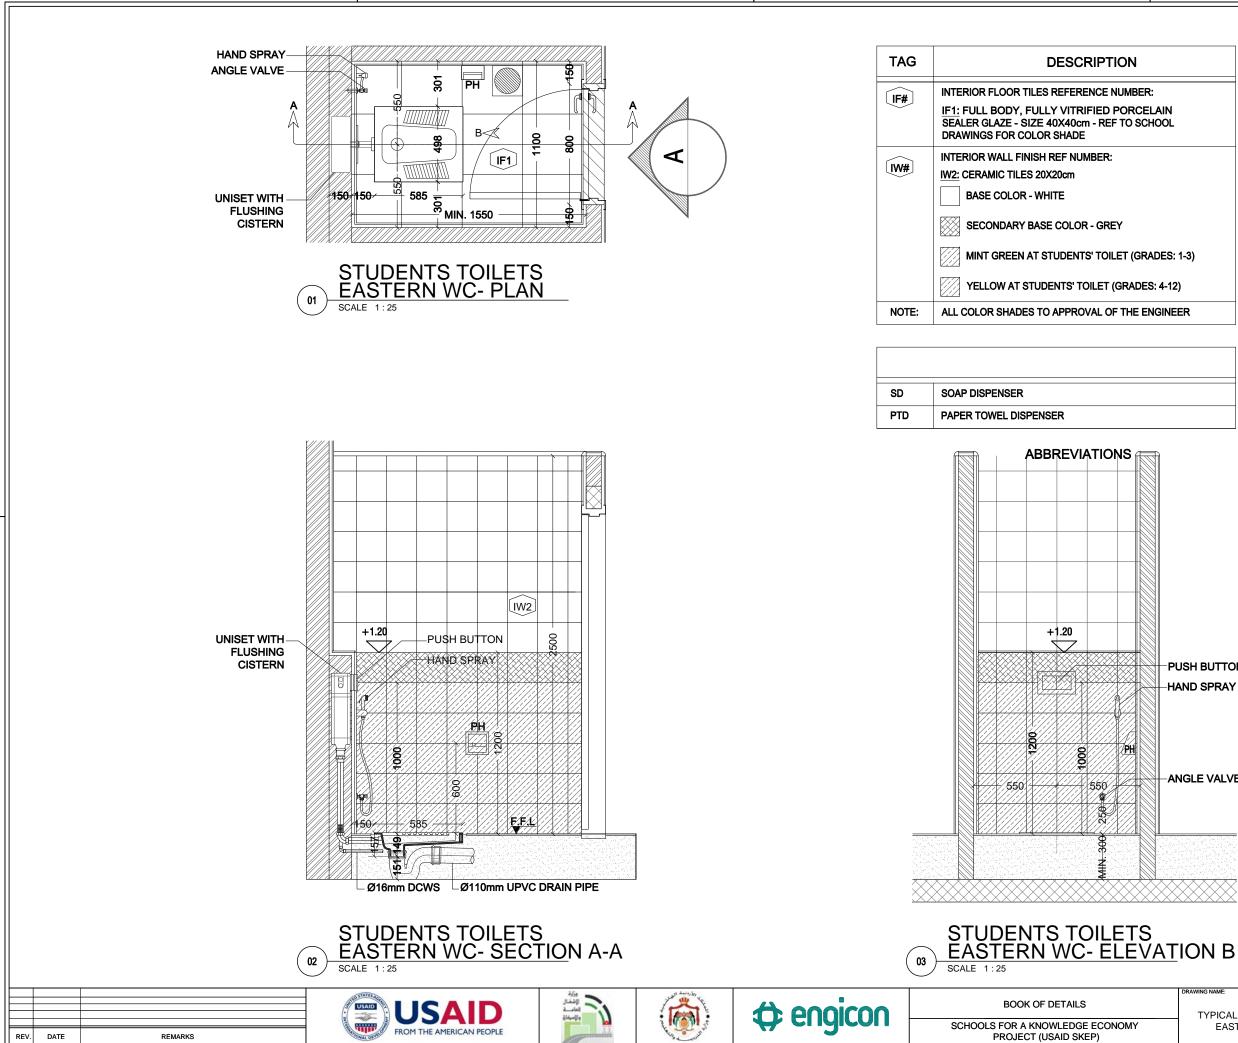


	DRAWING NAME:	Design:	Drawn:	REVISION No. :
		H.B.	Engicon	0
	TYPICAL STUDENTS' TOILETS	Checked:	Approved:	SHEET NUMBER:
		M.Sh.	S.B.	CHEET HOMBER.
		Date:	SCALE :	WAD-08
		June 2020	1:25	

-ANGLE VALVE

PUSH BUTTON -HAND SPRAY

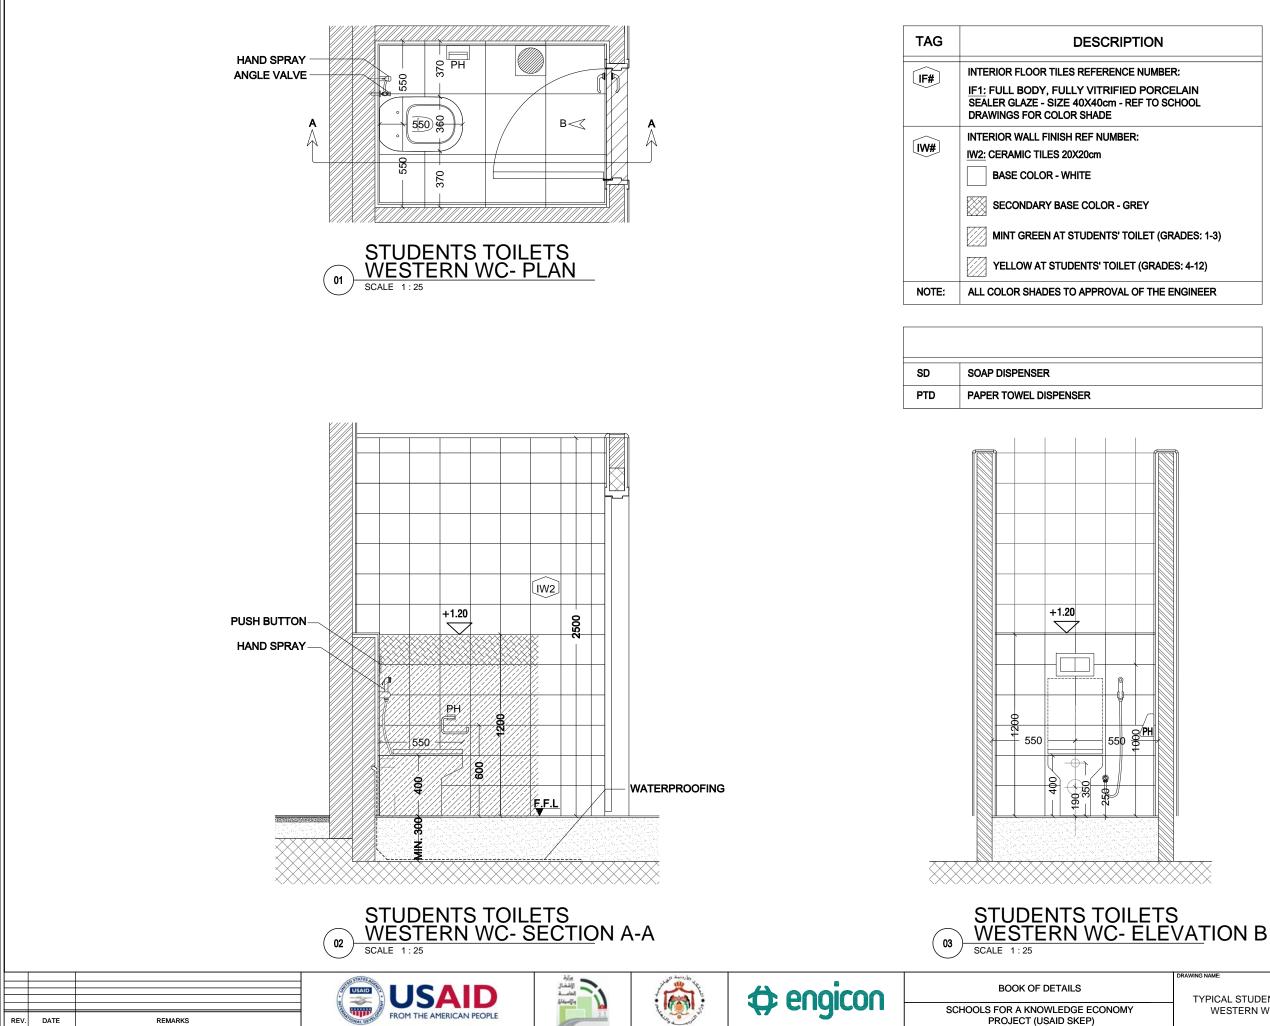

DRAWING NAME:	Design:	Drawn:	REVISION No. :
	H.B.	Engicon	0
TYPICAL STUDENTS' TOILETS	Checked:	Approved:	SHEET NUMBER:
	M.Sh.	S.B.	
WESTERN WC DETAILS	Date:	SCALE :	WAD-09
	June 2020	1:25	

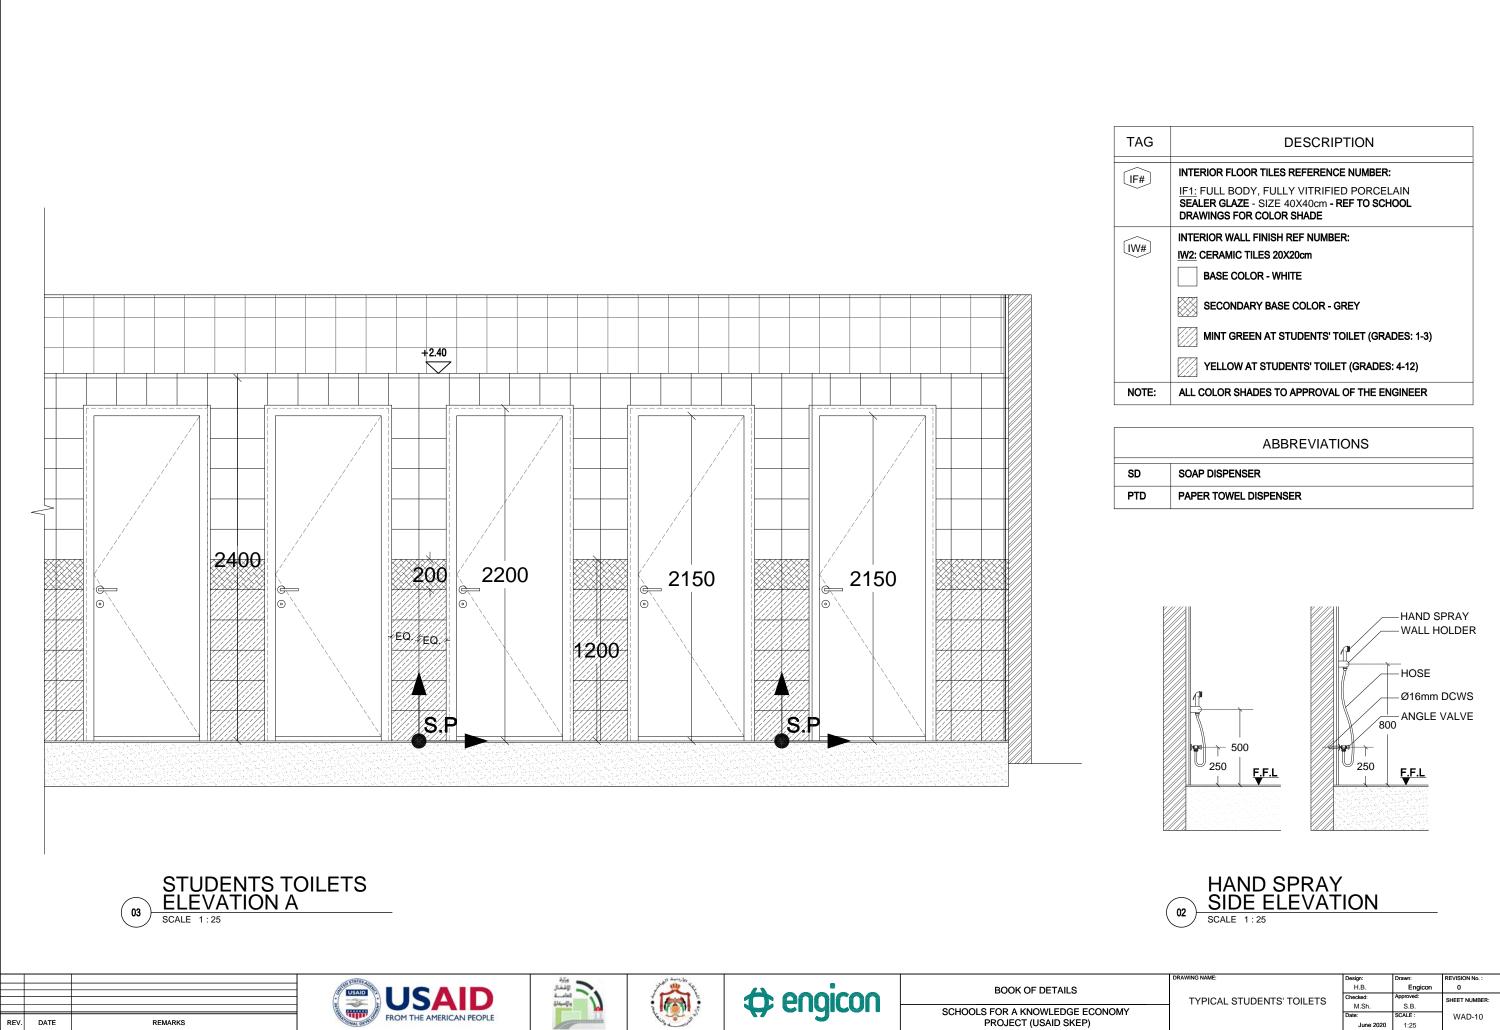

G	DESCRIPTION
]	INTERIOR FLOOR TILES REFERENCE NUMBER: IF1: FULL BODY, FULLY VITRIFIED PORCELAIN SEALER GLAZE - SIZE 40X40cm - REF TO SCHOOL DRAWINGS FOR COLOR SHADE
]	INTERIOR WALL FINISH REF NUMBER: IW2: CERAMIC TILES 20X20cm BASE COLOR - WHITE SECONDARY BASE COLOR - GREY MINT GREEN AT STUDENTS' TOILET (GRADES: 1-3) YELLOW AT STUDENTS' TOILET (GRADES: 4-12)
E:	ALL COLOR SHADES TO APPROVAL OF THE ENGINEER

SOAP DISPENSER
PAPER TOWEL DISPENSER

